Section No.

TOTAL SHEETS = 184

Computer Earthwork Data

Cross Sections

OCTOBER 2025 **STATE OF WISCONSIN** ORDER OF SHEETS **DEPARTMENT OF TRANSPORTATION** Section No. Typical Sections and Details (Includes Erosion Control) Estimate of Quantities Section No. Section No. Miscellaneous Quantities PLAN OF PROPOSED IMPROVEMENT Right of Way Plat Section No. Section No. Section No. Standard Detail Drawings


STATE PROJECT CONTRACT 6999-00-76 WISC 2026010

FEDERAL PROJECT

C WAUSAU, WEST WAUSAU AVENUE


STEVENS DRIVE TO NORTH 10TH AVENUE

LOC STR MARATHON COUNTY

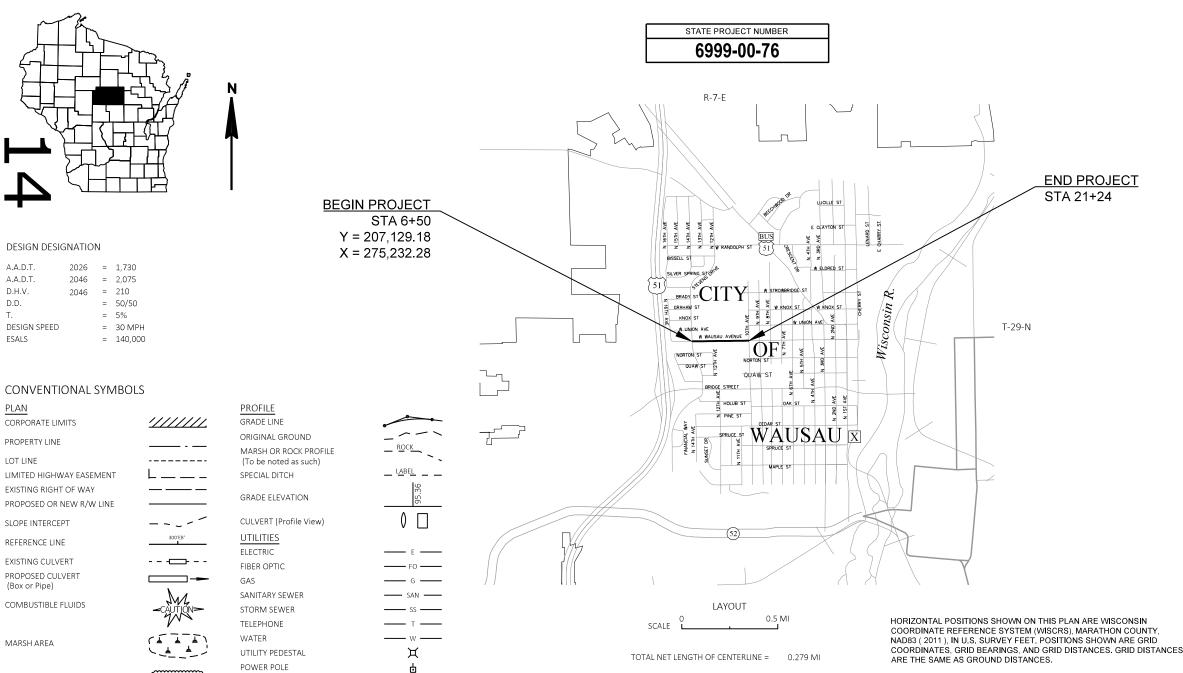

Ø



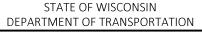

PREPARED BY Surveyor Designer

ATE: 4/22/2025

ELEVATIONS ARE REFERENCED TO NAVD 88 (2012). GPS DERIVED ELEVATIONS ARE BASED ON GEOID 18.

FILE NAME: P:\56XX\5607.DP.23.WAUSAU-AVE.MAR\CADDS\69990076\SHEETS\010101-TI.DWG

TELEPHONE POLE

WOODED OR SHRUB AREA

4/14/2025 2:40 PM

PARKER TISCHAUSER

GENERAL NOTES

THE LOCATIONS OF EXISTING AND PROPOSED UTILITY INSTALLATIONS AS SHOWN ON THE PLANS ARE APPROXIMATE. THERE MAY BE OTHER UTILITY INSTALLATIONS WITHIN THE PROJECT AREA THAT ARE NOT SHOWN.

ORDER OF SECTION 2 DETAIL SHEETS

GENERAL NOTES
PROJECT OVERVIEW
TYPICAL SECTIONS
CONSTRUCTION DETAILS
PAVING DETAILS
CURB RAMP DETAILS
EROSION CONTROL
STORM SEWER
UTILITY PLAN
PERMANENT SIGNING AND MARKING
TRAFFIC CONTROL

RUNOFF COEFFICIENT TABLE

		HYDROLOGIC SOIL GROUP											
			A		В			С			D		
	SLOPE	E RANGE	(PERCENT)	SLC	SLOPE RANGE (PERCENT)			SLOPE RANGE (PERCENT)			SLOPE RANGE (PERCENT)		
LAND USE:	0-2	2-6	6 & OVER										
ROW CROPS	.08 .22	.16 .30	.22 .38	.12 .26	.20 .34	.27 .44	.15 .30	.24 .37	.33 .50	.19 .34	.28 .41	.38 .56	
MEDIAN STRIP- TURF	.19 .24	.20 .26	.24 .30	.19 .25	.22	.26 .33	.20 .26	.23 .30	.30 .37	.20 .27	.25 .32	.30 .40	
SIDE SLOPE- TURF			.25 .32			.27 .34			.28 .36			.30 .38	
PAVEMENT:	•	•					•	•			•		
ASPHALT						.7095							
CONCRETE						.8095							
BRICK						.7080							
DRIVES, WALKS	.7585												
ROOFS						.7595							
GRAVEL ROADS, SHO	DULDERS					.4060							

TOTAL PROJECT AREA = 3.2 ACRES

TOTAL AREA EXPECTED TO BE DISTURBED BY CONSTRUCTION ACTIVITIES = 2.4 ACRES

UTILITIES

COMMUNICATIONS

CITY COUNTY IT COMMISSION STEVE WETTERN 407 GRANT STREET WAUSAU, WI 54403 OFFICE PHONE: (715) 261-6723 STEVE.WETTERN@CO.MARATHON.WI.US

SPECTRUM SCOTT GOHDES 853 MCINTOSH STREET WAUSAU, WI 54403 OFFICE PHONE: (715) 803-2989 MOBILE PHONE: (715) 519-0065 SCOTT.GOHDES@CHARTER.COM

TDS METROCOM LLC ROD LINDEMANN 252 JUNCTION RD MADISON, WI 53717 MOBILE PHONE: (715) 743-5933 RODNEY.LINDEMANN@TDSTELECOM.COM

ELECTRIC - DISTRIBUTION

WISCONSIN PUBLIC SERVICE CORPORATION
JESSE PATTEN
1700 SHERMAN STREET
P.O. BOX 1166
WAUSAU, WI 54402
OFFICE PHONE: (715) 848-7405
MOBILE PHONE: (715) 573-0349
JESSE.PATTEN@WISCONSINPUBLICSERVICE.COM

GAS/PETROLEUM

WISCONSIN PUBLIC SERVICE CORPORATION
TYLER DAHLSTROM
1700 SHERMAN STREET
P.O. BOX 1166
WAUSAU, WI 54402
OFFICE PHONE: (715) 848-7387
MOBILE PHONE: (715) 432-9212
TYLER.DAHLSTROM@WISCONSINPUBLICSERVICE.COM

SEWER

WAUSAU WATER WORKS RYAN DWELLY 407 GRANT STREET WAUSAU, WI 54403 OFFICE PHONE: (715) 261-6948 MOBILE PHONE: (715) 574-3149 RYAN.DWELLY@CI.WAUSAU.WI.US

WATER

WAUSAU WATER WORKS
SHANNON LANE
407 GRANT STREET
WAUSAU, WI 55403
OFFICE PHONE: (715) 261-7281
MOBILE PHONE: (715) 571-9774
SHANNON.LANE@CI.WAUSAU.WI.US



OTHER CONTACTS

DESIGNER CONTACT

EMCS, INC. 500 NORTH 17TH AVENUE WAUSAU, WI 54401 OFFICE: (715) 845-1081

WISDOT DESIGN PROJECT MANAGER

MIKE GRAGE WISDOT NCR 510 HANSON LAKE RD RHINELANDER, WI 54501 (715) 845-1081

MICHAEL.GRAGE@DOT.WI.GOV

DNR LIAISON

JEREMIAH SCHIEFELBEIN
WISCONSIN DEPARTMENT OF NATURAL RESOURCES
2984 SHAWANO AVENUE
GREEN BAY, WI 54313-6727
(920) 360-3784
JEREMIAH.SCHIEFELBEIN@WISCONSIN.GOV

CITY OF WAUSAU CONTACTS

CITY OF WAUSAU - ENGINEERING DEPARTMENT
CITY HALL
407 GRANT STREET
WAUSAU, WI 54403
OFFICE: (715) 261-6740
FAX: (715) 261-6759
AFTER HOURS: (715) 849-7798
ENGINEERING@CI.WAUSAU.WI.US

ERIC LINDMAN - DIRECTOR OF PUBLIC WORKS & UTILITIES

SHEET

OFFICE: (715) 261-6745 ERIC.LINDMAN@CI.WAUSAU.WI.US

ALLEN WESOLOWSKI - CITY ENGINEER
OFFICE: (715) 261-6762
ALLEN.WESOLOWSKI@CI.WAUSAU.WI.US

DAVID HUEMPFNER - CITY SURVEYOR OFFICE: (715) 261-6754

DAVID.HUEMPFNER@CI.WAUSAU.WI.US

PROJECT NO: 6999-00-76

HWY: WEST WAUSAU AVENUE

COUNTY: MARATHON


GENERAL NOTES

FILE NAME: P,\S65XX\S607.DP.23.WAUSAU-AVE.MAR\CADDS\699900076\SHEETS\020101-GN.DWG

PLOT DATE: 4/14/2025 2:49 PM

PLOT BY: PARKER TISCHAUSER PLOT NAME: PLOT NAME: 1" = 1'


Ε

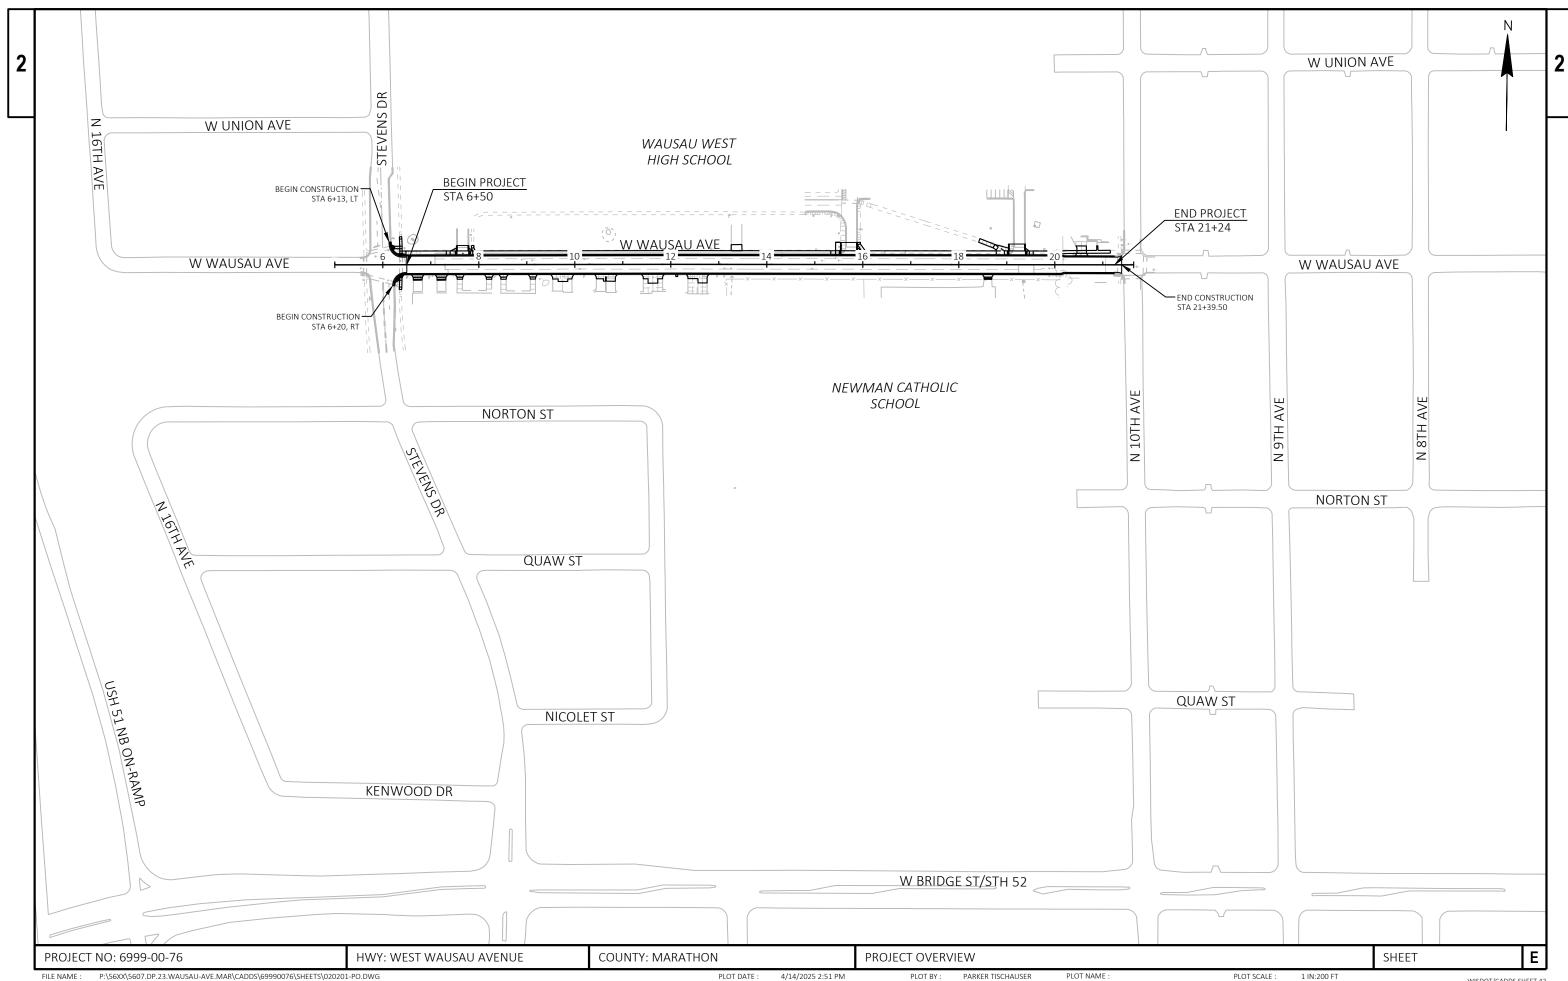


P:\56XX\5607.DP.23.WAUSAU-AVE.MAR\CADD\$\69990076\\$HEET\$\020201-PO.DWG LAYOUT NAME - 01

1 IN:200 FT



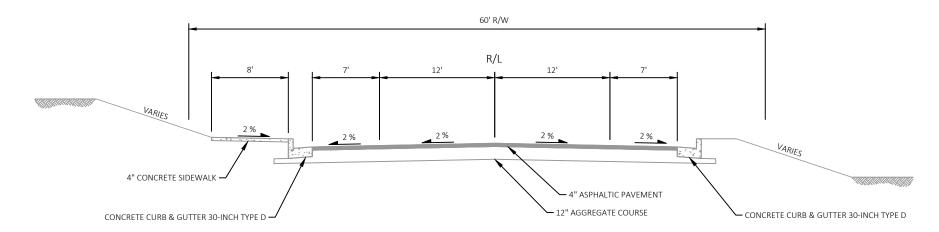

EXISTING TYPICAL SECTION W WAUSAU AVE STA 6+13 - STA 7+07

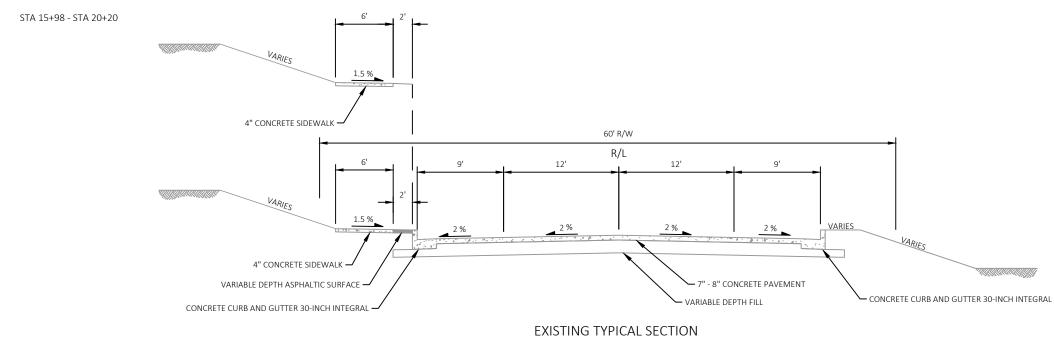

W WAUSAU AVE STA 7+07 - STA 20+20

2

FILE NAME :

60' R/W

R/L

1.5 % VARIES

2 % 2 % 2 % 2 % VARIES

CONCRETE CURB & GUTTER 30-INCH TYPE D


10" AGGREGATE COURSE

EXISTING TYPICAL SECTION
W WAUSAU AVE
STA 20+20 - STA 21+39.50

PROJECT NO: 6999-00-76 HWY: WEST WAUSAU AVENUE COUNTY: MARATHON TYPICAL SECTIONS SHEET **E**

PLOT DATE : 4/14/2025 2:53 PM

P:\56XX\5607.DP.23.WAUSAU-AVE.MAR\CADDS\69990076\SHEETS\020301-TS.DWG LAYOUT NAME - 02

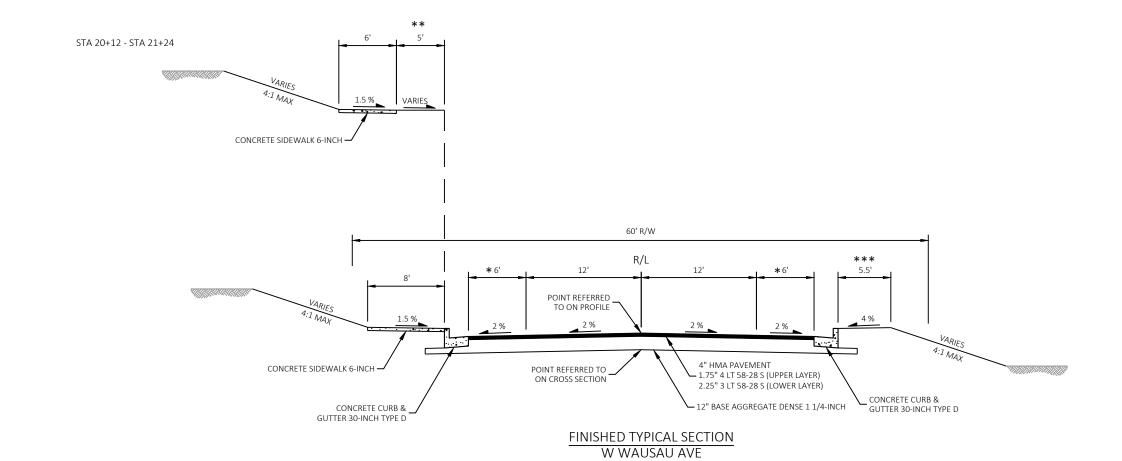


- * 4' FROM STA 20+20 STA 21+24, SEE PAVING DETAILS FOR TRANSITION
- ** TRANSITION TERRACE WIDTH FROM 2' TO 5' FROM STA 20+12 STA 20+26
- *** 3' FROM STA 13+20 STA 13+40

SEE PAVING DETAILS FOR ROADWAY PAVEMENT REPLACEMENT FROM STA 21424 TO STA 21439.50. USE SAME HMA PAVEMENT STRUCTURE AS SHOWN TO REPLACE PAVEMENT BETWEEN EXISTING CURB AND GUTTER.

COUNTY: MARATHON Ε PROJECT NO: 6999-00-76 HWY: WEST WAUSAU AVENUE TYPICAL SECTIONS SHEET P:\56XX\5607.DP.23.WAUSAU-AVE.MAR\CADDS\69990076\SHEETS\020301-TS.DWG PLOT DATE : 4/14/2025 2:53 PM PLOT BY: PARKER TISCHAUSER PLOT NAME : PLOT SCALE : 1 IN:10 FT FILE NAME : WISDOT/CADDS SHEET 42

STA 6+50 - STA 21+24

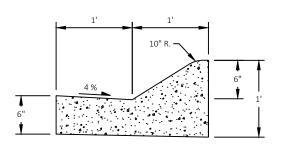

CONCRETE CURB AND GUTTER 24-INCH TYPE D


WAUSAU WEST SCHOOL DRIVEWAYS SEE CURB RAMP DETAILS FOR LOCATIONS


CONCRETE CURB AND GUTTER 12-INCH SLOPED 24-INCH TYPE D

WAUSAU WEST SCHOOL DRIVEWAYS

SEE CURB RAMP DETAILS FOR LOCATIONS

 $\frac{\text{NOTE}}{\text{SEE SDD}}$ "Concrete curb and gutter" for additional information

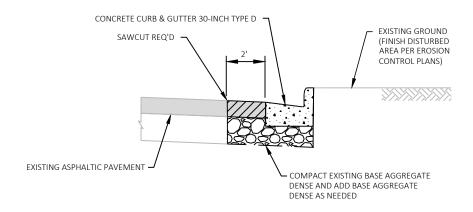

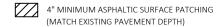

CONCRETE CURB & GUTTER REPLACEMENT DETAIL

STEVENS DRIVE SE AND NE RADII

COMPLETE CURB & GUTTER REPLACEMENTS AND ASPHALTIC SURFACE PATCHING TO MATCH THE EXISTING SURFACE

FOR DETAILS NOT SHOWN, SEE SDD "CONCRETE CURB, CONCRETE CURB & GUTTER AND TIES"

SEE CURB RAMP DETAILS FOR ADDITIONAL INFORMATION

COUNTY: MARATHON

CONSTRUCTION DETAILS

SHEET

PROJECT NO: 6999-00-76 FILE NAME :


PLOT BY:

PARKER TISCHAUSER

PLOT NAME

Ε

1" DEPRESSION BELOW NORMAL FLOW LINE - CONCRETE CURB & GUTTER 30-INCH GRATE ELEVATION AS SHOWN ON THE

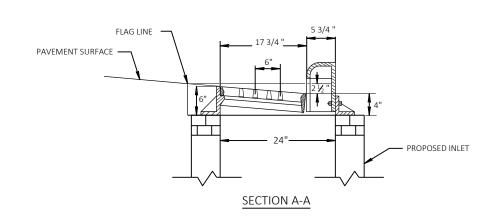

CONCRETE CURB & GUTTER AT INLETS DETAIL

(TYPE 2X3-FT / H INLET SHOWN) STA 10+03, RT STA 10+05, LT

STA 14+91, LT

STA 14+93, RT STA 15+08, RT

STA 15+09, LT

4/14/2025 2:57 PM

P:\56XX\5607.DP.23.WAUSAU-AVE.MAR\CADDS\69990076\SHEETS\021001-CD.DWG

HWY: W WAUSAU AVE

PLOT SCALE : 1 IN:10 FT







TOP OF AGGREGATE SHOULDER -

WISDOT MONUMENT CAP MARKER LOGO (SSDR130)

CONTRACTOR TO ORDER LANDMARK REFERENCE MONUMENTS
WITH THE ABOVE STAMPING

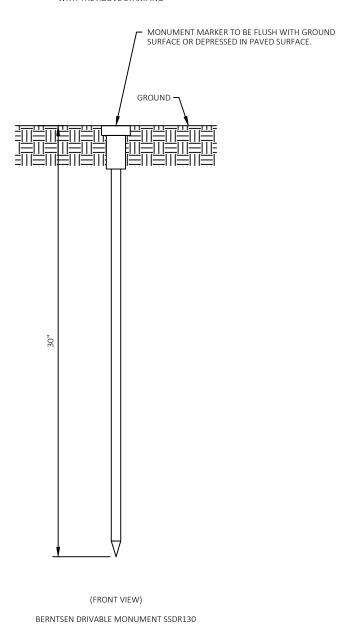

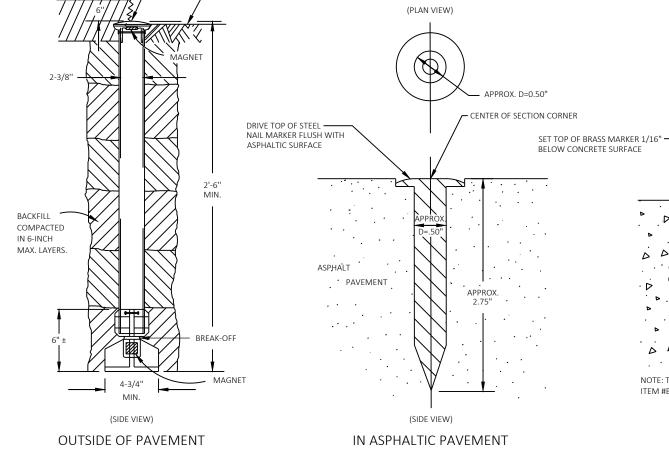

- SECTION CORNER LOCATION

- GROUND

TO BE MARKED WITH A PUNCH MARK

> CENTER OF SECTION CORNER (PLAN VIEW OF DRILL HOLE) APPROX. D=0.50" - CENTER OF SECTION CORNER (TO BE MARKED WITH A PUNCH MARK) CONCRETE PAVEMENT · D ITEM #BPMDRL, AVAILABLE FROM BERNTSEN INTERNATIONAL INC. (SIDE VIEW OF DRILL HOLE)

> > IN CONCRETE PAVEMENT

BERNTSEN BP - 1 BRASS MARKER WITH ANCHOR PLUG

SECTION CORNER MONUMENTS

GENERAL NOTES

DETAILS OF CONSTRUCTION, MATERIALS AND WORKMANSHIP NOT SHOWN ON THIS DRAWING SHALL CONFORM TO THE PERTINENT REQUIREMENTS OF THE STANDARD SPECIFICATIONS AND THE APPLICABLE SPECIAL PROVISIONS

LOCATE LANDMARK REFERENCE MONUMENTS OUTSIDE THE CONSTRUCTION LIMITS AND WITHIN WISDOT RIGHT OF WAY. LOCATION TO BE APPROVED BY THE ENGINEER

CONTRACTOR WILL SUPPLY ALL REQUIRED SURVEY MONUMENTS

BERNTSEN SNM1 STEEL NAIL MARKER

CENTER OF SECTION CORNER

LANDMARK REFERENCE MONUMENT (TIES ONLY)

SECTION CORNER MONUMENT AND LANDMARK REFERENCE MONUMENT DETAIL

Ε PROJECT NO: 6999-00-76 HWY: W WAUSAU AVE **COUNTY: MARATHON** CONSTRUCTION DETAILS SHEET PARKER TISCHAUSER 4/14/2025 2:57 PM 1 IN:10 FT


P:\56XX\5607.DP.23.WAUSAU-AVE.MAR\CADDS\69990076\SHEETS\021001-CD.DWG

BERNTSEN A1BR30 ALUMINUM BREAK-OFF MONUMENT

PLOT NAME

PLOT SCALE :



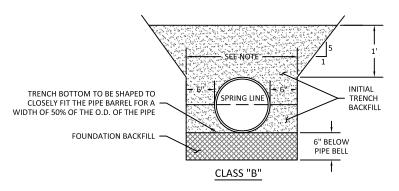


NOTE:
THE TRENCH WIDTH IS TO BE TAKEN AS THE HORIZONTAL DISTANCE AT THE OUTSIDE TOP OF THE PIPE.

NATIVE SOILS CONFORMING TO THE FOUNDATION OR INITIAL BACKFILL SPECIFICATIONS MAY BE USED.

THE MAXIMUM ALLOWABLE WIDTH SHALL BE:

3.0' GREATER THAN OUTSIDE DIA. FOR 36" OR LARGER PIPE 2.0' GREATER THAN OUTSIDE DIA. FOR PIPES LESS THAN 36" IN DIA.

FLEXIBLE & RIGID PIPE BEDDING CLASSIFICATIONS

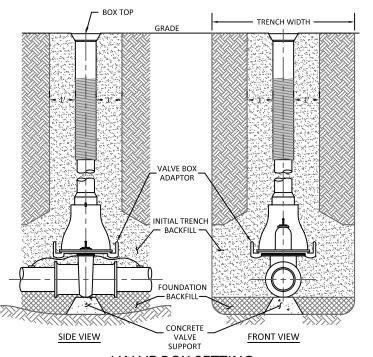


BELOW FINISHED PAVEMENT SURFACE PRIOR TO PAVING BIT. CONC. BINDER COURSE COMPACTED BASE COURSE


WATER VALVE BOX ADJUSTMENT

ADJUST VALVE BOX TO 1/4"

VALVE BOX SETTING

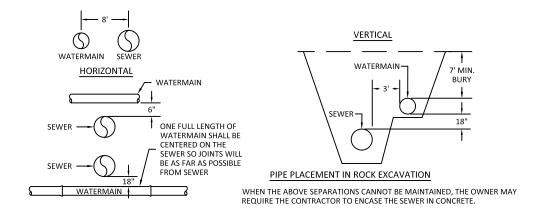


STORM AND SANITARY SEWER/WATERMAIN SEPARATION DISTANCE

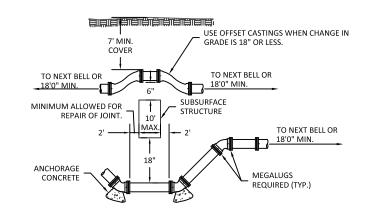

TYPICAL WATERMAIN OFFSETS 6" THRU 16"

NOTE: MEGALUG AND REACTION BACKING PROVIDED BY CONTRACTOR

N.T.S

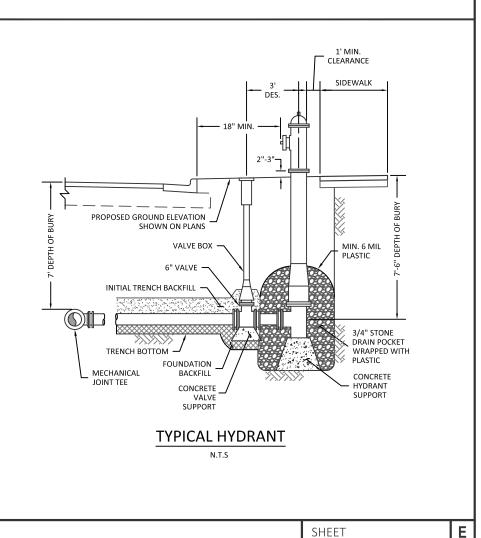


PROJECT NO: 6999-00-76

HWY: WEST WAUSAU AVENUE

COUNTY: MARATHON


CONSTRUCTION DETAILS - UTILITIES


SHEET

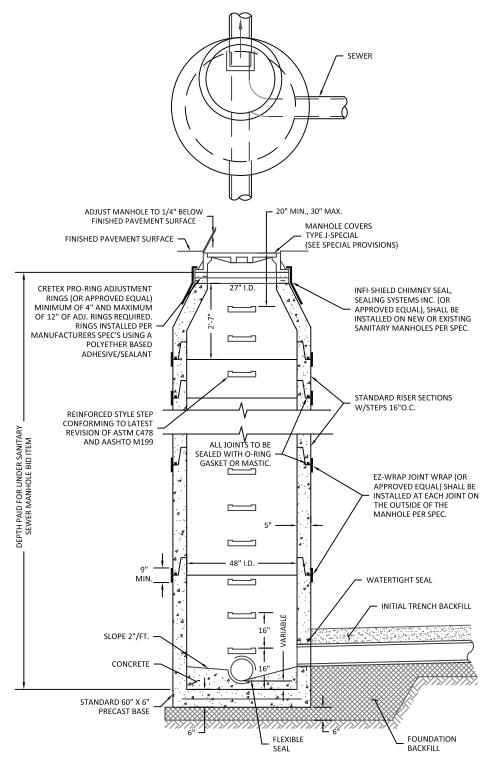

PRE-CAST CONCRETE SANITARY MANHOLE


I.T.S

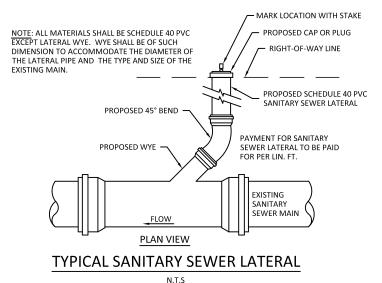

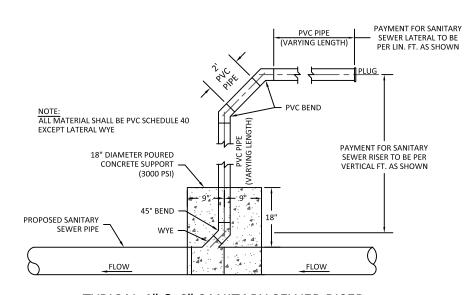

TYPICAL 4" & 6" SANITARY SEWER RISER


N.T.S

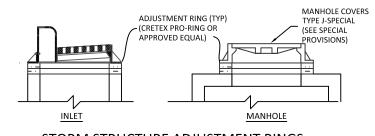



STORM STRUCTURE ADJUSTMENT RINGS

N.T.S

PROJECT NO: 6999-00-76 HWY: WEST WAUSAU AVENUE COUNTY: MARATHON CONSTRUCTION DETAILS - UTILITIES SHEET **E**

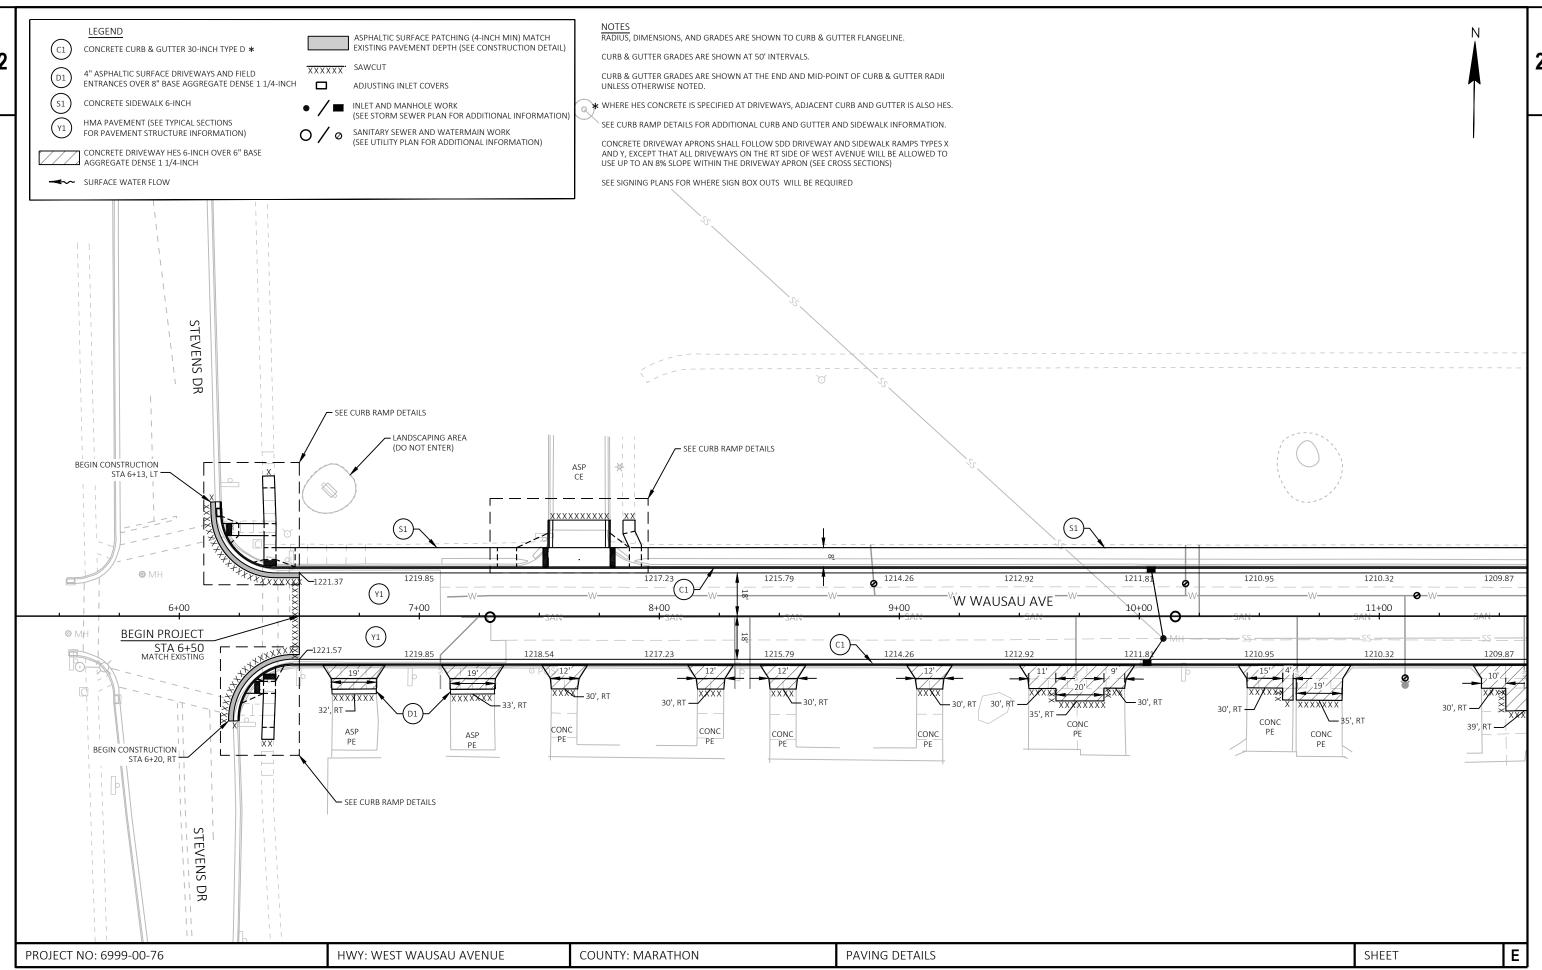

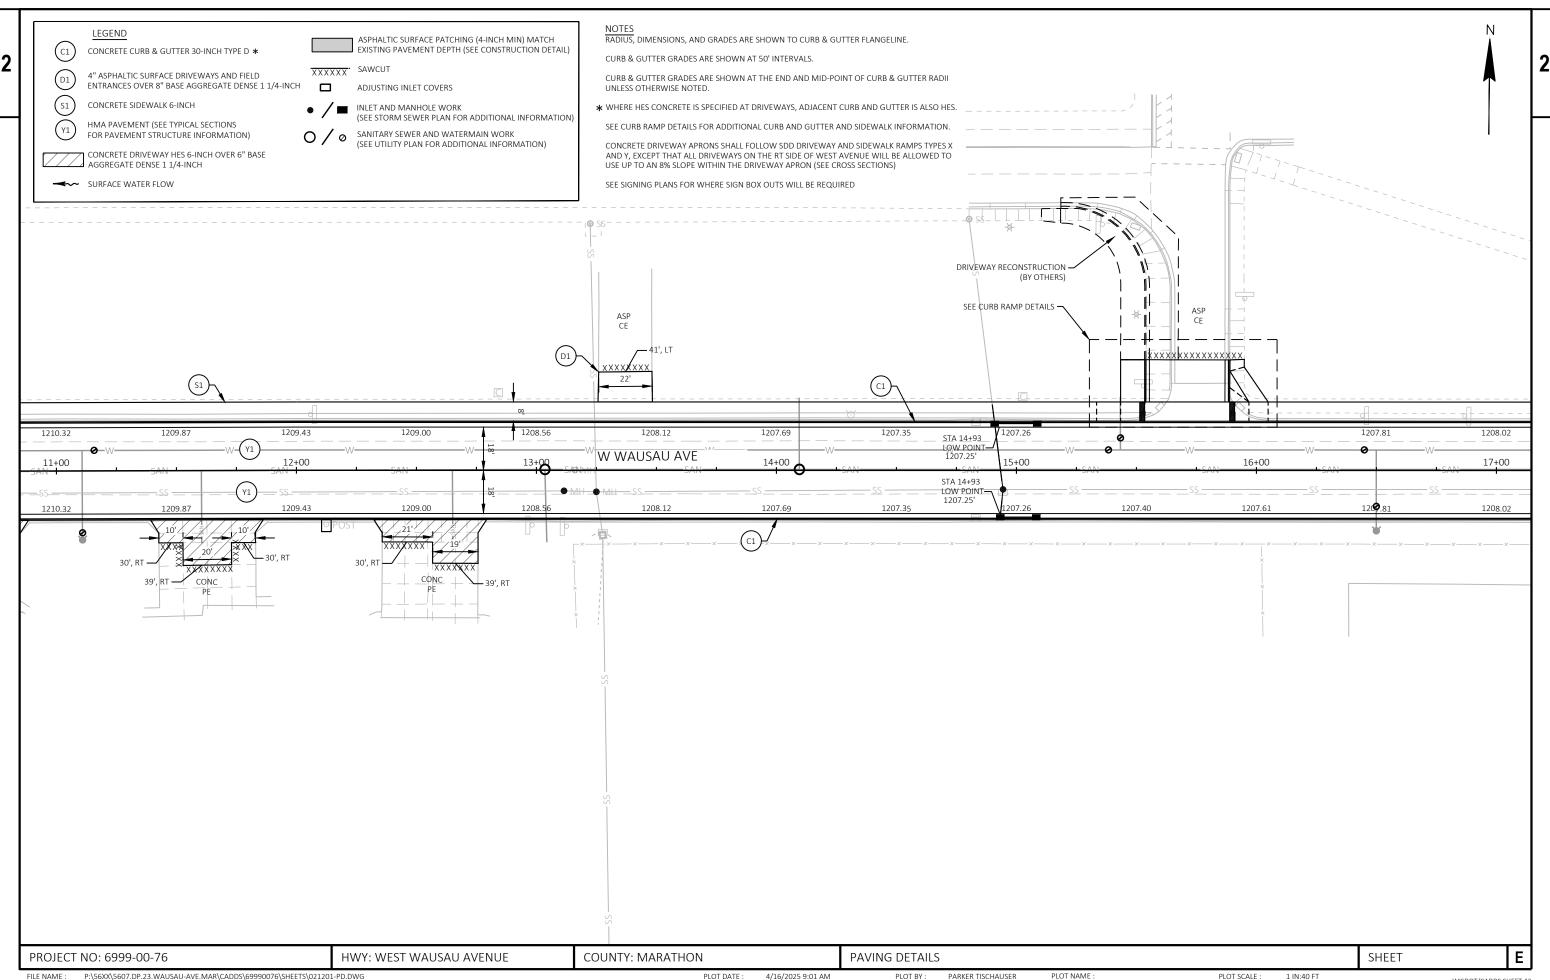


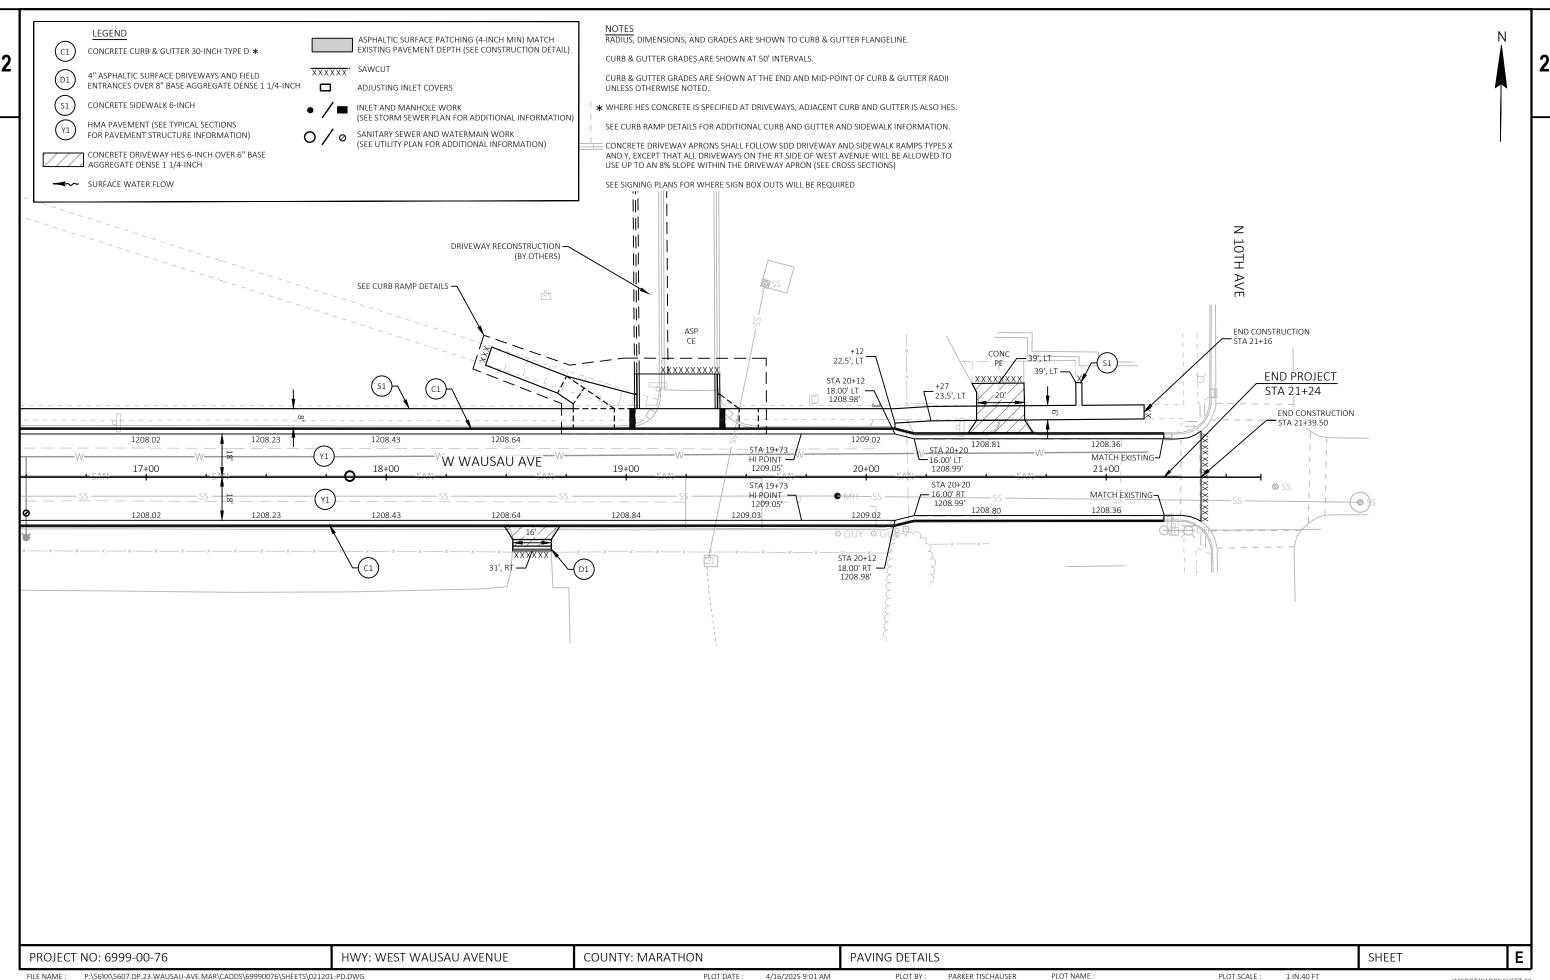

P:\56XX\5607.DP.23.WAUSAU-AVE.MAR\CADDS\69990076\SHEETS\021201-PD.DWG


PLOT NAME

PLOT SCALE : 1 IN:40 FT

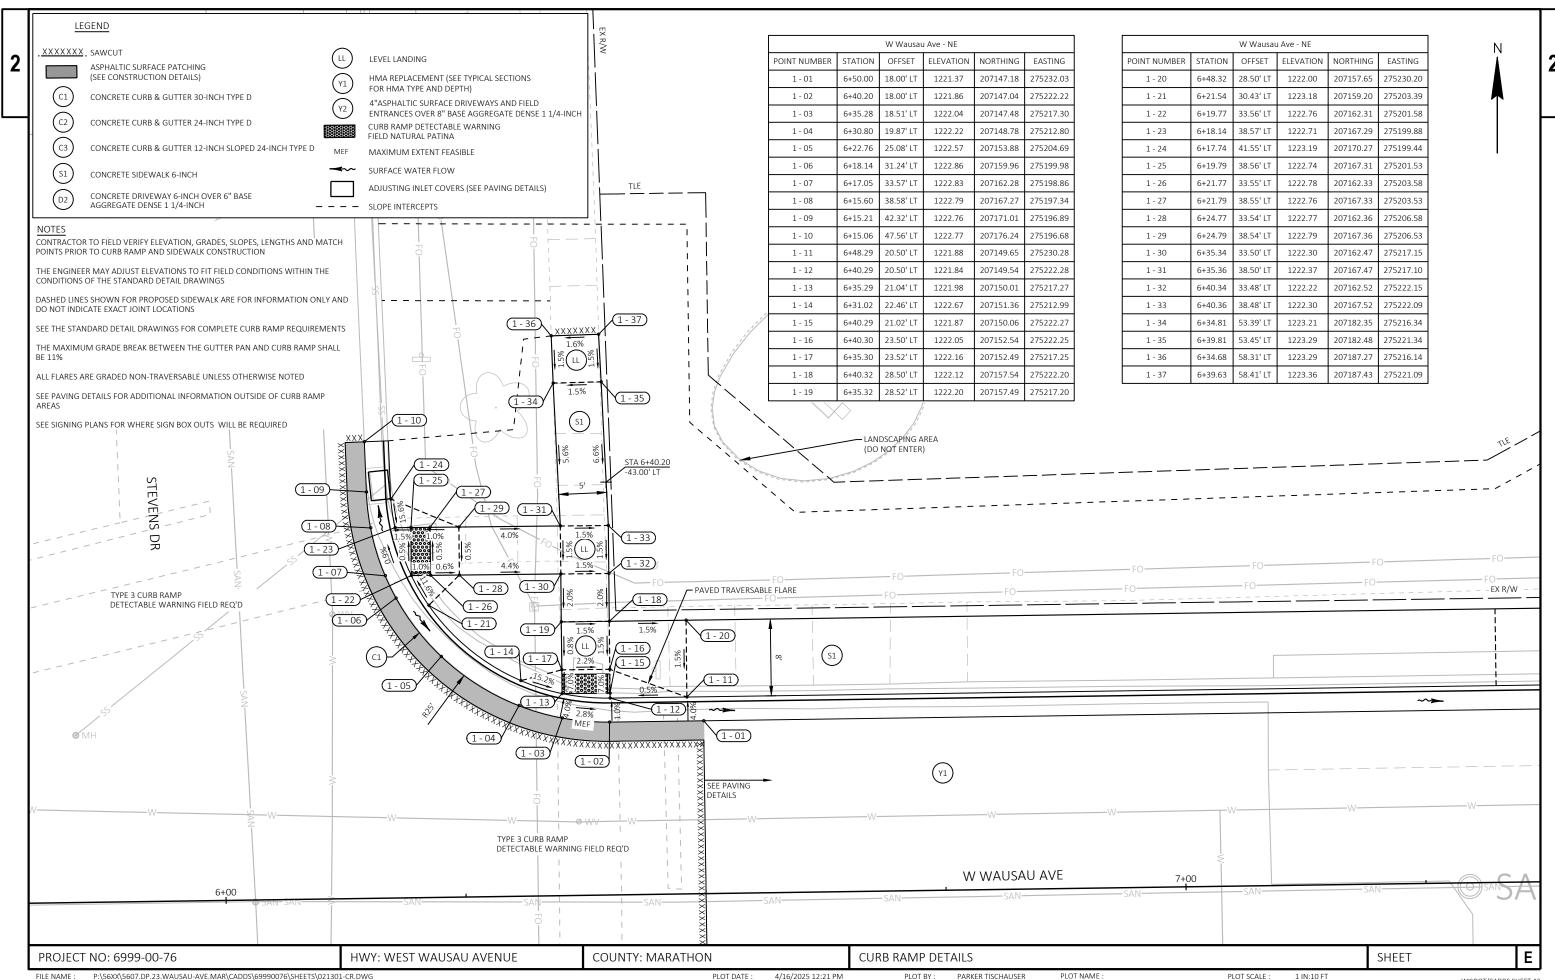

LAYOUT NAME - 01


PLOT SCALE :

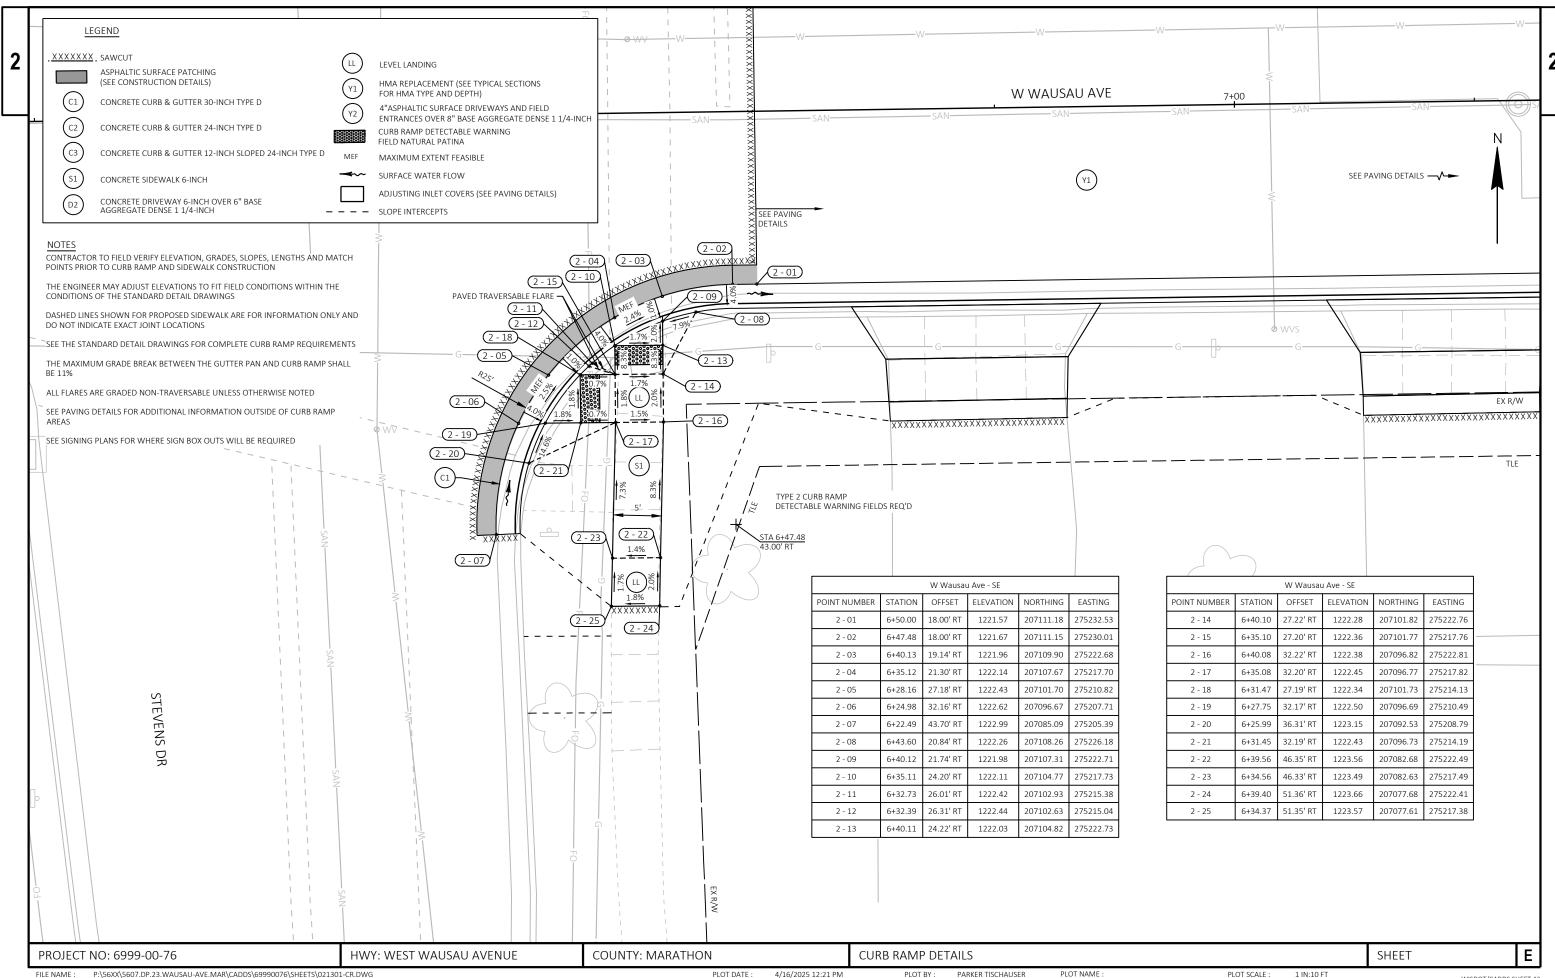



LAYOUT NAME - 02


PLOT NAME


PLOT SCALE :

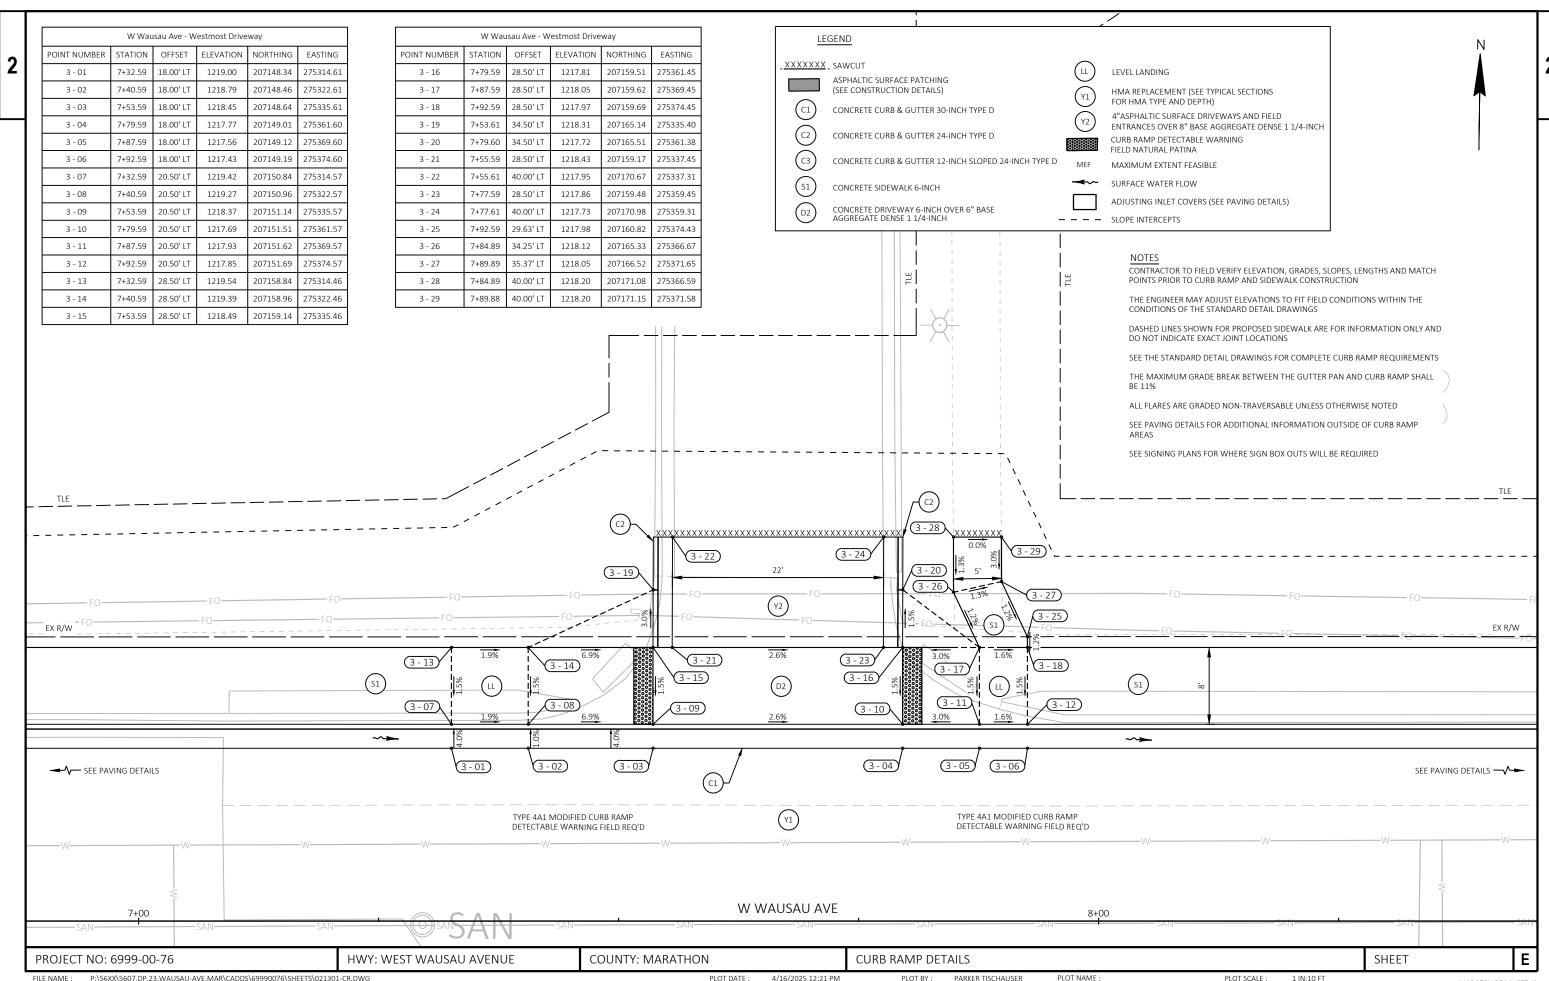

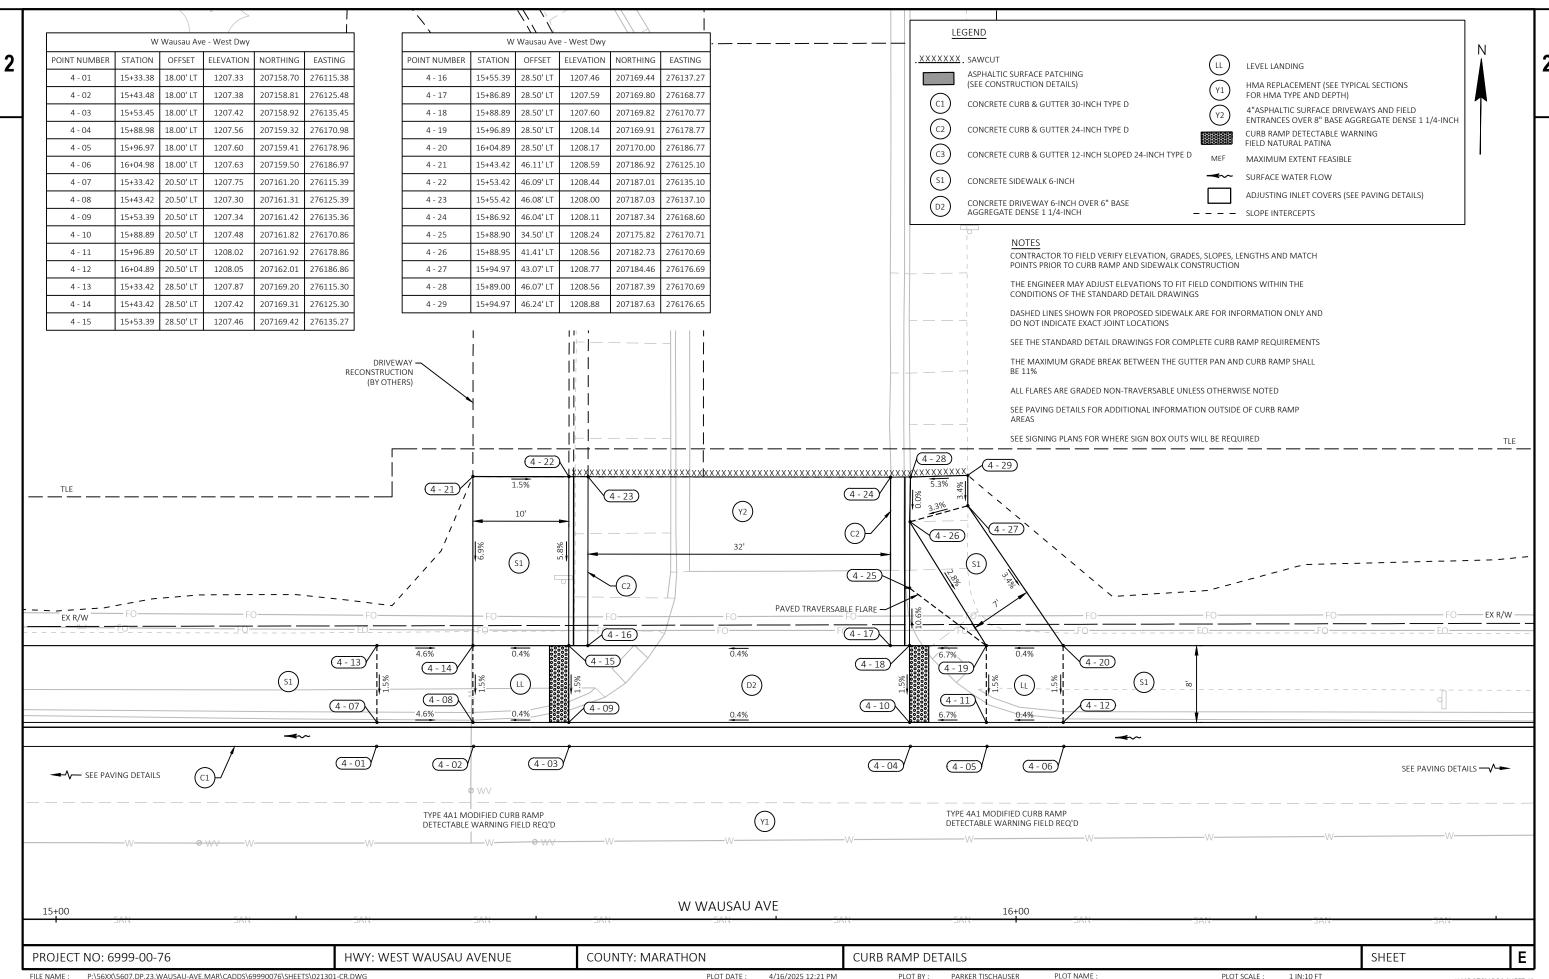


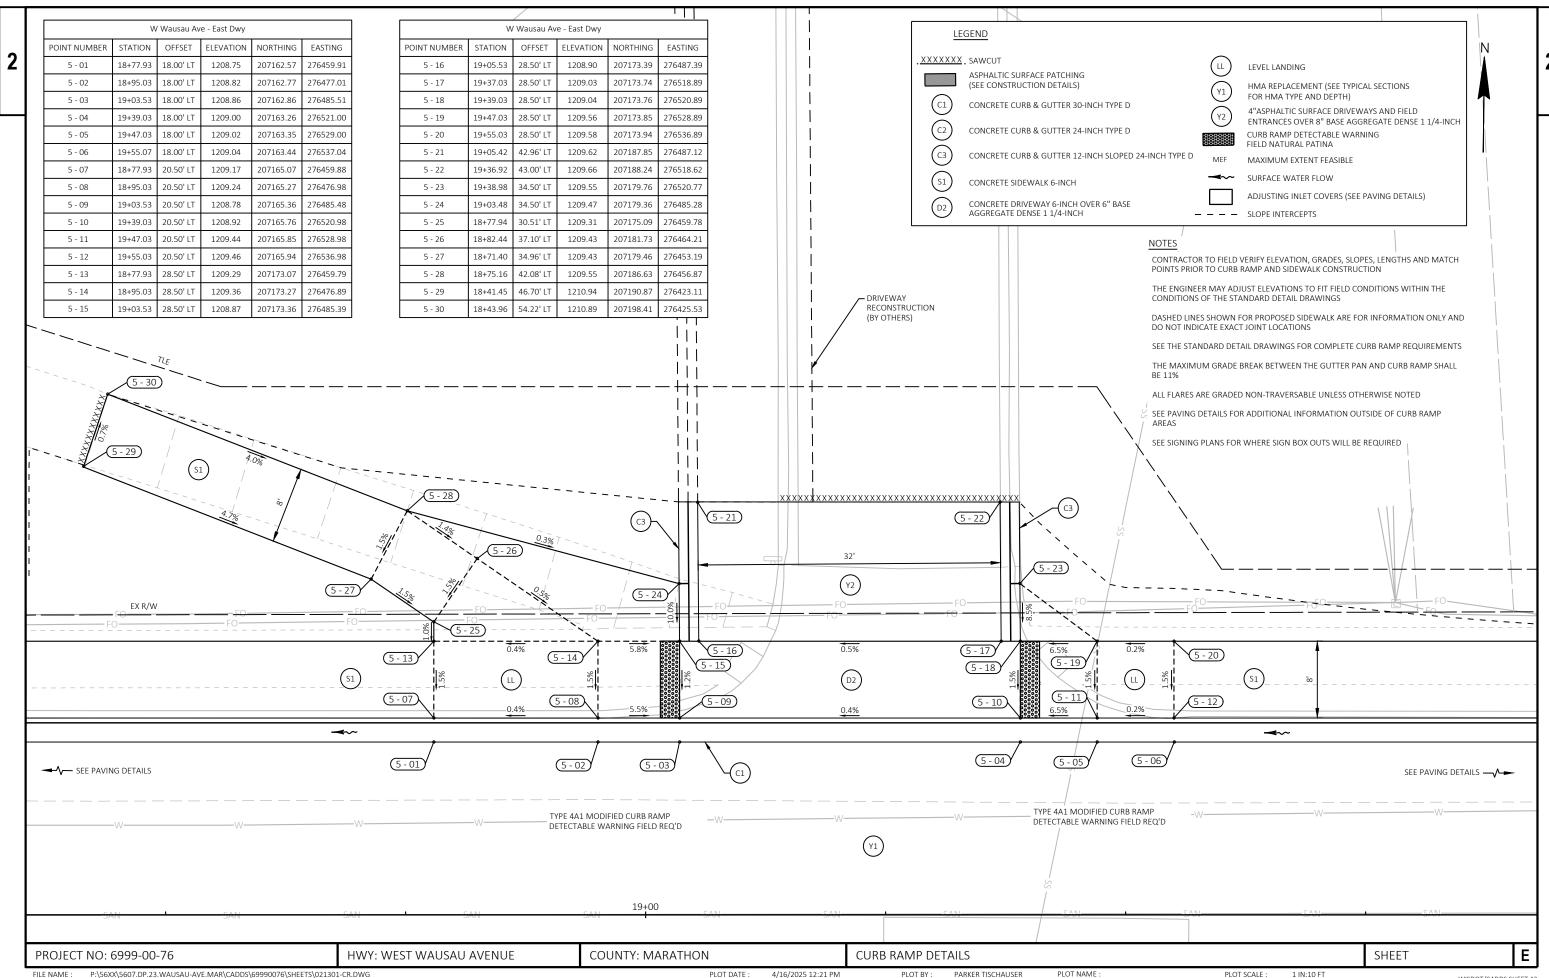

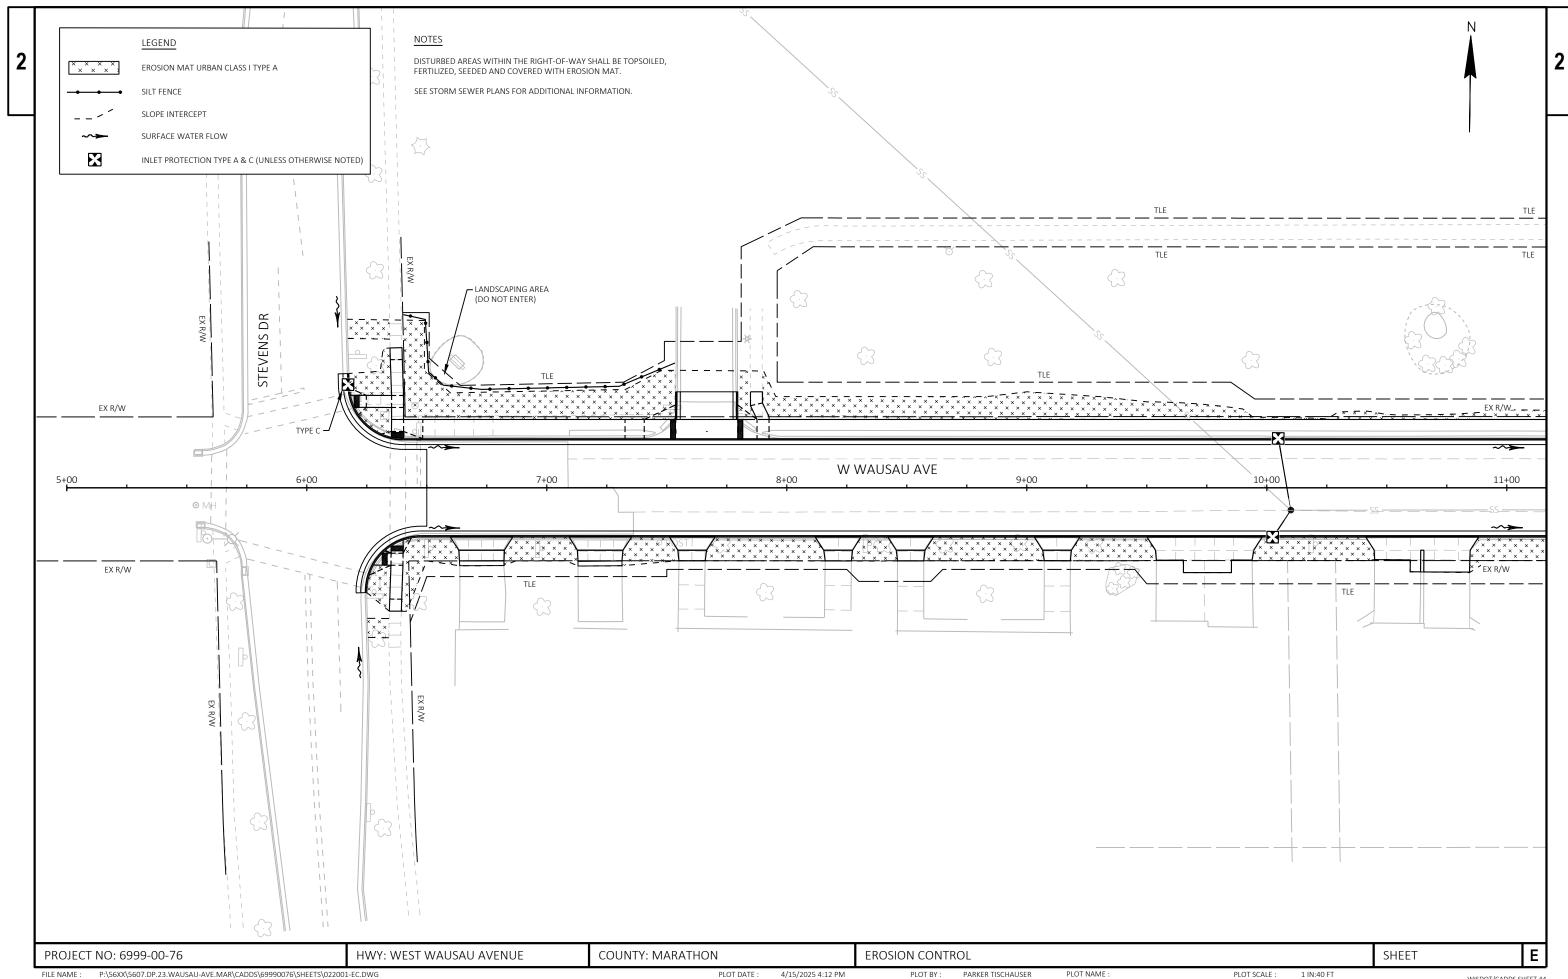

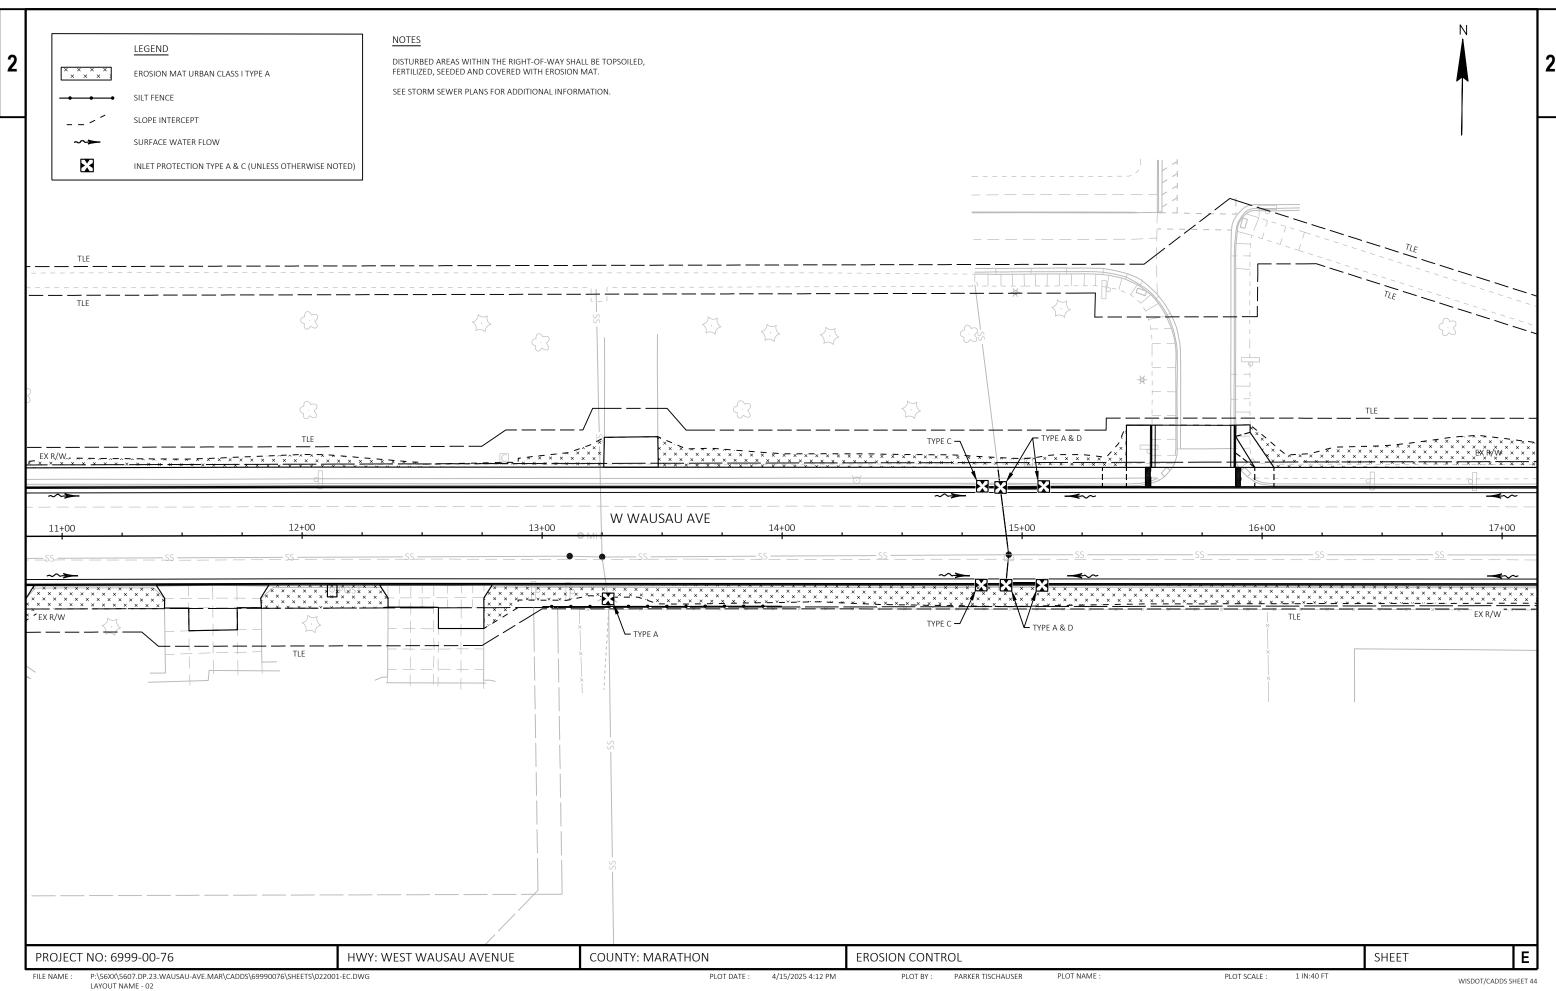



PLOT SCALE :

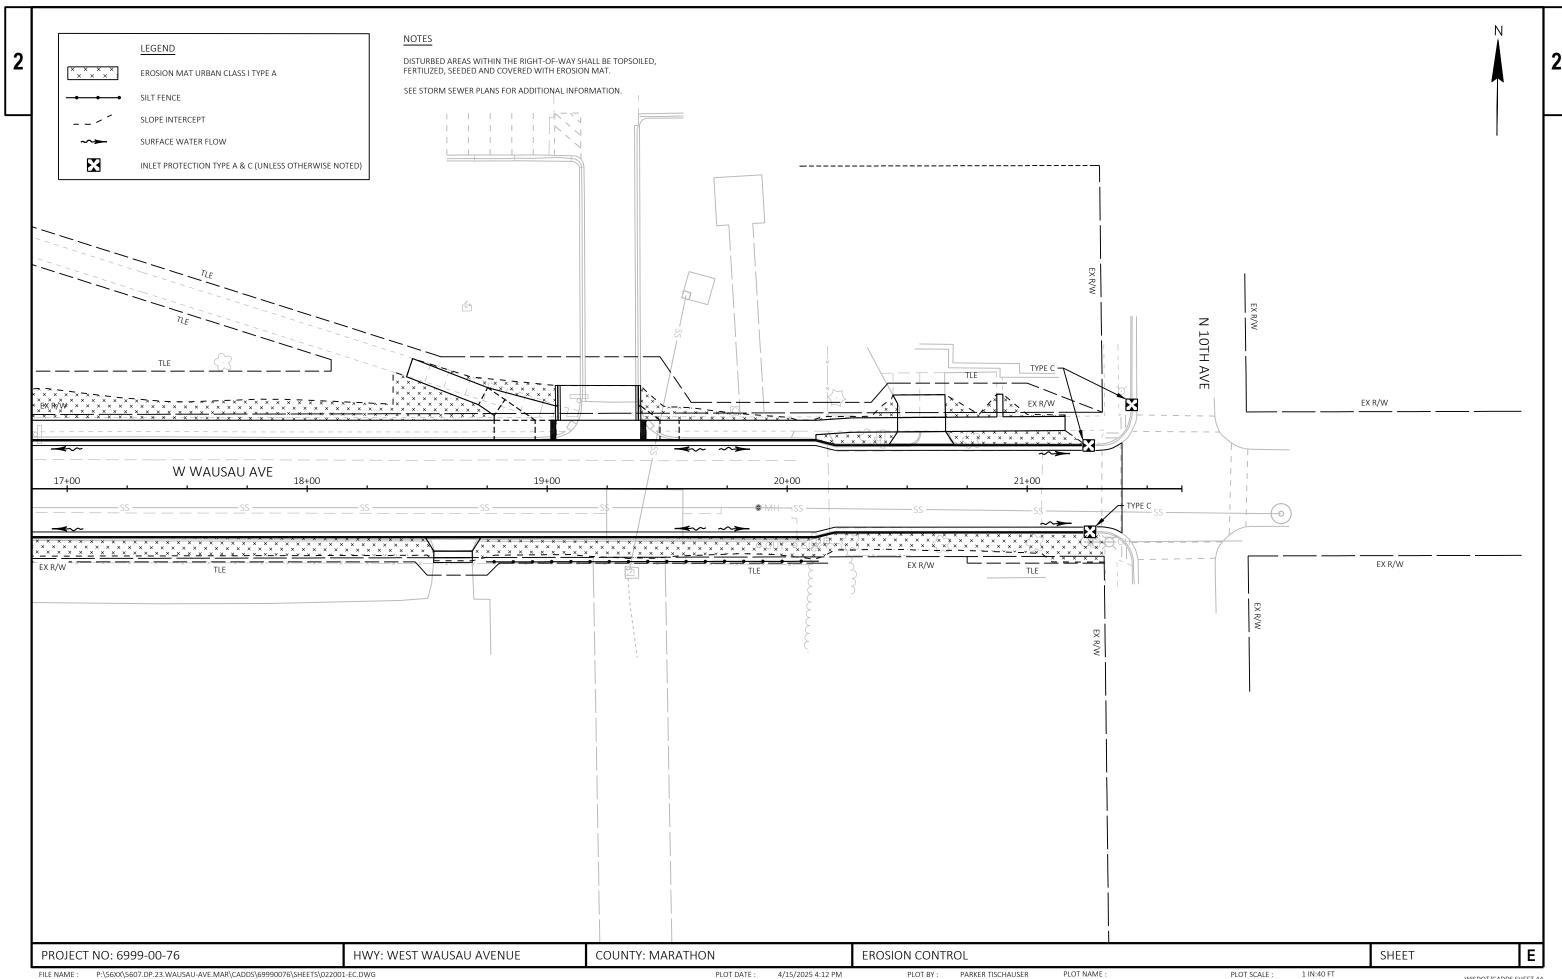



P:\56XX\5607.DP.23.WAUSAU-AVE.MAR\CADDS\69990076\SHEETS\022001-EC.DWG LAYOUT NAME - 03


1 IN:40 FT

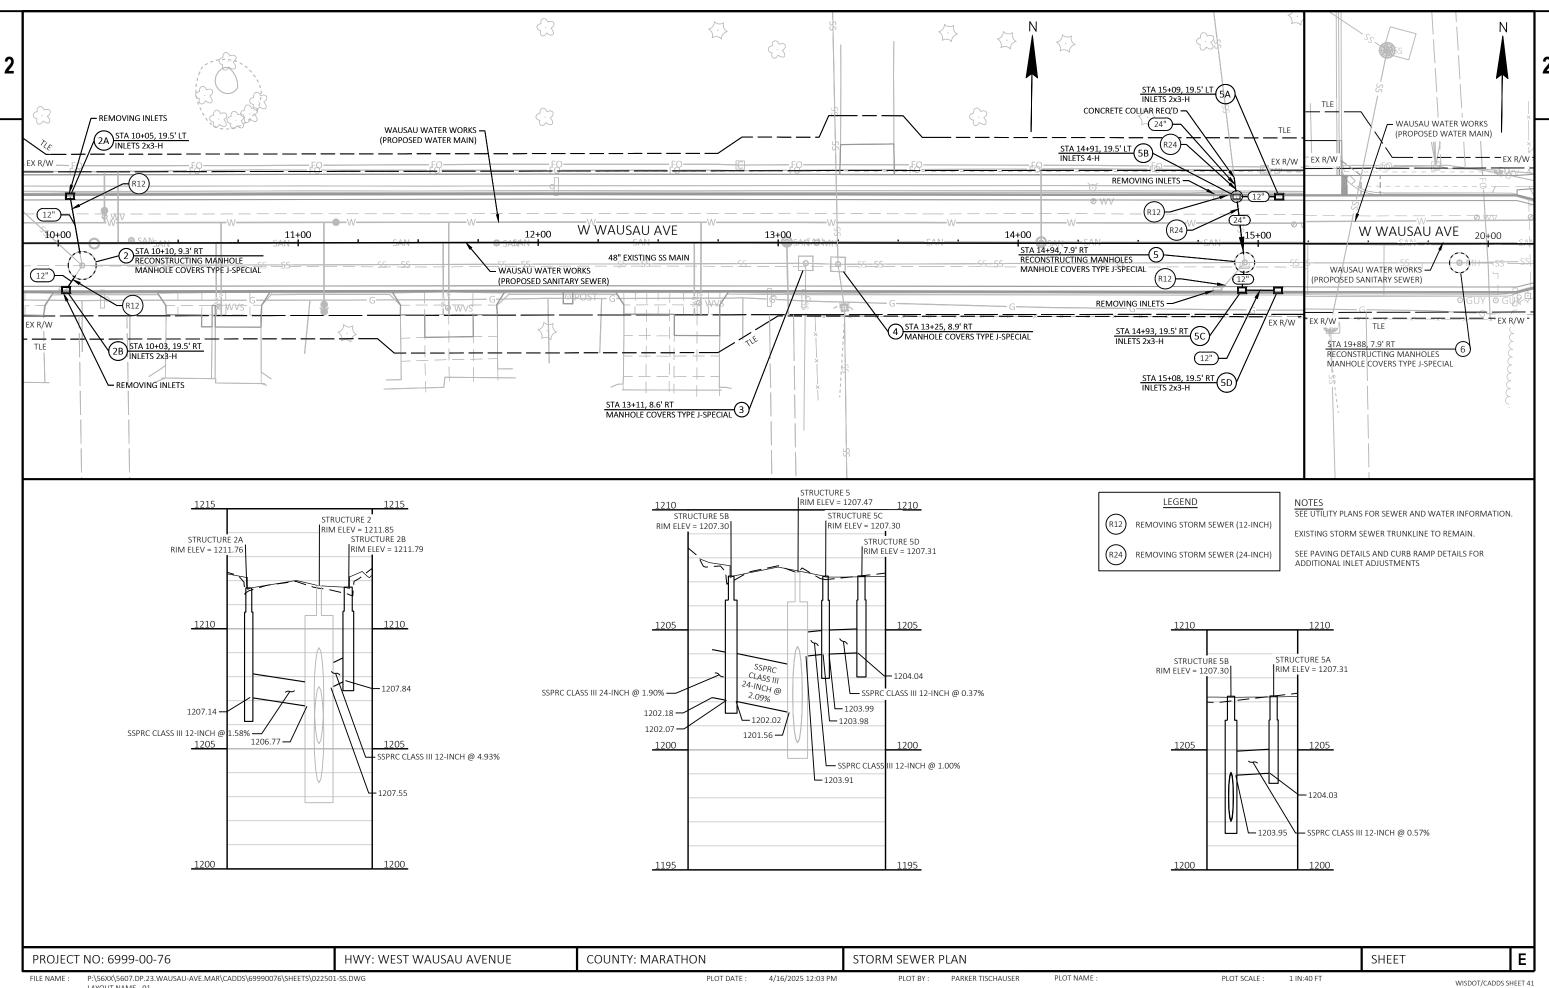

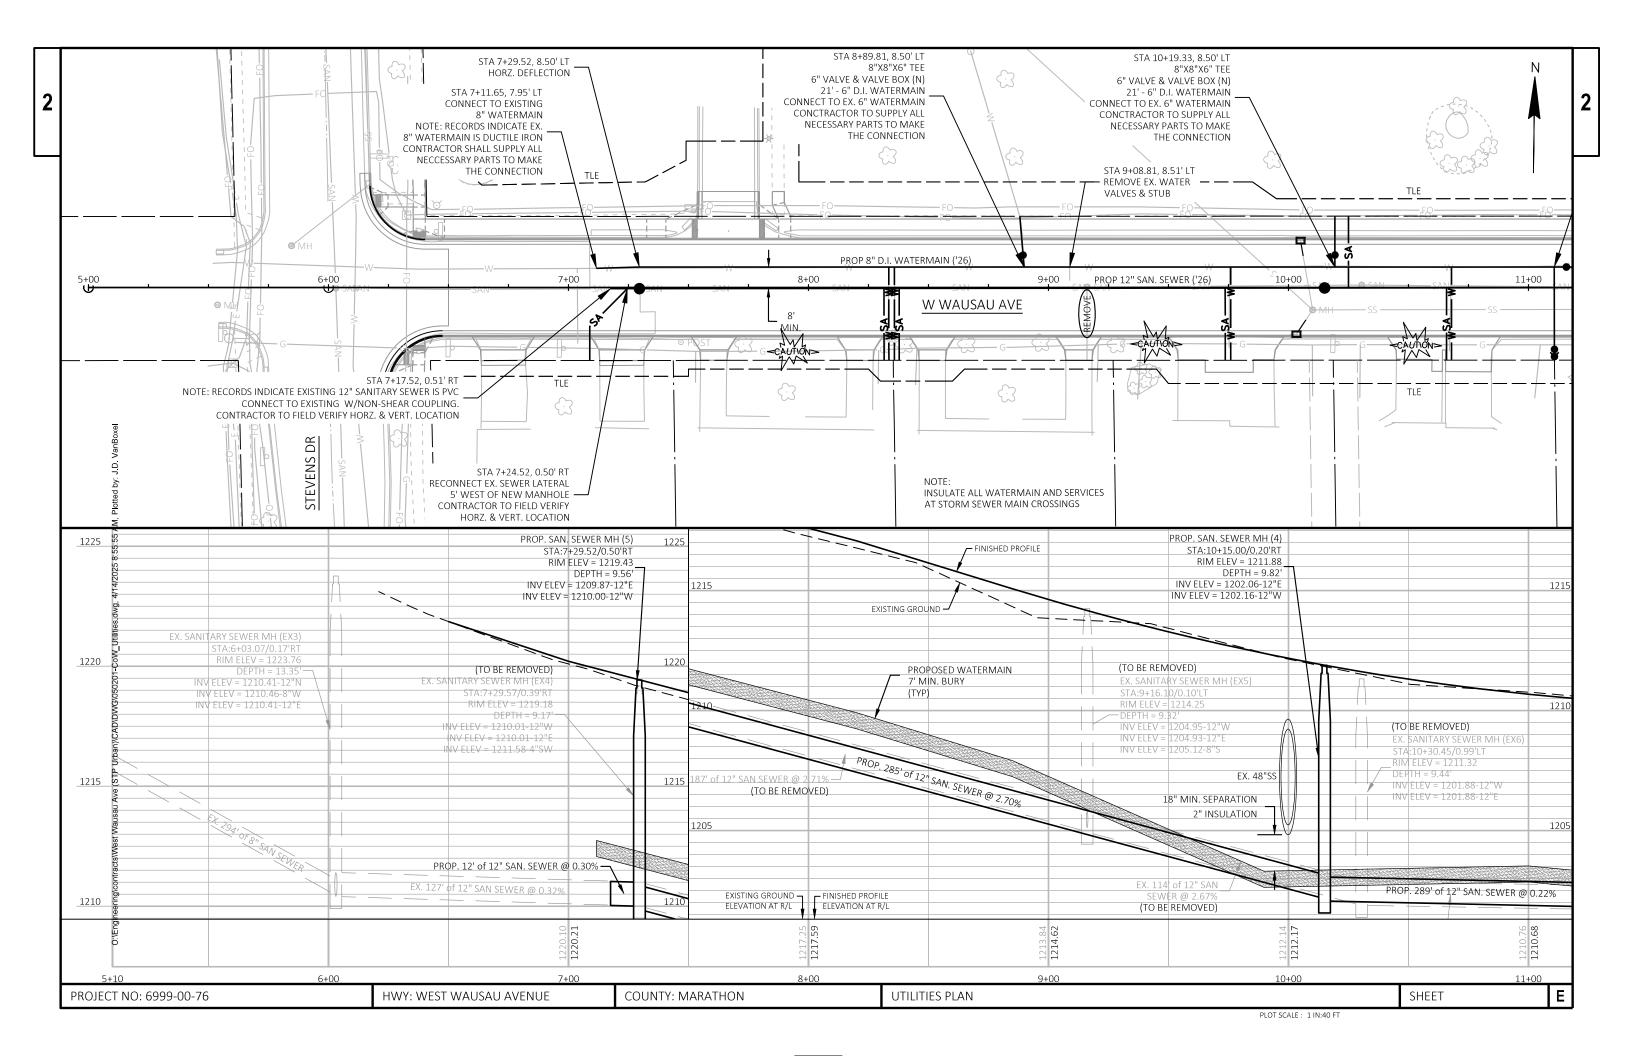


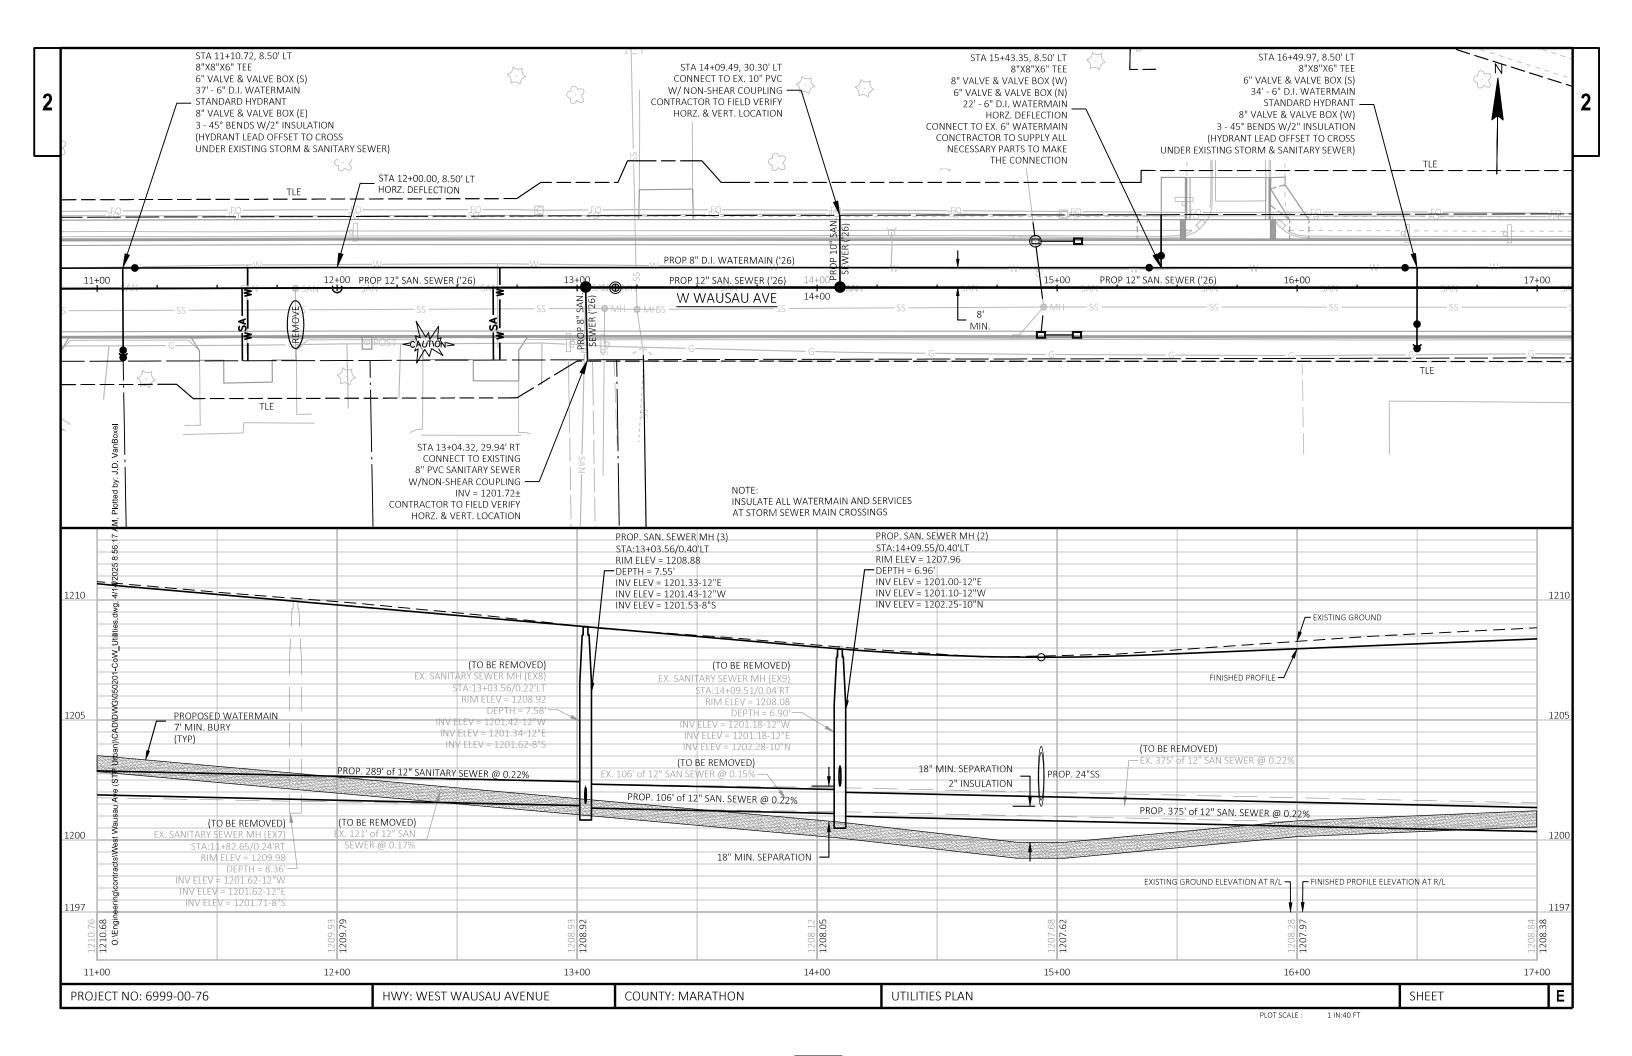

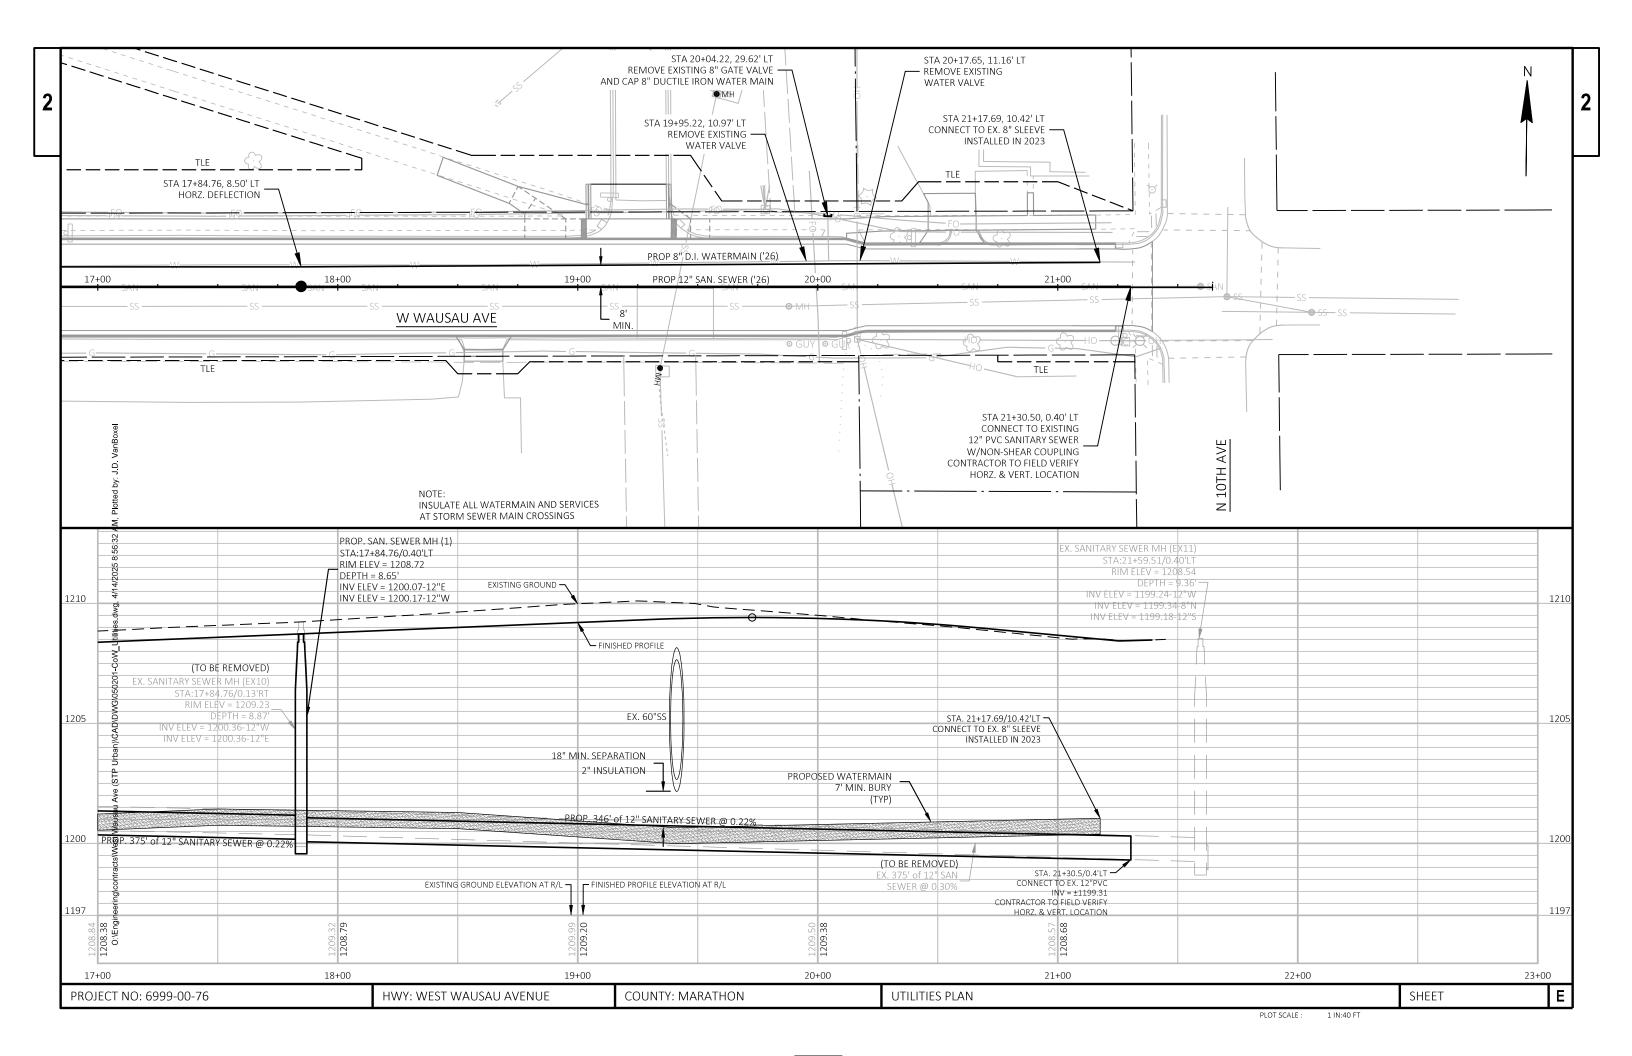


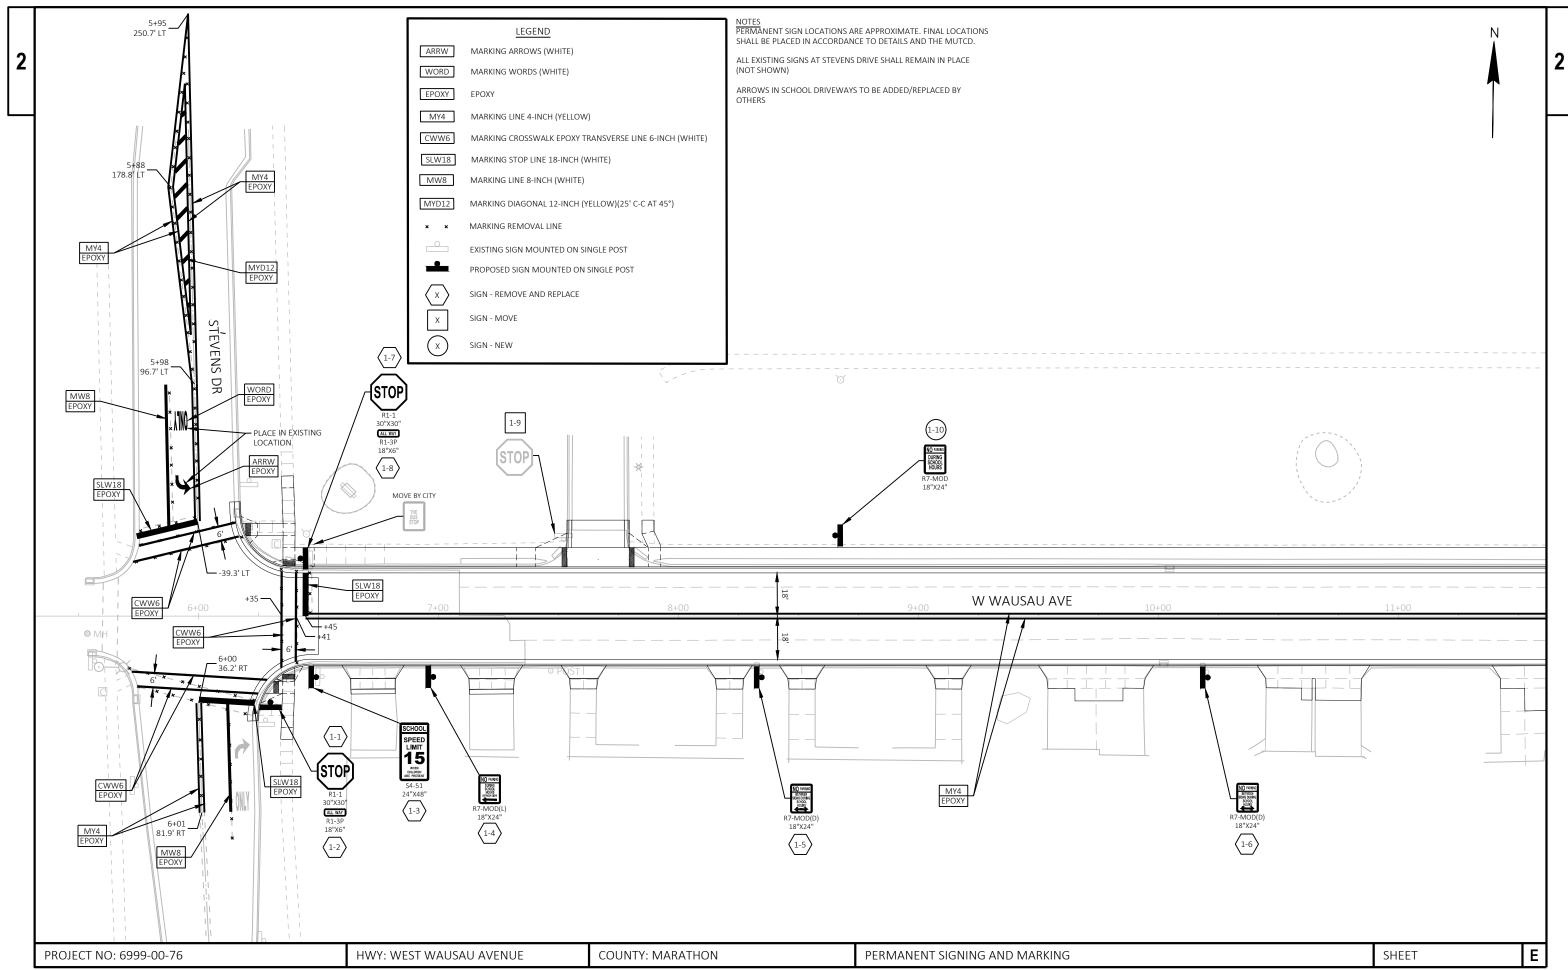


FILE NAME: P:\S6XX\\5607.DP.23.WAUSAU-AVE.MAR\CADDS\\69990076\\SHEETS\\024502-PM.DWG PLOT BY: PARKER TISCHAUSER PLOT NAME: 1 IN:40 FT WISDOT/CADDS SHEET 42

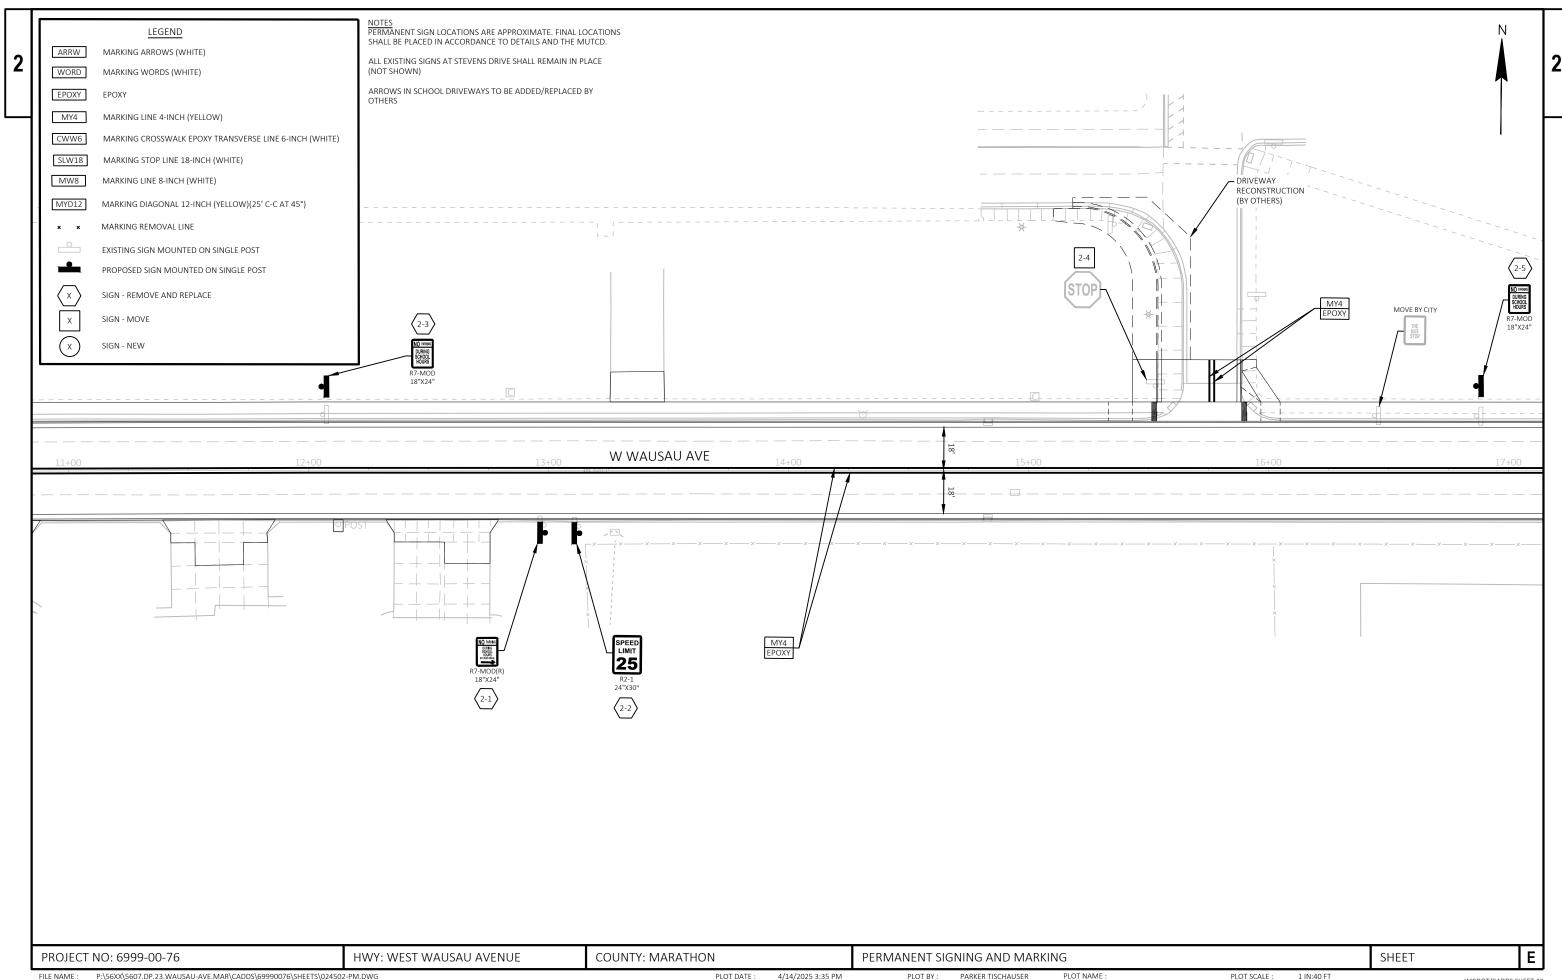


P:\56XX\5607.DP.23.WAUSAU-AVE.MAR\CADDS\69990076\SHEETS\024502-PM.DWG PLOT DATE : 4/14/2025 3:35 PM PLOT BY: PARKER TISCHAUSER PLOT SCALE : 1 IN:40 FT WISDOT/CADDS SHEET 42

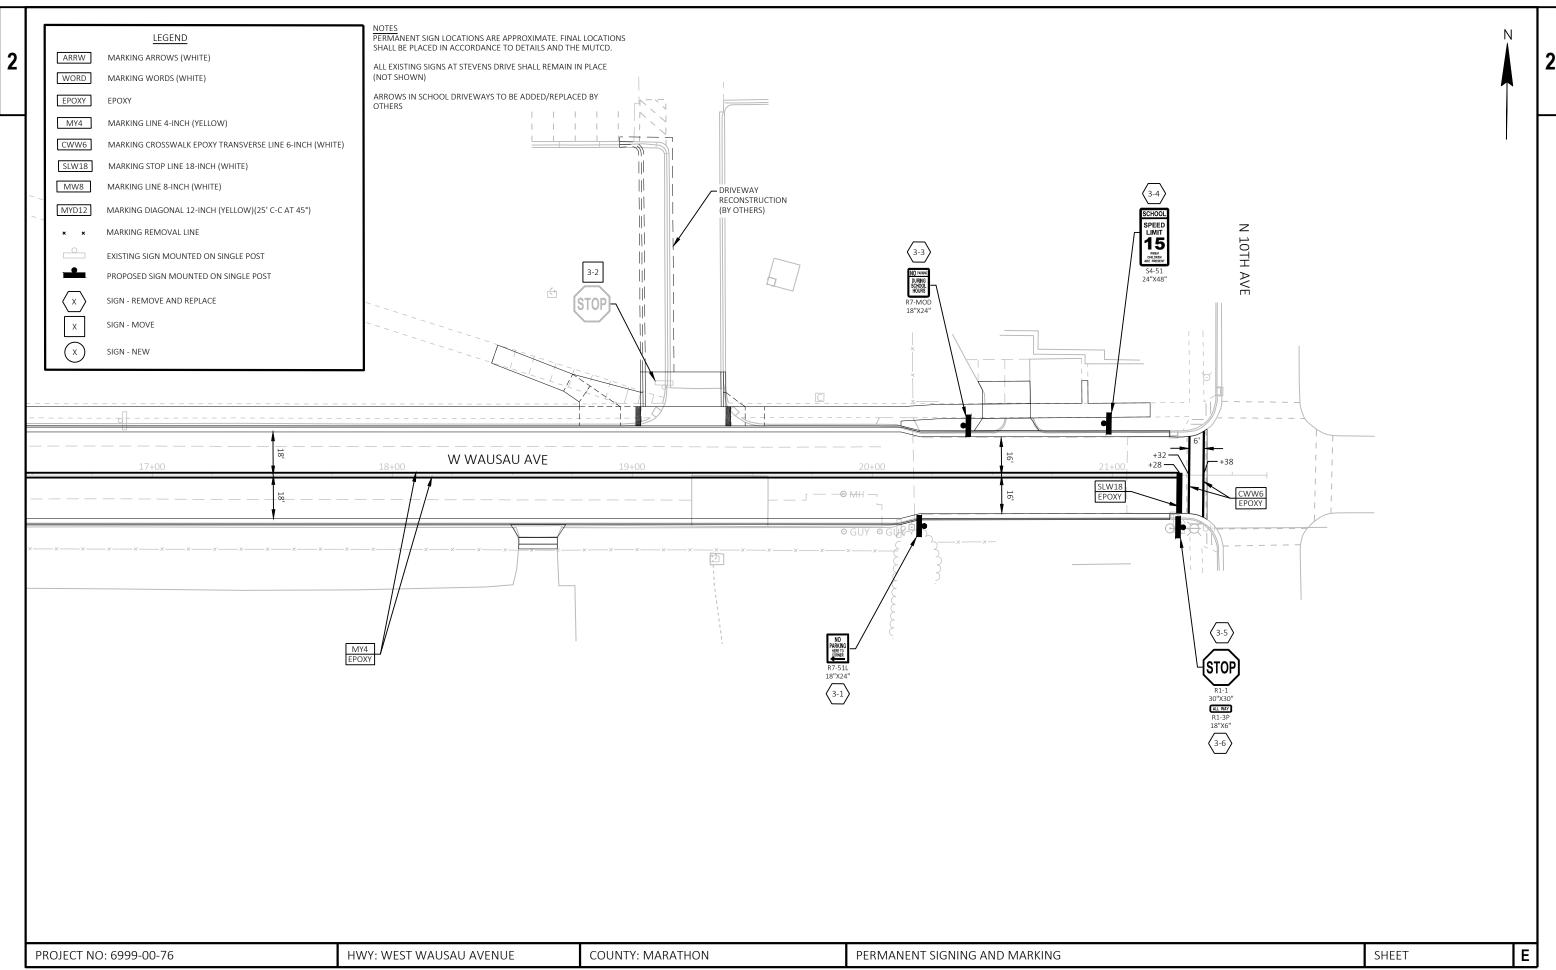


FILE NAME: PLOT DATE: 4/14/2025 3:35 PM PLOT BY: PARKER TISCHAUSER PLOT NAME: PLOT SCALE: 1 IN:40 FT WISDOT/CADDS SHEET 42 LAYOUT NAME - 03

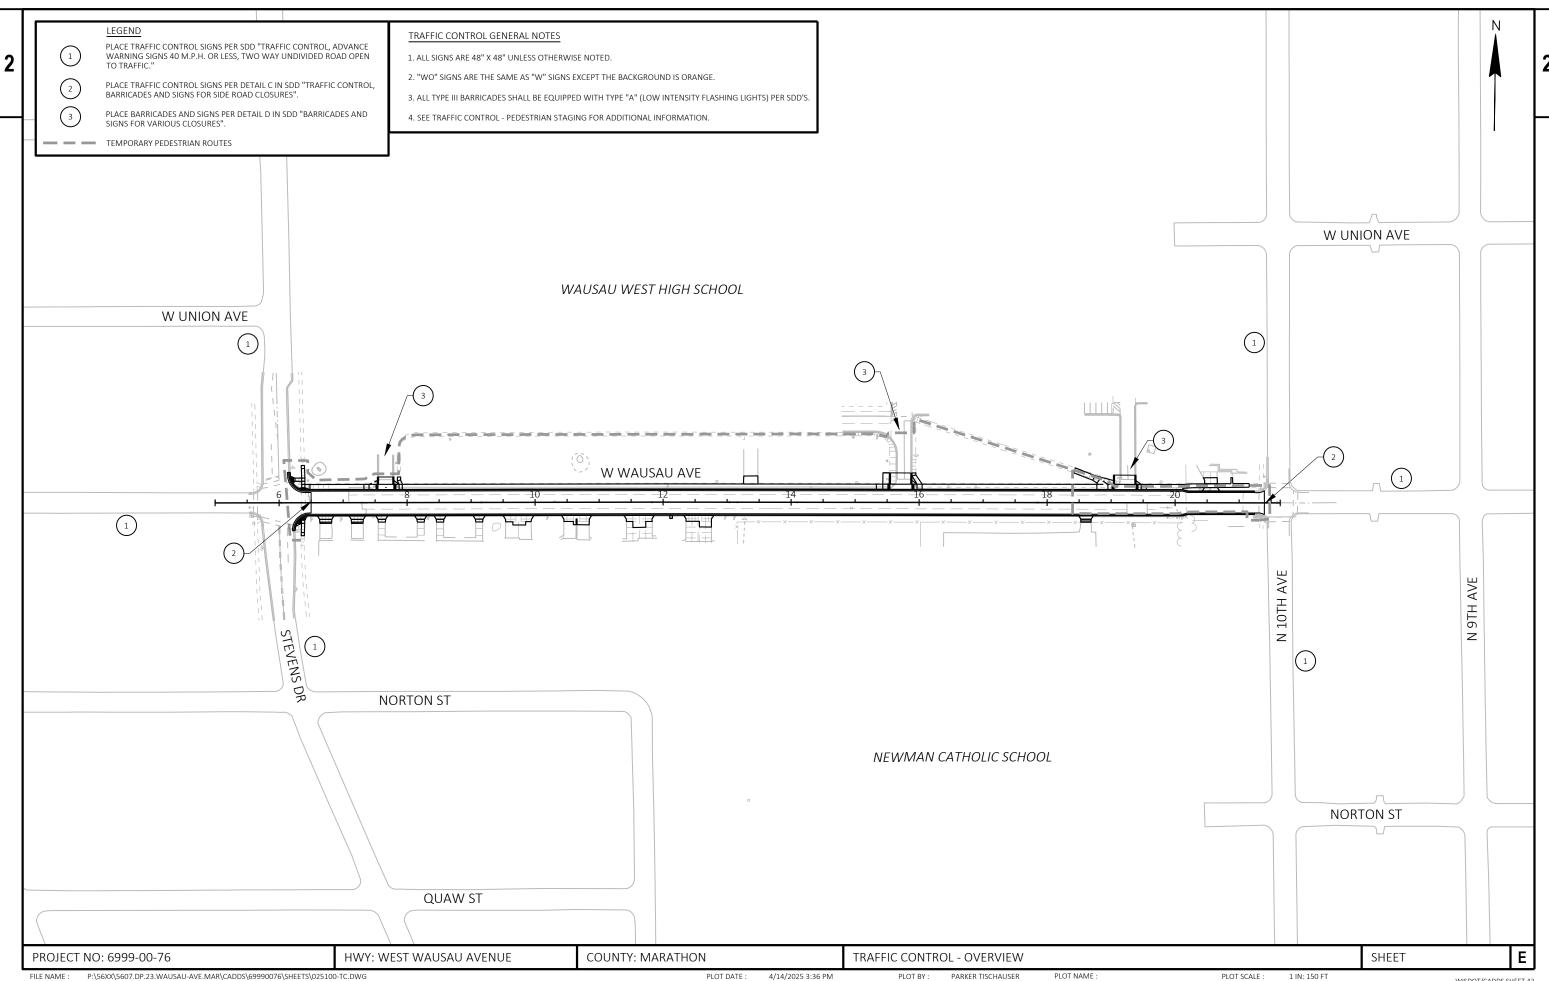

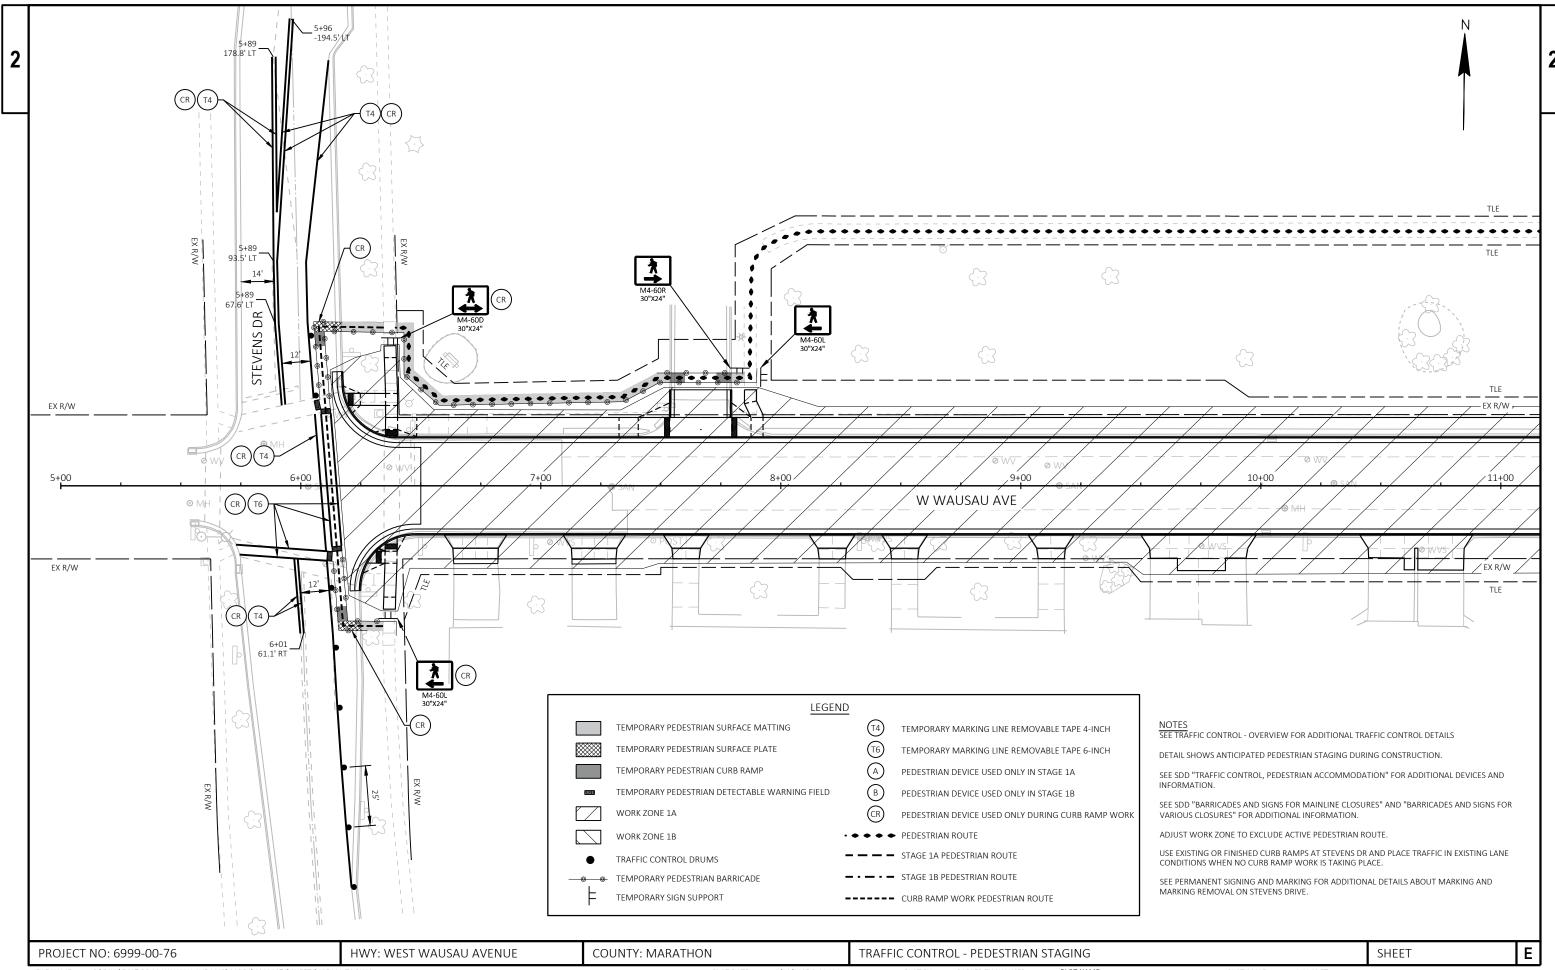


FILE NAME: PLOT DATE: 4/16/2025 8:41 AM PLOT BY: PARKER TISCHAUSER PLOT NAME: PLOT SCALE: 1 IN:40 FT WISDOT/CADDS SHEET 44

LAYOUT NAME - 01

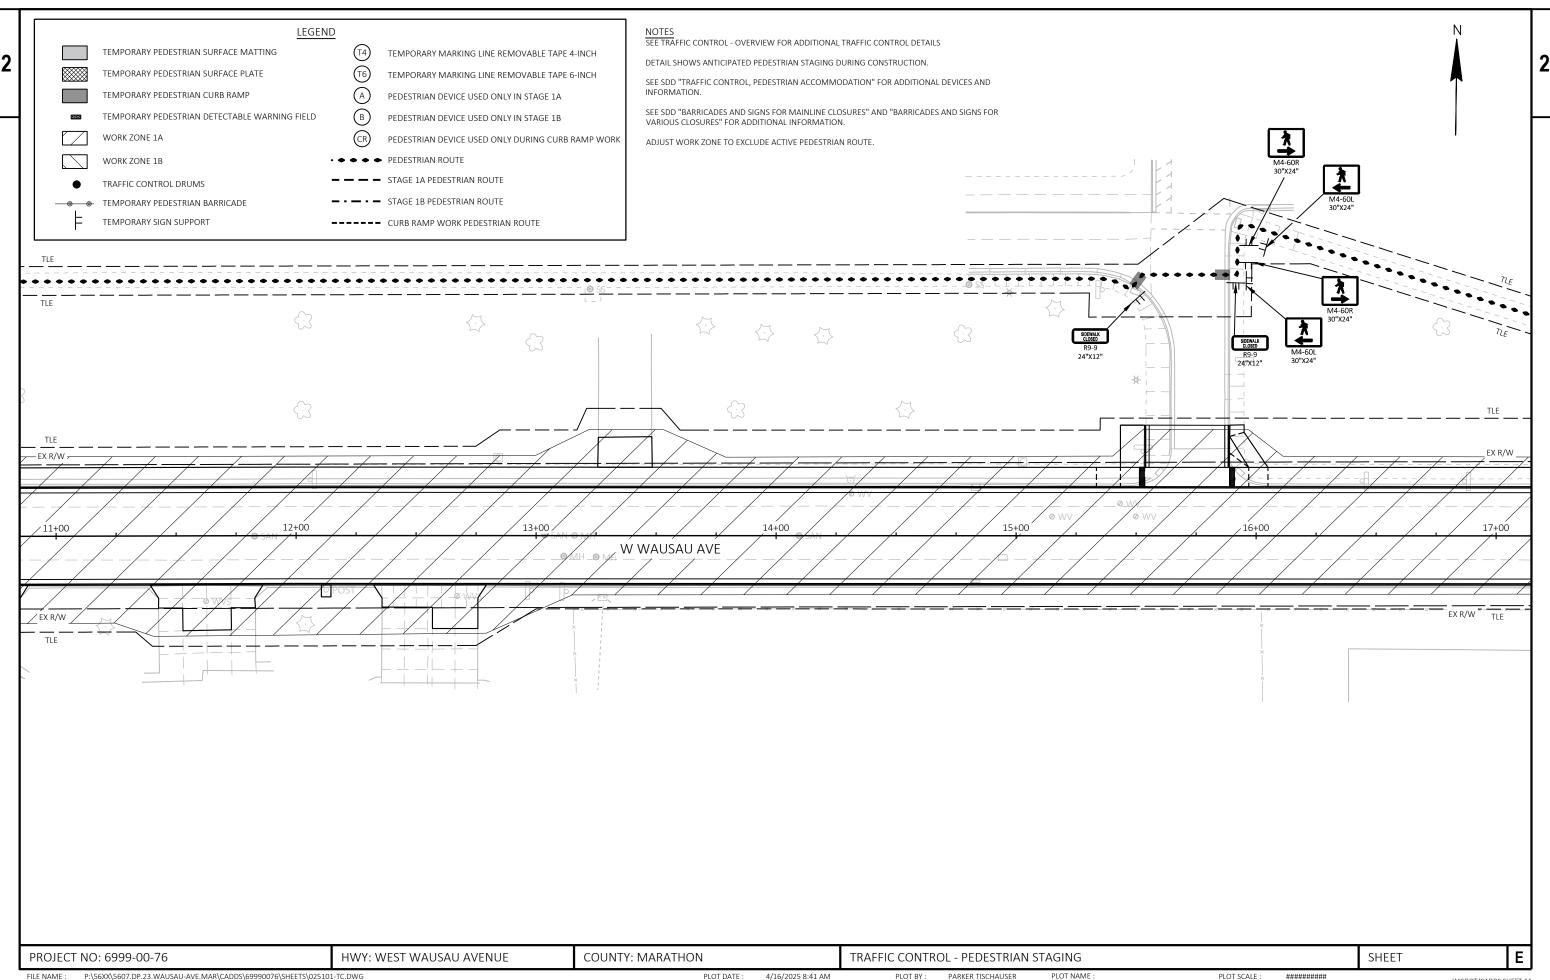

P:\56XX\5607.DP.23.WAUSAU-AVE.MAR\CADDS\69990076\SHEETS\025101-TC.DWG FILE NAME :

LAYOUT NAME - 02

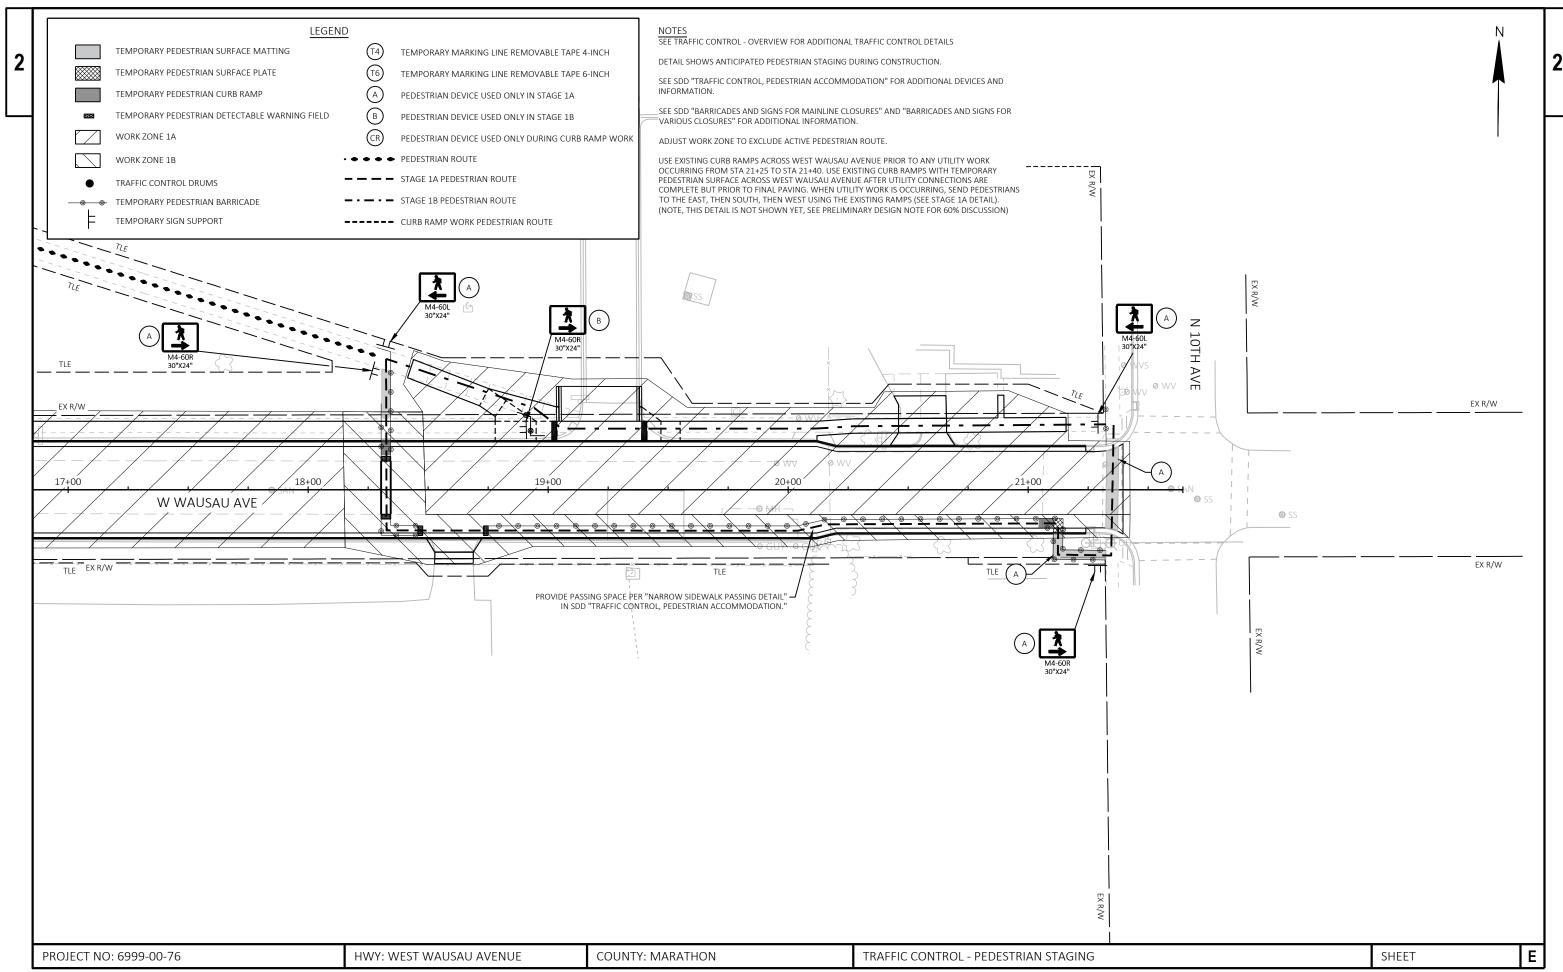

3

					6999-00-76
Line	Item	Item Description	Unit	Total	Qty
0002	201.0120	Clearing	ID	12.000	12.000
0004	201.0220	Grubbing	ID	12.000	12.000
0006	204.0100	Removing Concrete Pavement	SY	7,220.000	7,220.000
8000	204.0150	Removing Curb & Gutter	LF	275.000	275.000
0010	204.0155	Removing Concrete Sidewalk	SY	1,080.000	1,080.000
0012	204.0220	Removing Inlets	EACH	4.000	4.000
0014	204.0245	Removing Storm Sewer (size) 01. 12-Inch	LF	63.000	63.000
0016	204.0245	Removing Storm Sewer (size) 02. 24-Inch	LF	36.000	36.000
0018	204.9060.S	Removing (item description) 01. Hydrants	EACH	1.000	1.000
0020	204.9060.S	Removing (item description) 02. Sanitary Manholes	EACH	7.000	7.000
0022	204.9090.S	Removing (item description) 01. Sanitary Sewer 8-Inch	LF	90.000	90.000
0024	204.9090.S	Removing (item description) 02. Sanitary Sewer 10-Inch	LF	30.000	30.000
0026	204.9090.S	Removing (item description) 03. Sanitary Sewer 12-Inch	LF	1,414.000	1,414.000
0028	204.9090.S	Removing (item description) 04. Water Main 6-Inch	LF	199.000	199.000
0030	204.9090.S	Removing (item description) 05. Water Main 8-Inch	LF	1,296.000	1,296.000
0032	205.0100	Excavation Common	CY	3,797.000	3,797.000
0034	213.0100	Finishing Roadway (project) 01. 6999-00-76	EACH	1.000	1.000
0036	305.0120	Base Aggregate Dense 1 1/4-Inch	TON	5,000.000	5,000.000
0038	455.0605	Tack Coat	GAL	300.000	300.000
0040	460.2000	Incentive Density HMA Pavement	DOL	850.000	850.000
0042	460.5223	HMA Pavement 3 LT 58-28 S	TON	745.000	745.000
0044	460.5224	HMA Pavement 4 LT 58-28 S	TON	580.000	580.000
0044	465.0110	Asphaltic Surface Patching	TON	5.000	5.000
0048	465.0120	Asphaltic Surface Driveways and Field Entrances	TON	45.000	45.000
0050	520.8000	Concrete Collars for Pipe	EACH	1.000	1.000
0052	601.0411	Concrete Curb & Gutter 30-Inch Type D	LF	2,680.000	2,680.000
0054	602.0415	Concrete Sidewalk 6-Inch	SF	12,100.000	12,100.000
0054	602.0515		SF	136.000	136.000
		Curb Ramp Detectable Warning Field Natural Patina	SY		
0058	602.0810	Concrete Driveway 6-Inch		90.000	90.000
0060	602.0860	Concrete Driveway HES 6-Inch	SY	415.000	415.000
0062	608.0312	Storm Sewer Pipe Reinforced Concrete Class III 12-Inch	LF	86.000	86.000
0064	608.0324	Storm Sewer Pipe Reinforced Concrete Class III 24-Inch	LF	36.000	36.000
0066	611.0420	Reconstructing Manholes	EACH	3.000	3.000
0068	611.0535	Manhole Covers Type J-Special	EACH	5.000	5.000
0070	611.0624	Inlet Covers Type H	EACH	6.000	6.000
0072	611.3004	Inlets 4-FT Diameter	EACH	1.000	1.000
0074	611.3230	Inlets 2x3-FT	EACH	5.000	5.000
0076	611.8115	Adjusting Inlet Covers	EACH	1.000	1.000
0078	612.0902.S	Insulation Board Polystyrene (inch) 01. 2-Inch	SY	28.000	28.000
0800	619.1000	Mobilization	EACH	1.000	1.000
0082	621.0100	Landmark Reference Monuments	EACH	4.000	4.000
0084	624.0100	Water	MGAL	50.000	50.000
0086	625.0100	Topsoil	SY	2,900.000	2,900.000
8800	628.1504	Silt Fence	LF	480.000	480.000
0090	628.1520	Silt Fence Maintenance	LF	480.000	480.000
0092	628.1905	Mobilizations Erosion Control	EACH	4.000	4.000
0094	628.1910	Mobilizations Emergency Erosion Control	EACH	4.000	4.000
0096	628.2006	Erosion Mat Urban Class I Type A	SY	2,900.000	2,900.000
0098	628.7005	Inlet Protection Type A	EACH	9.000	9.000

6999-00-76

					0333 00 70
Line	Item	Item Description	Unit	Total	Qty
0100	628.7015	Inlet Protection Type C	EACH	10.000	10.000
0102	628.7020	Inlet Protection Type D	EACH	5.000	5.000
0104	630.0140	Seeding Mixture No. 40	LB	55.000	55.000
0106	630.0500	Seed Water	MGAL	65.000	65.000
0108	634.0814	Posts Tubular Steel 2x2-Inch X 14-FT	EACH	13.000	13.000
0110	634.0816	Posts Tubular Steel 2x2-Inch X 16-FT	EACH	2.000	2.000
0112	637.2210	Signs Type II Reflective H	SF	49.790	49.790
0114	637.2220	Signs Type II Reflective SH	SF	13.250	13.250
0116	637.2230	Signs Type II Reflective F	SF	2.750	2.750
0118	638.2102	Moving Signs Type II	EACH	3.000	3.000
0120	638.2602	Removing Signs Type II	EACH	17.000	17.000
0122	638.3000	Removing Small Sign Supports	EACH	14.000	14.000
0124	642.5001	Field Office Type B	EACH	1.000	1.000
0124	643.0300	Traffic Control Drums	DAY	600.000	600.000
0128	643.0420	Traffic Control Barricades Type III	DAY	1,500.000	1,500.000
0130	643.0705	Traffic Control Warning Lights Type A	DAY	1,875.000	1,875.000
0130	643.0900	Traffic Control Signs	DAY	2,040.000	2,040.000
0134	643.3150	Temporary Marking Line Removable Tape 4-Inch	LF	850.000	850.000
0134	643.3180	Temporary Marking Line Removable Tape 6-Inch	LF	230.000	230.000
0138	644.1430	Temporary Pedestrian Surface Plate	SF	110.000	110.000
0130	644.1440	Temporary Pedestrian Surface Matting	SF	1,050.000	1,050.000
0140	644.1601	Temporary Pedestrian Curb Ramp	DAY	130.000	130.000
0144	644.1605	Temporary Pedestrian Detectable Warning Field	SF	64.000	64.000
0144	644.1810	Temporary Pedestrian Bereclable Warning Fleid Temporary Pedestrian Barricade	LF	880.000	880.000
0148	646.1020	Marking Line Epoxy 4-Inch	LF LF	3,770.000	3,770.000
0146	646.3020	Marking Line Epoxy 4-Inch Marking Line Epoxy 8-Inch	LF LF	110.000	110.000
			EACH		
0152	646.5020	Marking Arrow Epoxy		1.000	1.000
0154	646.5120	Marking Word Epoxy	EACH	1.000	1.000
0156	646.6120	Marking Stop Line Epoxy 18-Inch	LF	85.000	85.000
0158	646.7120	Marking Diagonal Epoxy 12-Inch	LF	50.000	50.000
0160	646.7420	Marking Crosswalk Epoxy Transverse Line 6-Inch	LF	350.000	350.000
0162	646.9000	Marking Removal Line 4-Inch	LF	730.000	730.000
0164	646.9002	Marking Removal Line 6-Inch	LF	190.000	190.000
0166	646.9100	Marking Removal Line 8-Inch	LF	110.000	110.000
0168	646.9200	Marking Removal Line Wide	LF	95.000	95.000
0170	646.9300	Marking Removal Special Marking	EACH	2.000	2.000
0172	650.4000	Construction Staking Storm Sewer	EACH	6.000	6.000
0174	650.4500	Construction Staking Subgrade	LF	1,474.000	1,474.000
0176	650.5000	Construction Staking Base	LF	1,474.000	1,474.000
0178	650.5500	Construction Staking Curb Gutter and Curb & Gutter	LF	3,130.000	3,130.000
0180	650.9000	Construction Staking Curb Ramps	EACH	10.000	10.000
0182	650.9500	Construction Staking Sidewalk (project) 01. 6999-00-76	EACH	1.000	1.000
0184	650.9911	Construction Staking Supplemental Control (project) 01. 6999-00-76	EACH	1.000	1.000
0186	650.9920	Construction Staking Slope Stakes	LF	1,474.000	1,474.000
0188	690.0150	Sawing Asphalt	LF	305.000	305.000
0190	690.0250	Sawing Concrete	LF	330.000	330.000
0192	ASP.1T0A	9 11	HRS	1,200.000	1,200.000
0194	ASP.1T0G	On-the-Job Training Graduate at \$5.00/HR	HRS	600.000	600.000
0196	SPV.0030	Special 01. Fertilizer for Lawn Type Turf	CWT	2.000	2.000

					6999-00-76	
Line	Item	Item Description	Unit	Total	Qty	
0198	SPV.0060	Special 01. Research and Locate Existing Land Parcel Monuments	EACH	7.000	7.000	
0200	SPV.0060	Special 02. Verify and Replace Existing Land Parcel Monuments	EACH	7.000	7.000	
0202	SPV.0060	Special 03. Reestablish Section Corner Monuments	EACH	1.000	1.000	
0204	SPV.0060	Special 05. Temporary Water Service	EACH	1.000	1.000	
0206	SPV.0060	Special 06. Connecting Water Main	EACH	6.000	6.000	
0208	SPV.0060	Special 07. 8x8x6-Inch Tee	EACH	5.000	5.000	
0210	SPV.0060	Special 08. 8-Inch 45 Degree Bend	EACH	4.000	4.000	
0212	SPV.0060	Special 09. 6-Inch Valve & Valve Box	EACH	5.000	5.000	
0214	SPV.0060	Special 10. 8-Inch Valve & Valve Box	EACH	3.000	3.000	
0216	SPV.0060	Special 11. Standard Hydrant	EACH	2.000	2.000	
0218	SPV.0060	Special 12. Connecting Sanitary Sewer	EACH	4.000	4.000	
0220	SPV.0060	Special 13. Sanitary Manhole Covers Type J-Special	EACH	5.000	5.000	
0222	SPV.0060	Special 14. Manholes Sanitary 4-FT Diameter	EACH	5.000	5.000	
0224	SPV.0060	Special 15. Sanitary Sewer PVC Wyes	EACH	8.000	8.000	
0226	SPV.0060	Special 16. 6-Inch 45 Degree Bend	EACH	6.000	6.000	
0228	SPV.0060	Special 17. Construction Staking Water Main (6999-00-76)	EACH	1.000	1.000	
0230	SPV.0060	Special 18. Construction Staking Sanitary Sewer (6999-00-76)	EACH	1.000	1.000	
0232	SPV.0090	Special 01. Concrete Curb & Gutter 24-Inch Type D	LF	60.000	60.000	
0234	SPV.0090	Special 02. Concrete Curb & Gutter 12-Inch Sloped 24-Inch Type D	LF	30.000	30.000	
0236	SPV.0090	Special 03. Concrete Curb & Gutter HES 30-Inch Type D	LF	360.000	360.000	
0238	SPV.0090	Special 04. 6-Inch DI Water Main	LF	135.000	135.000	
0240	SPV.0090	Special 05. 8-Inch DI Water Main	LF	1,406.000	1,406.000	
0242	SPV.0090	Special 06. Water Laterals	LF	234.000	234.000	
0244	SPV.0090	Special 07. Sanitary Sewer 8-Inch	LF	30.000	30.000	
0246	SPV.0090	Special 08. Sanitary Sewer 10-Inch	LF	30.000	30.000	
0248	SPV.0090	Special 09. Sanitary Sewer 12-Inch	LF	1,413.000	1,413.000	
0250	SPV.0090	Special 10. Sanitary Sewer Laterals	LF	287.000	287.000	
0252	SPV.0090	Special 11. Polyethylene Encasement	LF	1,541.000	1,541.000	
0254	SPV.0180	Special 01. Preparing Topsoil for Lawn Type Turf	SY	2,900.000	2,900.000	

ALK
COMMENTS

CLEARING AND GRUBBING ITEMS

CATEGORY	STATION	OFFSET	201.0120 CLEARING ID	201.0220 GRUBBING ID
0010				
	8+40	RT	12	12
TOTALS			12	12

NOTE:

DO NOT REMOVE ANY ADDITIONAL TREES WITHOUT APPROVAL OF THE ENGINEER.

					204.0100	204.0150	204.0155	
					REMOVING	REMOVING	REMOVING	
					CONCRETE	CURB &	CONCRETE	
					PAVEMENT	GUTTER	SIDEWALK	
CATEGORY	STATION	TO	STATION	OFFSET	SY	LF	SY	COMMENTS
0010								
	6+15	-	21+16	LT		150	1,060	
	6+22	-	7+36	RT		125	20	
	6+50	-	21+40	LT & RT	6,710			W WAUSAU AVE
	6+50	-	21+40	LT & RT	510			DRIVEWAYS
TOTALS					7,220	275	1,080	

REMOVAL ITEMS

REMOVING DRAINAGE ITEMS

CATECODY	STATION	TO	CTATION	OFFEET	204.0220 REMOVING INLETS	204.0245.01 REMOVING STORM SEWER 12-INCH	204.0245.02 REMOVING STORM SEWER 24-INCH
CATEGORY	STATION	TO	STATION	OFFSET	EACH	LF	<u>LF</u>
0010							
	10+02	-	10+10	RT	1	12	
	10+05	-	10+10	LT	1	29	
	14+83	-	14+94	RT	1	15	
	14+83	-	14+94	LT	1	7	36
TOTALS					4	63	36

BASE AGGREGATE ITEMS

DIVISION	FROM/TO STATION	LOCATION	205.0100 COMMON EXCAVATION CUT (CY)	- SALVAGED/UNUSABLE PAVEMENT MATERIAL (CY)	AVAILABLE MATERIAL (CY) (2)	UNEXPANDED FILL (CY)	EXPANDED FILL (CY) (3) FACTOR 1.25	MASS ORDINATE +/- (CY) (4)	WASTE (CY)
1									
WEST WAUSAU AVE	6+50 - 21+39.50		3,797	1,475	2,322	39	49	2,274	2,274
		·			•				
TOTALS			3,797	1,475	2,322	39	49	2,274	2,274

NOTES:

- (1) SALVAGED/UNUSABLE PAVEMENT MATERIAL IS INCLUDED IN CUT.
- (2) AVAILABLE MATERIAL = CUT SALVAGED/UNUSABLE PAVEMENT MATERIAL
- (3) EXPANDED FILL FACTOR = 1.25
- (4) THE MASS ORDINATE + OR QTY CALCULATED FOR THE DIVISION. PLUS QUANTITY INDICATES AN EXCESS OF MATERIAL WITHIN THE DIVISION. MINUS INDICATES A SHORTAGE OF MATERIAL WITHIN THE DIVISION.
- (5) FACTORS USED TO COMPUTE ANTICIPATED WASTE AND THE COMPUTED WASTE VOLUME IDENTIFIED ARE FOR GENERAL INFORMATION ONLY.

PROJECT NO: 6999-00-76

HWY: WEST WAUSAU AVE

COUNTY: MARATHON

MISCELLANEOUS QUANTITIES

SHEET

FILE NAME: P:\S6XX\S6607.DP.23.WAUSAU-AVE.MAR\CADDS\69990076\SHEETS\\030201-MQ.DWG

PLOT BY: PARKER TISCHAUSER
PLOT BY: PARKER TISCHAUSER
PLOT NAME: PILOT NAME: 01

WISDOT/CADDS SHEET 42

WISDOT/CADDS SHEET 42

		5 STEVENS DR - 45 W WAUSAU AVE 5 45	7+51 - 7+70 RT 15 8+12 - 8+31 RT 15 8+42 - 8+61 RT 15 9+03 - 9+22 RT 15 9+50 - 9+98 RT 58 10+41 - 10+88 RT 58 11+39 - 11+86 RT 65 12+32 - 12+80 RT 65 15+53 - 15+89 LT 33 18+49 - 18+73 RT 17 19+03 - 19+39 LT 33 20+42 - 20+70 LT 48
CATEGORY STATION TO STAT 0010 6+13 - 6+1 6+13 - 21+ 7+54 - 7+5 15+64 - 15+ 19+04 - 19+ TOTALS	CONCRETE CURB & CONCRETE CURB	0411 SPV.0090.03 TE CURB & CONCRETE CURB & 30-INCH GUTTER HES DE D 30-INCH TYPE D F LF COMMENTS 10 STEVENS DR 1690 360 W WAUSAU AVE 1690 SCHOOL DRIVEWAY 1690 SCHOOL DRIVEWAY 1690 360	SIDEWALK ITEMS 602.0415 602.0515 CURB RAMP DETECTABLE WARNING FIELD NATURAL PATINA SIDEWALK
0010 6+16 10+03 10+05 10+10 13+11 13+25 14+91 14+93 14+94 15+08 15+09	STORM SEWER STRUCTURE ITEMS 611.0420 611.0624 611.3004	611.3230 611.0535 611.8115 MANHOLE COVERS TYPE ADJUSTING NLETS 2X3-FT J-SPECIAL INLET COVERS EACH EACH 1	STORM SEWER PIPE ITEMS S20.8000 608.0312 608.0324 STORM SEWER PIPE STORM SE

FILE NAME : P:\56XX\5607.DP.23.WAUSAU-AVE.MAR\CADDS\69990076\SHEETS\030201-MQ.DWG LAYOUT NAME - 02 PLOT BY: PARKER TISCHAUSER PLOT DATE : 4/14/2025 3:41 PM PLOT NAME : PLOT SCALE : 1" = 1' WISDOT/CADDS SHEET 42

WATER ITEM 624.0100 WATER WATER MGAL 0010 PROJECT 50 TOTAL 50	0010 6+13	FROSION CONTROL ITEMS 628.1504 628.1520 628.7005 INLET PROTECTION TYPE A EACH	628.7015 628.7020 INLET INLET PROTECTION PROTECTION TYPE C TYPE D EACH EACH 8 4 2 1 10 5	EROSION CONTROL MOBILIZATION ITEMS 628.1905 628.1910 MOBILIZATIONS EROSION EROSION CONTROL CONTROL CATEGORY LOCATION EACH 0010 PROJECT 4 4 TOTALS 4 4
0010 6+13	RESTORATION 628.2006 EROSION MAT URBAN CLASS 1 TYPE A SY SY SY SY SY SY SY SY	630.0140 630.0500 SPV.0030.01 SPV.0180.01 PREPARING TOPSOIL		MOVING SIGNS ITEM 638.2102 MOVING SIGNS TYPE II
	SIGN DIMENSION W X H	PARKING, DBL ARROW 1 3.00 PARKING, DBL ARROW 1 3.00 STOP 1 5.18 ALL WAY 0.75 NO PARKING 1 3.00	637.2220 637.2230 638.2602 REMOVING SIGNS TYPE II REMOVING SIGNS TYPE II REMOVING SOUPPORT SF SF SF EACH EACH 1 1 1 6.63 1.38 1 1 1 1 1 1 1 1 1 1 1 1 1 1 1 1 1 1	NG GN TS SIGN MOUNTED ON SAME

PLOT DATE : 4/14/2025 3:42 PM

PLOT BY: PARKER TISCHAUSER

PLOT NAME :

PLOT SCALE : 1" = 1'

TRAFFIC CONTROL ITEMS	
643.0300 643.0420 643.0705 643.0900 TRAFFIC CONTROL STAGE TRAFFIC CONTROL DURATION DRUMS CATEGORY STAGE LOCATION DAYS NO. DAY NO. DAY NO. DAY NO. DAY	
0010 1A TEMPORARY PEDESTRIAN ACCOMODATIONS 50 10 500 12 600 1B TEMPORARY PEDESTRIAN ACCOMODATIONS 10 10 100 9 90 1 MAINLINE CLOSURE 75 20 1,500 25 1,875 18 1,350 STAGE 1 TOTALS 600 1,500 1,875 2,040 TOTALS 600 1,500 1,875 2,040	
TEMPORARY PEDESTRIAN ITEMS 643.3180 644.1430 644.1440 644.1601 644.1605 644.1810 TEMPORARY MARKING LINE TEMPORARY TEMPORARY MARKING LINE TEMPORARY TEMPORARY REMOVABLE TAPE PEDESTRIAN PEDESTRIAN TEMPORARY PEDESTRIAN DETECTABLE PEDESTRIAN 6-INCH SURFACE PLATE SURFACE MATTING CURP AMP CATEGORY STATION TO STATION OFFSET LE SE SE NO DAY SE LE	
CATEGORY STATION TO STATION OFFSET LF SF SF NO. DAY SF LF 0010 5+75 - 21+39 LT & RT 230 110 1,050 8 130 64 880 TOTALS 230 110 1,050 130 64 880	
TEMPORARY PAVEMENT MARKING ITEMS 643.3150 646.9000 646.9002 646.9100 646.9200 646.9300 TEMPORARY MARKING LINE MARKING REMOVAL LINE MARKING REMOVAL LINE MARKING REMOVAL LINE MARKING REMOVAL LINE	
643.3150 646.9000 646.9000 646.9100 646.9200 646.9300 TEMPORARY MARKING LINE REMOVABLE TAPE 4-INCH CATEGORY STATION TO STATION OFFSET LF LF LF LF LF LF LF LF LF L	
CATEGORY STATION TO STATION STATION TO STATION STA	
February	

PLOT DATE : 4/14/2025 3:42 PM

PLOT BY: PARKER TISCHAUSER

PLOT SCALE : 1" = 1'

	<u>CATEGORY</u> 0010	6+13 - 6+: 6+50 - 21+ 7+32 - 7+: 15+33 - 16+	50 LT & RT 24 LT & RT 93 LT	STAKING STORM SEWER		650.5000	650.5500 CONSTRUCTION STAKING CURB GUTTER AND CURB & GUTTER LF 90 2,950 24 36	650.9000 CONSTRUCTION	650.9500.01 CONSTRUCTION STAKING SIDEWALK (6999-00-76) EACH	650.9911.01 CONSTRUCTION STAKING SUPPLEMENTAL CONTROL (6999-00-76 EACH	650.9920 CONSTRUCTION STAKING SLOPE) STAKES LF 1,474	COMMENTS SCHOOL DRIVEWAY SCHOOL DRIVEWAY	-		
	TOTALS	18+78 - 19+ PROJECT		 6	1,474	 1,474	3,130	10	1	1	 1,474	SCHOOL DRIVEWAY	-		
SAWING ITEMS 690.0150	SAWING	_		CATEGORY 0010 TOTALS	LOCA	SECTION CORNI FION / 26, T29N, R7E	DESCRIPTION	621.0100 LANDMARK REFERENCE MONUMENTS EACH	SPV.0060.03 REESTABLISH SECTION CORNER MONUMENTS EACH 1			ATEGORY STATION TO	NG LAND PARCEL I O STATION OFF: 21+40 LT &	SPV.0060.0 RESEARCH A LOCATE EXIST LAND PARC MONUMEN SET EACH	D1 SPV.0060.02 ND VERIFY AND TING REPLACE EXISTING EL LAND PARCEL
REMOVING HYDRANTS 204.9060.S REMOVIN HYDRANT CATEGORY STATION OFFSET EACH 0020 14+31 LT 1 TOTAL 1	NG TS			_(O020 7+2 9+2 10+4 11+ 13+	NG SANITARY M ATION OFFSET 29.57 0.4' RT 16.10 0.1' LT 30.45 1' LT 82.65 0.2' RT 05.56 0.2' LT 09.51 0' RT	204.9060.S.02 REMOVING SANITARY MANHOLES	_			7 STATION TO 7+18 - 7+30 - 9+16 - 10+30 - 11+: 11+83 -	O STATION OFFSET 7+30 LT & RT 9+16 LT & RT 10+30 LT & RT 11+83 LT & RT 83 RT 13+04 LT & RT	ANITARY SEWER 204.9090.S.01 REMOVING SANITARY SEWER 8-INCH LF 30 30 30 30	204.9090.S.02 REMOVING SANITARY SEWER 10-INCH LF 	204.9090.S.03 REMOVING SANITARY SEWER 12-INCH LF 12 187 114 153 121

PLOT DATE : 4/14/2025 3:42 PM

PLOT NAME :

PLOT SCALE : 1" = 1'

WISDOT/CADDS SHEET 42

REMOVING WATER MAIN	STATION BOARD POLYSTYRENE 612.0902.5.01	TEMPORARY WATER SERVICE SPV.0060.05 TEMPORARY WATER SERVICE CATEGORY LOCATION EACH 0020 PROJECT 1 TOTAL 1
CONNECTING WATER MAIN SPV.0060.06 CONNECTING WATER MAIN	WATER MAIN TEE SPV.0060.07 8X8X6-INCH TEE CATEGORY STATION OFFSET EACH 0020 8+89.81 8.50' LT 1 10+19.33 8.50' LT 1 11+50 8.50' LT 1 15+43.35 8.50' LT 1 16+49.97 8.50' LT 1 TOTAL 5	SPV.0060.08 SPV.0060.16
SPV.0060.09 SPV.0060.10	STANDARD HYDRANT SPV.0060.11 STANDARD HYDRANT CATEGORY STATION OFFSET EACH O020 11+50 8.50' LT 1 16+49.97 8.50' LT 1 TOTAL 2	WATER MAIN ITEMS SPV.0090.04 SPV.0090.05 SPV.0090.11 SPV.0090.05 SPV.0090.11 SPV.0090.05 SPV.0090.11 SPV.0090.05 SPV.0090.05 SPV.0090.11 SPV.0090.05 SPV.0090.01 SPV.0090.05 SPV.0090.
PROJECT NO: 6999-00-76 HWY: WEST WAUSAU AVE FILE NAME: P:\56XX\5607.DP.23.WAUSAU-AVE.MAR\CADDS\69990076\SHEETS\030201-MQ.DWG LAYOUT NAME - 06	COUNTY: MARATHON PLOT DATE: 4/14/2025 3:42 PM PLOT BY: PARKER TISCHAUSER	PLOT NAME : PLOT SCALE : 1" = 1' WISDOT/CADDS SHEET 42

WATER LATERALS

CATEGORY	STATION	OFFSET	SPV.0090.06 WATER LATERALS LF
0020			
	8+33	LT & RT	39
	8+36	LT & RT	39
	9+76	LT & RT	39
	10+68	LT & RT	39
	11+63	LT & RT	39
	12+68	LT & RT	39
TOTAL			234

CONNECTING SANITARY SEWER

_CATEGORY	STATION	OFFSET	SPV.0060.12 CONNECTING SANITARY SEWE EACH
0020			
0020	7+18	RT	1
	13+04	RT	1
	14+09	LT	1
	21+31	LT	1
TOTAL			4

SANITARY SEWER PVC WYES

CATEGORY	STATION	OFFSET	SPV.0060.15 SANITARY SEWER PVC WYES EACH
0020			
	7+09	RT	1
	8+31	RT	1
	8+38	RT	1
	9+74	RT	1
	10+25	LT	1
	10+66	RT	1
	11+60	RT	1
	12+65	RT	1
TOTAL			8

SANITARY SEWER PIPE ITEMS

						SPV.0090.07	SPV.0090.08 SANITARY SEWE	SPV.0090.09
				FROM	то	8-INCH	10-INCH	12-INCH
CATEGORY	STATION	TO	STATION	STRUCTURE	STRUCTURE	LF	LF	LF
0020								
	7+17.52	-	7+29.52	EX PIPE	5			12
	7+29.52	-	10+15.00	5	4			285
	10+15.00	-	13+03.56	4	3			289
	1	3+03.5	6	3	EX PIPE	30		
	13+03.56	-	14+09.55	3	2			106
	1	4+09.5	5	2	EX PIPE		30	
	14+09.55	-	17+84.76	2	1			375
	17+84.76	-	21+30.50	1	EX PIPE			346
TOTALS						30	30	1,413

SANITARY SEWER LATERALS

_CATEGORY	STATION	OFFSET	SPV.0090.10 SANITARY SEWER LATERALS LF
0020			
	7+09	RT	42
	8+31	RT	35
	8+38	RT	35
	9+74	RT	35
	10+25	LT	35
	10+66	RT	35
	11+60	RT	35
	12+65	RT	35
TOTAL			287


UTILITY STAKING ITEMS

		SPV.0060.17	SPV.0060.18
		CONSTRUCTION	CONSTRUCTION
		STAKING WATER	STAKING SANITARY
		MAIN (6999-00-76)	SEWER (6999-00-76)
CATEGORY	STATION	EACH	EACH
0020			
	PROJECT	1	1
TOTALS		1	1

COUNTY: MARATHON MISCELLANEOUS QUANTITIES Ε PROJECT NO: 6999-00-76 HWY: WEST WAUSAU AVE SHEET

0020

TOTALS

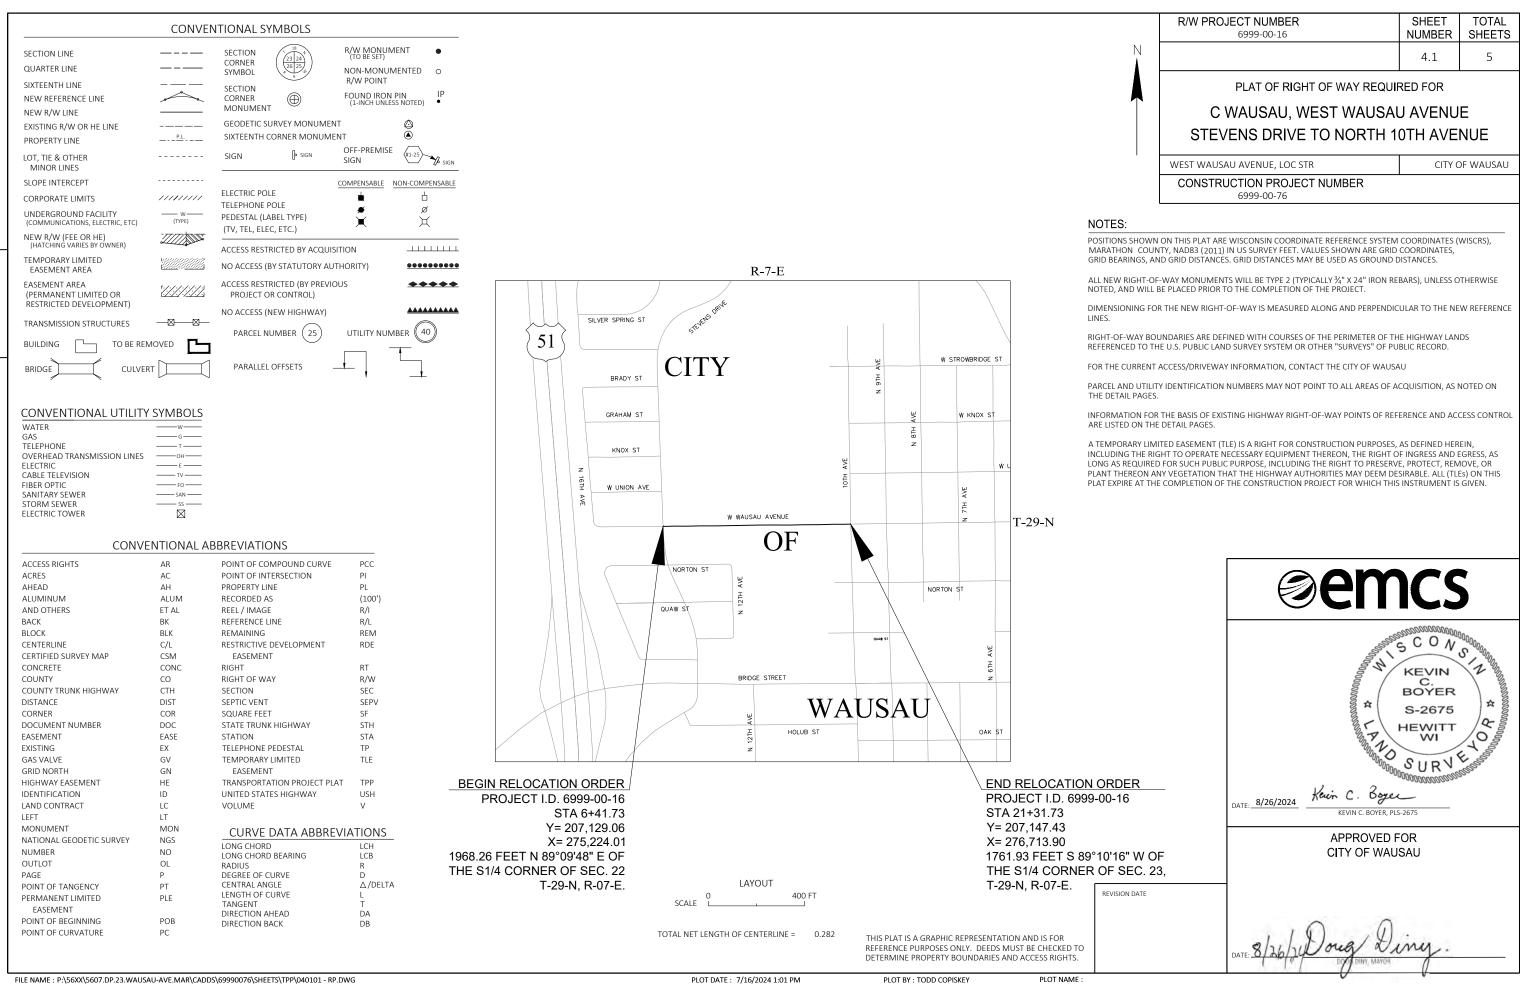

SCHEDULE OF LANDS & INTERESTS REQUIRED

OWNER'S NAMES ARE SHOWN FOR REFERENCE PURPOSES ONLY AND ARE SUBJECT TO CHANGE PRIOR TO THE TRANSFER OF LAND INTERESTS TO THE CITY OF WAUSAU.

PARCEL	CLIEFT NUMBER	OWNERC	INTERESTS REQUIRED		R/W SF REQUIRED					
NUMBER	SHEET NUMBER	OWNERS	INTERESTS REQUIRED	NEW	EXISTING	TOTAL	TOTAL REMAINING	TLE S.F.		
1	4.3, 4.4, & 4.5	WAUSAU SCHOOL DISTRICT, A WISCONSIN MUNICIPAL SUBDIVISION OF THE STATE OF WISCONSIN	TLE					36370		
2	4.3	KSW RENTALS, LLC.	TLE					738		
3	4.3	ASPEN VIEW PROPERTIES, LLC.	TLE					860		
4	4.3	TIMOTHY D. TREU AND KAY D. TREU	TLE					764		
6	4.3	AARON J. DECKER, TRUSTEE OF THE AARON J. DECKER REVOCABLE TRUST DATED MAY 27	TLE					894		
7	4.3	WTH, LLC., A WISCONSIN LIMITED LIABILITY COMPANY	TLE					1464		
8	4.4	WTH, MS, LLC., A WISCONSIN LIMITED LIABILITY COMPANY	TLE					1176		
9	4.4, & 4.5	NEWMAN CATHOLIC SCHOOLS, INC.	TLE					1184		
11	4.5	VICTORIA P. BALLARD	TLE					1043		
12	4.5	GINGER L. MCDONALD	TLE					160		
200	4.3	WAUSAU WATER WORKS (WATER)	NO RELEASE REQUIRED, INTEREST MERGED							
201	4.3, & 4.4	WAUSAU WATER WORKS (SANITARY SEWER)	NO RELEASE REQUIRED, INTEREST MERGED							
202	4.3, 4.4, & 4.5	TDS METROCOM LLC (COMMUNICATION)	RELEASE OF RIGHTS			-				
203	4.5	WISCONSIN PUBLIC SERVICE CORPORATION (GAS)	RELEASE OF RIGHTS							
204	4.5	CITY COUNTY IT COMMISSION (COMMUNICATION)	RELEASE OF RIGHTS							


FILE NAME : 040101 - RP.DWG LAYOUT NAME - 4.02 PLOT DATE : 7/16/2024 1:01 PM


PLOT BY: TODD COPISKEY

PLOT NAME :

PLOT SCALE :

WISDOT/CADDS SHEET 75

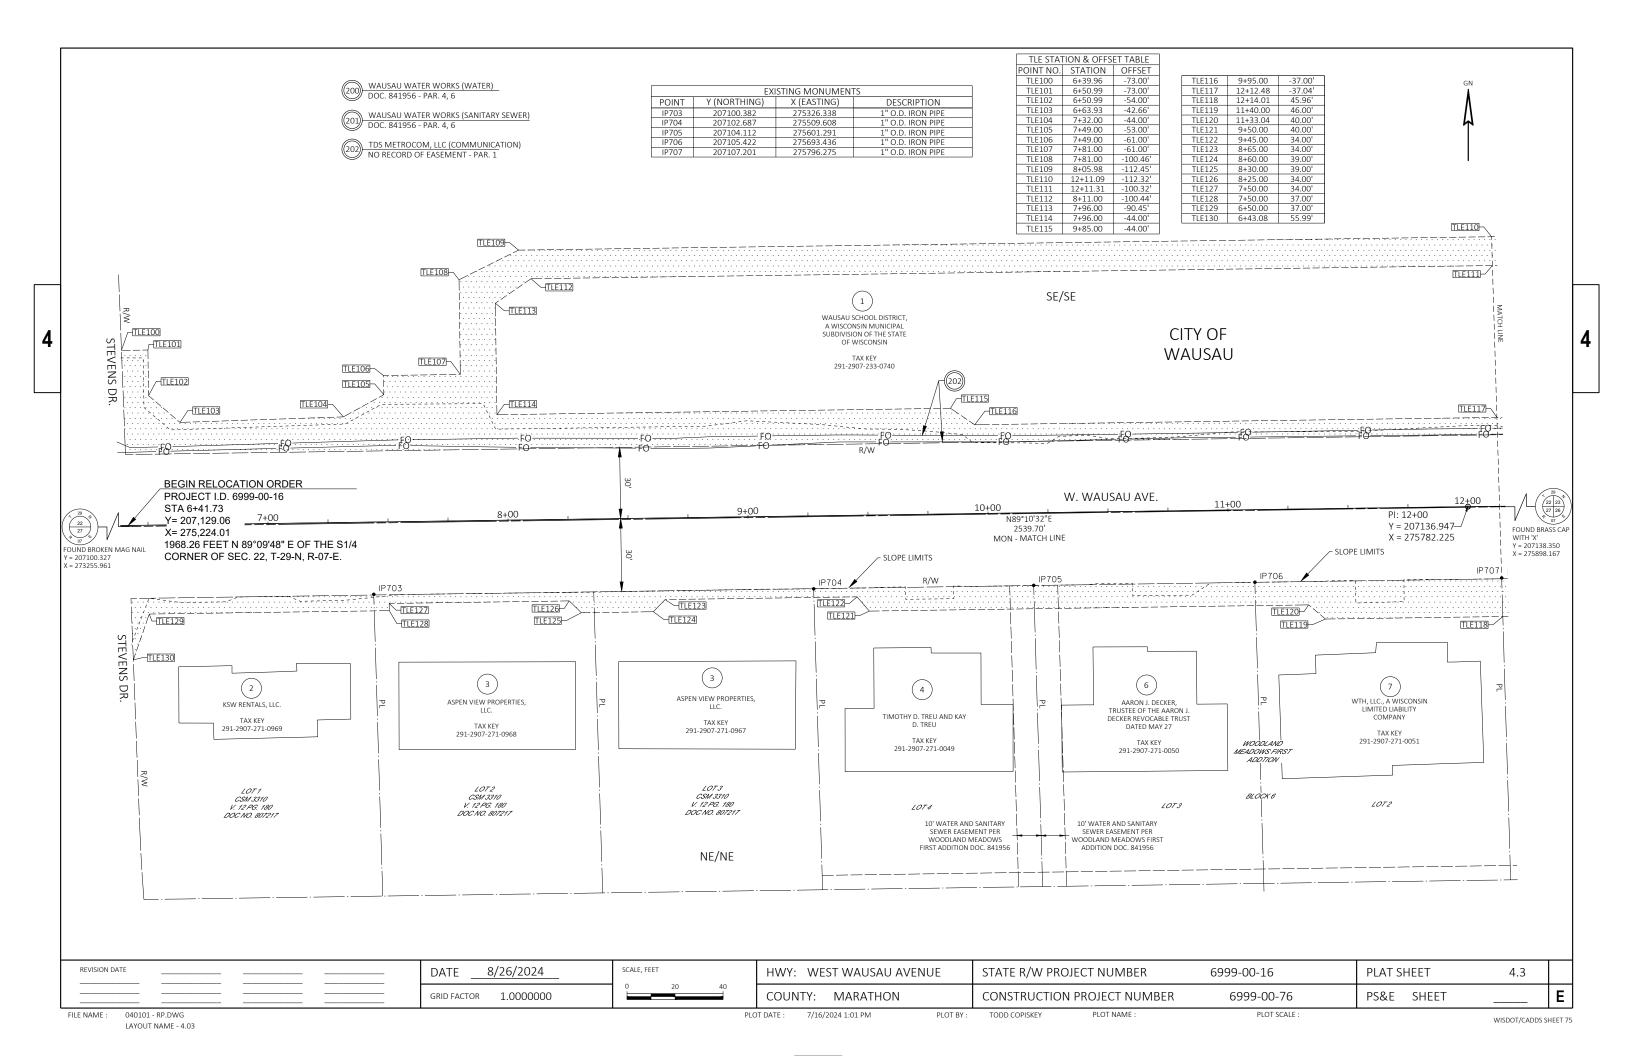

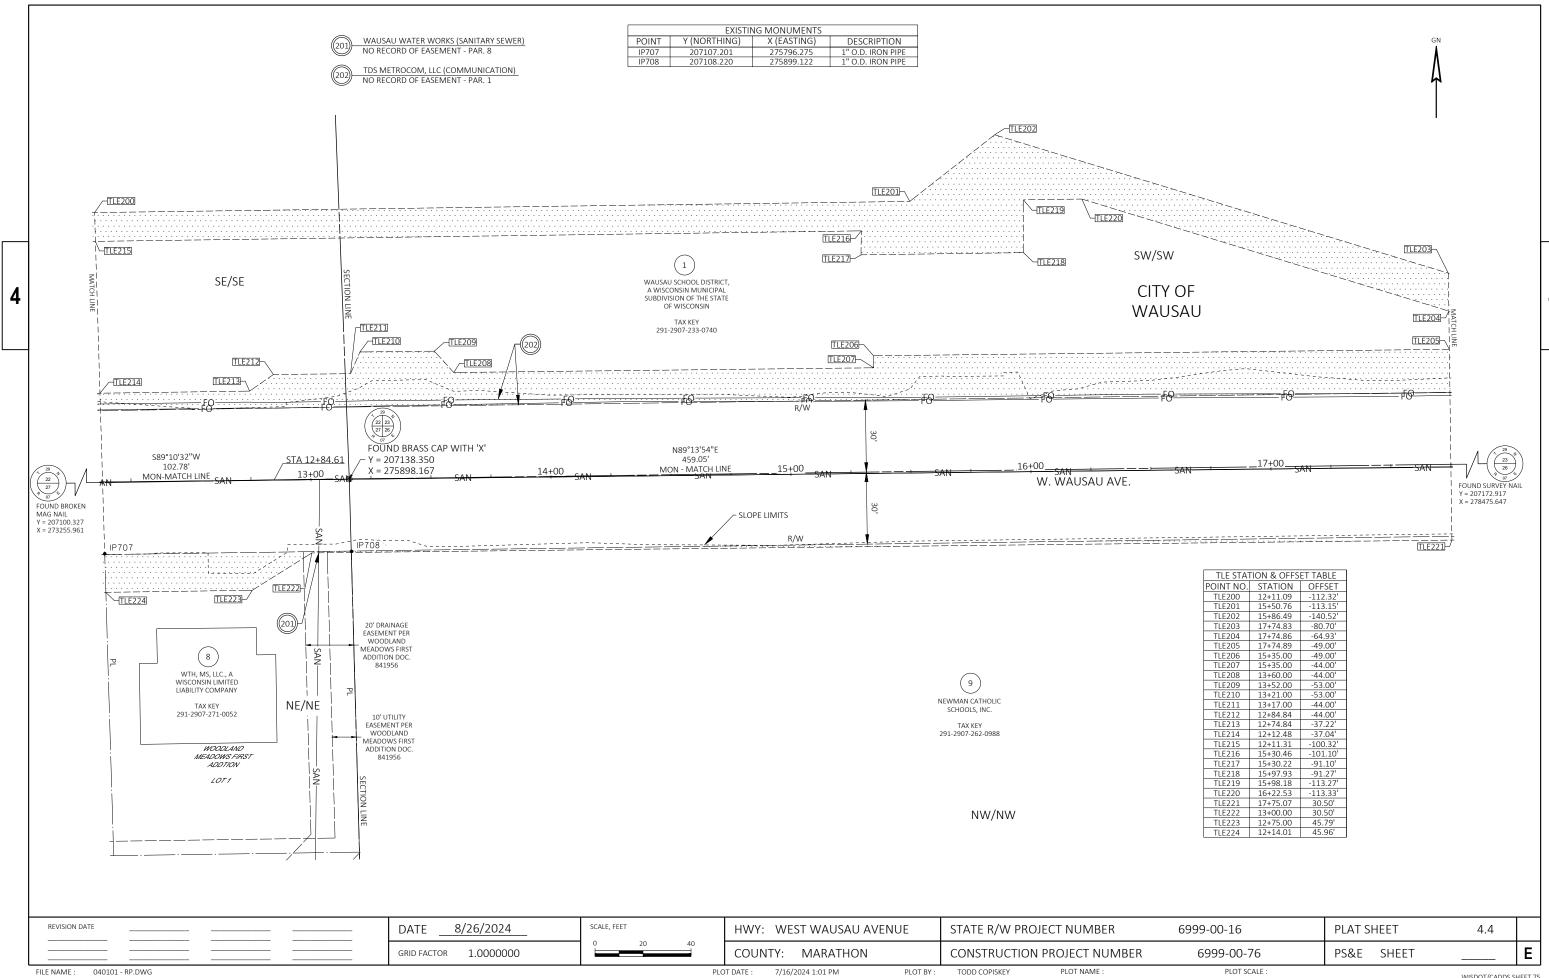


LAYOUT NAME - 4.04


WISDOT/CADDS SHEET 75


EXISTING MONUMENTS TDS METROCOM, LLC (COMMUNICATION)
NO RECORD OF EASEMENT - PAR. 1 Y (NORTHING) X (EASTING) DESCRIPTION DOC. 1779632 - PAR. 1 WISCONSIN PUBLIC SERVICE CORPORATION (GAS) NO RECORD OF EASEMENT - PAR. 9, 12 CITY COUNTY IT COMMISSION (COMMUNICATION) NO RECORD OF EASEMENT - PAR. 1, 9 END RELOCATION ORDER PROJECT I.D. 6999-00-16 STA 21+31.73 Y= 207,147.43 X= 276,713.90 1761.93 FEET S 89°10'16" W OF THE SW/SW S1/4 CORNER OF SEC. 23, T-29-N, WAUSAU SCHOOL DISTRICT, -TLE300 R-07-E. 10' TDS METROCOM LLC (11) OF WISCONSIN EASEMENT Z. TAX KEY 291-2907-233-0740 10TH VICTORIA P. BALLARD TAX KEY TLE309 291-2907-233-0763 TLE301 TLE302 TLE308 AVE TLE311 TLE310 TLE305-TLE304 R/W N89°13'54"E N89°13'54"E 2118.66 459.05' MATCH LINE - MON 19+00_ MON - MATCH LIN FOUND SURVEY NAIL Y = 207172.917 X = 278475.647 FOUND BRASS CAP WITH 'X' Y = 207138.350 X = 275898.167 - SLOPE LIMITS TLE312 Z TLE319 TLE316 TLE313 TLE317 TLE321 10TH (12) TLE318 TLE315 -TLE314 GINGER L. MCDONALD AVE. TAX KEY 291-2907-262-0159 TLE STATION & OFFSET TABLE (9) POINT NO. STATION OFFSET NW/NW TLE300 17+74.83 -80.70'
TLE301 18+55.76 -55.00'
TLE302 19+47.00 -55.00' GRANT SCHOOL ADDITION TO THE SCHOOLS, INC. CITY OF WAUSAU, WISCONSIN BLOCK 9 TLE303 19+60.00 -36.00' TLE304 20+35.00 -36.00' 30' STORM SEWER EASEMENT CITY OF WAUSAU LOT 7 291-2907-262-0988 V. 479 PG. 372 DOC. 537736 TLE305 20+42.00 -44.00' TLE306 21+00.00 -44.00' TLE307 21+31.36 -31.86' CITY OF WAUSAU TLE308 17+74.86 -64.93' TLE309 18+10.00 -53.77'
TLE310 18+10.00 -49.00' 17+74.89 -49.00' TLE312 21+32.10 31.00' TLE313 18+80.00 31.00' 1016 TI F313 TLE314 18+75.00 36.00' TLE317 17+75.07 30.50' TLE318 20+75.00 28.27'
TLE319 20+75.00 31.00'
TLE320 20+17.06 28.39'
TLE321 20+17.09 31.00' REVISION DATE 8/26/2024 SCALE, FEET DATE HWY: WEST WAUSAU AVENUE STATE R/W PROJECT NUMBER 6999-00-16 PLAT SHEET 4.5 Ε GRID FACTOR 1.0000000 COUNTY: MARATHON CONSTRUCTION PROJECT NUMBER 6999-00-76 PS&E SHEET 7/16/2024 1:01 PM TODD COPISKEY PLOT NAME PLOT SCALE FILE NAME : 040101 - RP.DWG PLOT BY: PLOT DATE:

WISDOT/CADDS SHEET 75

4

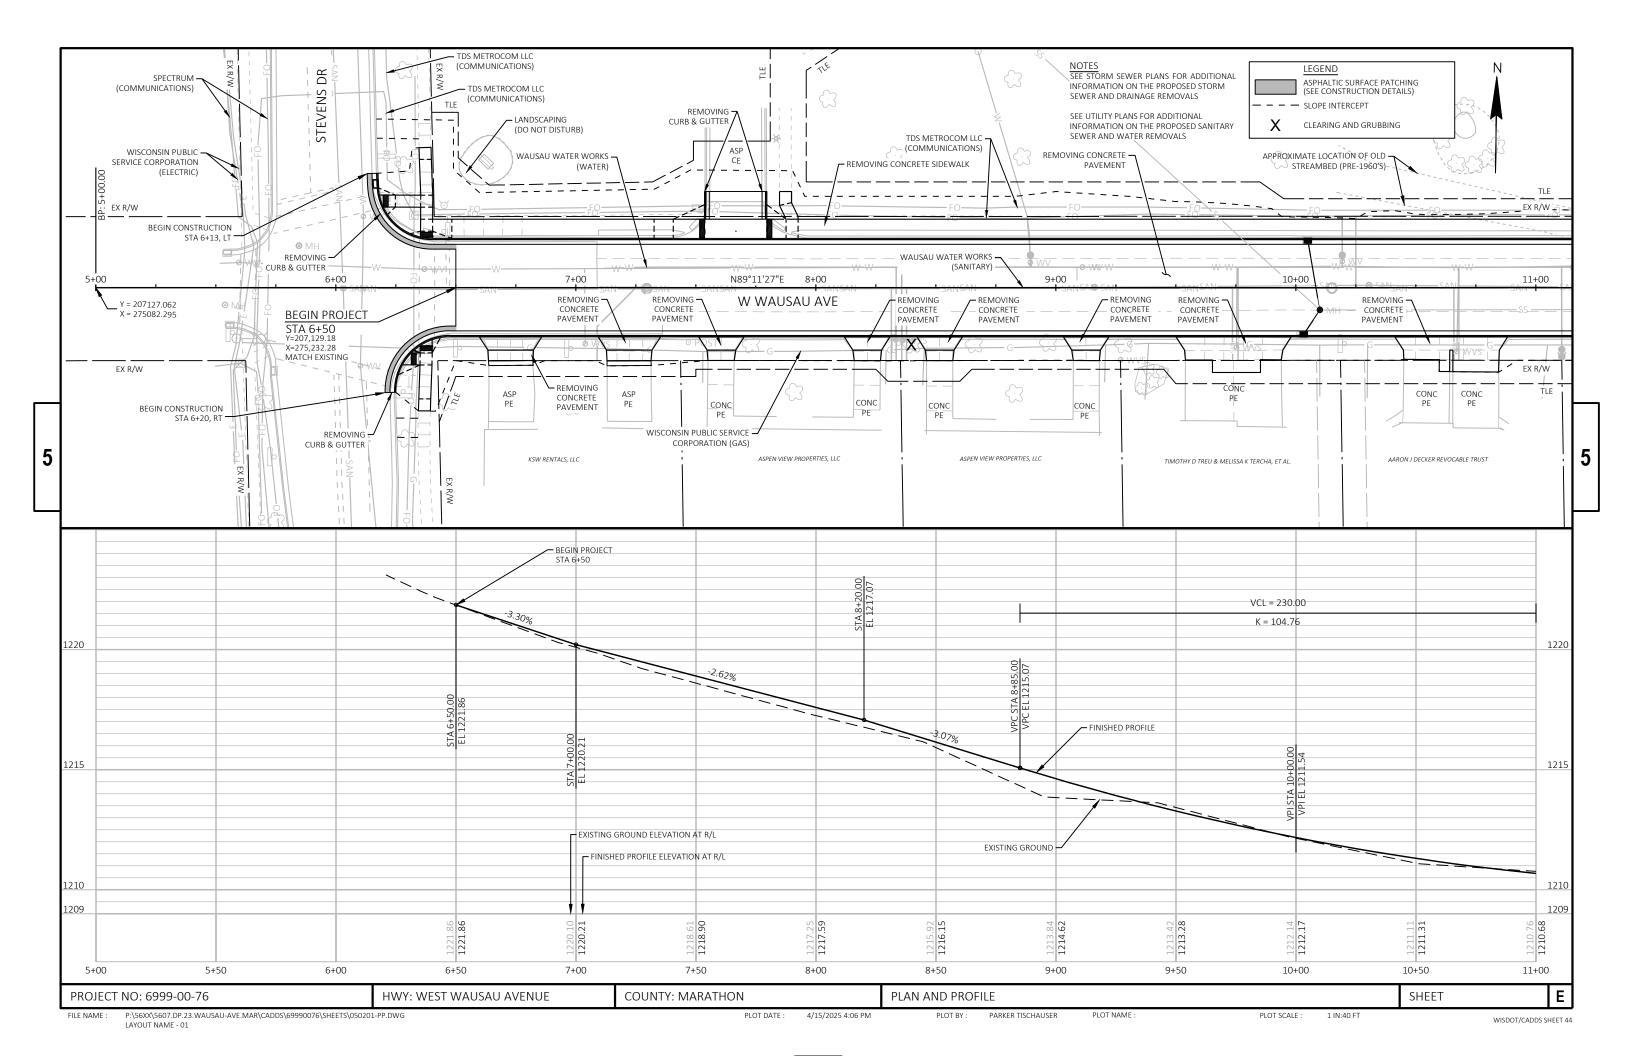

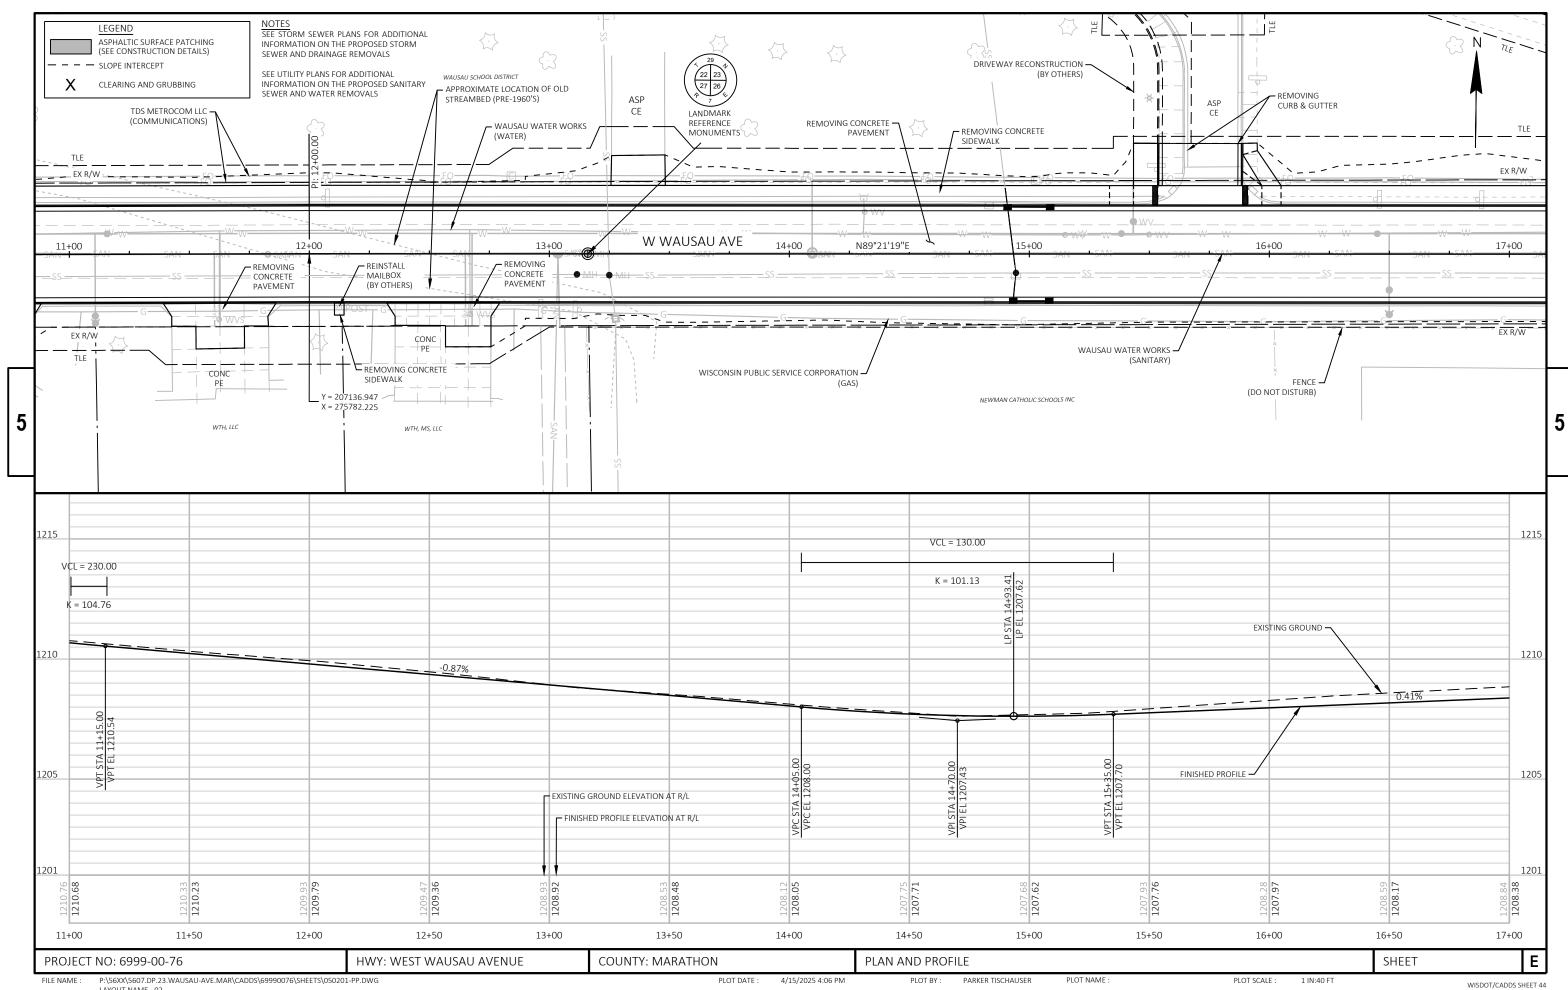

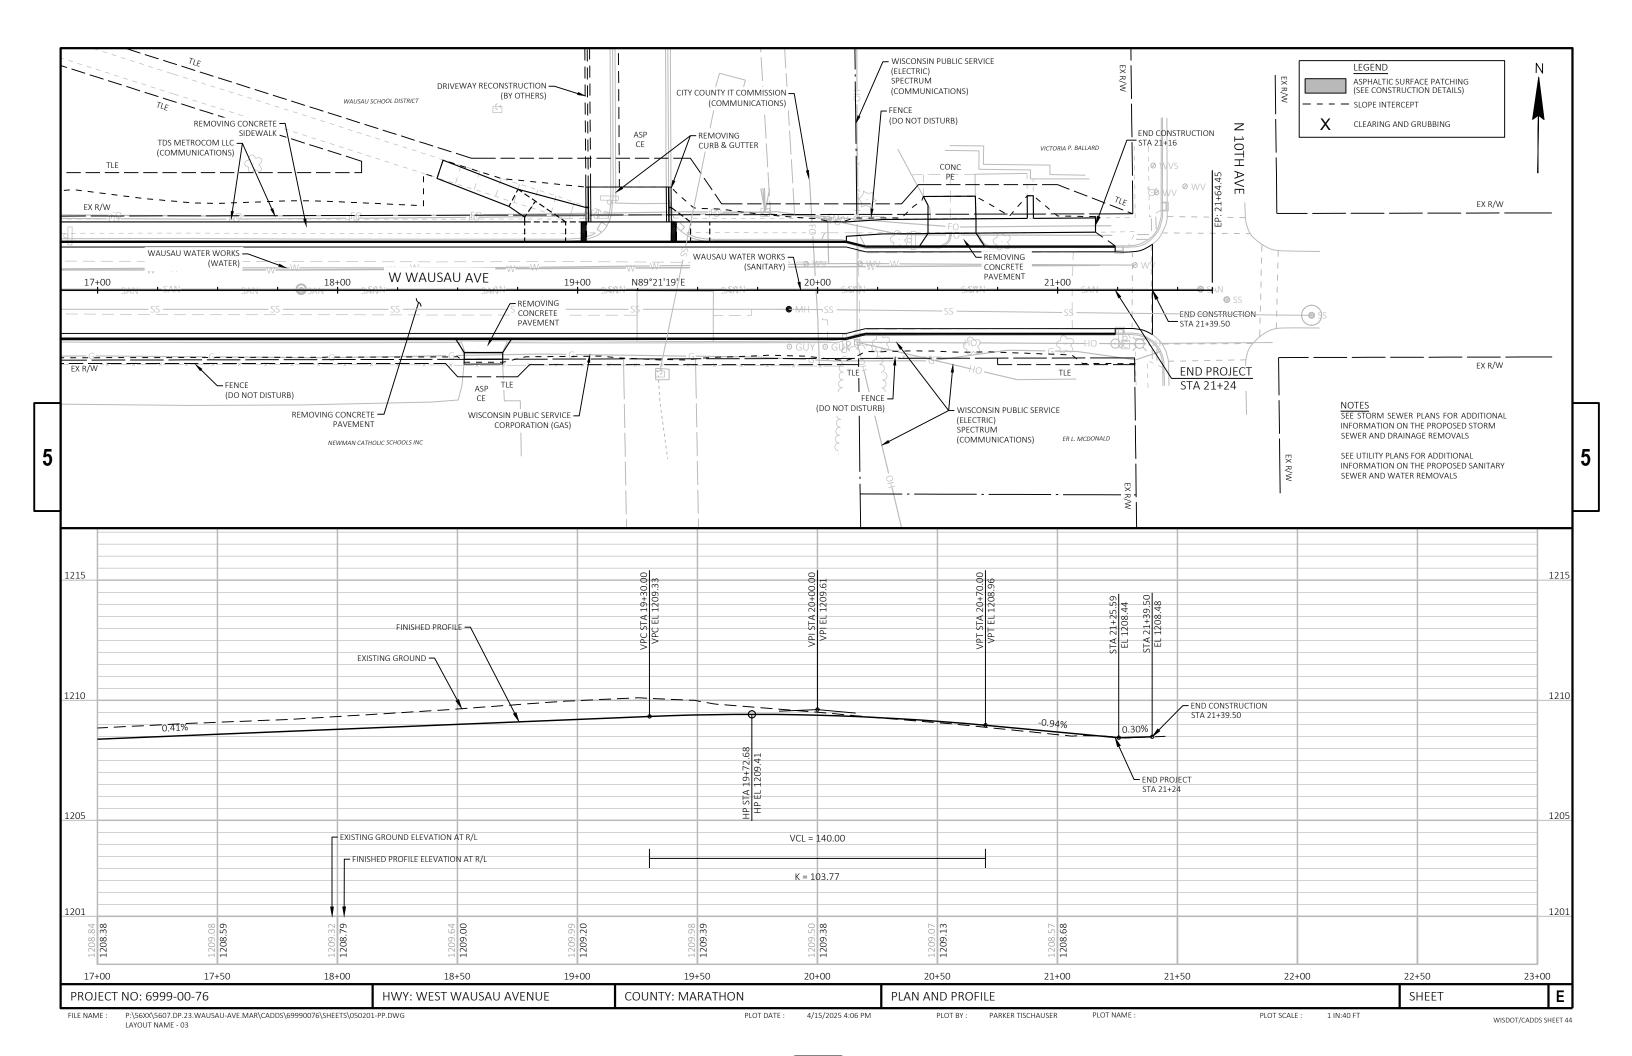


_

Standard Detail Drawing List

08A05-21A	INLET COVERS TYPE A, H, A-S, H-S & Z
08A05-21E	INLET COVER TYPE BW, MANHOLE COVERS, TYPE K, J, J-S, L & M
08C06-03	INLETS 3-FT AND 4-FT DIAMETER
08C07-03	INLETS 2X2-FT, 2X2.5-FT, 2X3-FT, 2.5X3-FT & 2X3.5-FT
08D01-23A	CONCRETE CURB & GUTTER
08D01-23B	CONCRETE CURB, TIES AND CURB AND GUTTER APPLICATIONS
08D05-21A	CURB RAMPS TYPES 1 AND 1-A
08D05-21B	CURB RAMPS TYPES 2 AND 3
08D05-21C	CURB RAMPS TYPES 4A AND 4A1
08D05-21D	CURB RAMPS TYPE 4B AND 4B1
08D05-21E	CURB RAMPS TYPES 5, 6, 7A, 7B & 8
08D05-21F	CURB RAMPS RADIAL DETECTABLE WARNING FIELD APPLICATIONS
08D05-21G	CURB RAMPS RECTANGULAR AND RADIAL DETECTABLE WARNING PLATES
08D18-04	DRIVEWAY AND SIDEWALK RAMPS TYPES X & Y
08D19-04	DRIVEWAY AND SIDEWALK RAMPS TYPE Z
08E09-06	SILT FENCE
08E10-02	INLET PROTECTION TYPE A, B, C AND D
08F04-08	JOINT TIES FOR CONCRETE PIPE AND CONCRETE COLLAR DETAIL
13C19-03	HMA LONGITUDINAL JOINTS
15C02-09A	BARRICADES AND SIGNS FOR MAINLINE CLOSURES
15C02-09B	BARRI CADES AND SIGNS FOR VARIOUS CLOSURES
15C03-05	BARRI CADES AND SIGNS FOR SIDEROAD CLOSURES
15C05-05	TRAFFIC CONTROL, ADVANCE WARNING SIGNS 40 M.P.H. OR LESS
15C07-16B	PAVEMENT MARKING WORDS
15C07-16C	PAVEMENT MARKING ARROWS
15C08-23A	PERMANENT LONGITUDINAL PAVEMENT MARKINGS
15C08-23B	TEMPORARY LONGITUDI NAL PAVEMENT MARKI NG
15C08-23C	PAVEMENT MARKING (TURN LANES)
15C08-23D	PAVEMENT MARKING (TURN LANES) CHANNELIZING DEVICES DRUMS, CONES, BARRICADES AND VERTICAL PANELS
15C11-10B 15C12-09A	TRAFFIC CONTROL FOR LANE CLOSURE WITH FLAGGING OPERATION
15C12-09A	TRAFFIC CONTROL, LANE CLOSURE WITH AUTOMATED FLAGGER ASSISTANCE DEVICE
15C33-05	STOP LINE AND CROSSWALK PAVEMENT MARKING
15C35-06A	PAVEMENT MARKING (INTERSECTIONS)
15D28-04	TRAFFIC CONTROL, WORK ON SHOULDER OR PARKING LANE, UNDIVIDED ROADWAY
15D30-10A	TRAFFIC CONTROL, PEDESTRIAN ACCOMMODATION
15D30-10B	TRAFFIC CONTROL, PEDESTRIAN ACCOMMODATION
15D30-10C	TRAFFIC CONTROL, PEDESTRIAN ACCOMMODATION
15D30-10D	TRAFFIC CONTROL, PEDESTRIAN ACCOMMODATION
15D30-10E	TRAFFIC CONTROL, PEDESTRIAN ACCOMMODATION
15D30-10F	TRAFFIC CONTROL, PEDESTRIAN ACCOMMODATION
15D30-10G	TRAFFIC CONTROL, PEDESTRIAN ACCOMMODATION
15D30-10H	TRAFFIC CONTROL, PEDESTRIAN ACCOMMODATION
15D30-10I	TRAFFIC CONTROL, PEDESTRIAN ACCOMMODATION
15D30-10J	TRAFFIC CONTROL, PEDESTRIAN ACCOMMODATION
15D30-10K	TRAFFIC CONTROL, PEDESTRIAN ACCOMMODATION
15D30-10L	TRAFFIC CONTROL, PEDESTRIAN ACCOMMODATION
15D39-02	TRAFFIC CONTROL, DROP-OFF SIGNING
15D45-03	TRAFFIC CONTROL, SIGNING ON ROADWAYS WITH LOOSE GRAVEL
15D51-01	TRAFFIC CONTROL, MOBILE OPERATIONS ON AN UNDIVIDED ROADWAY

6

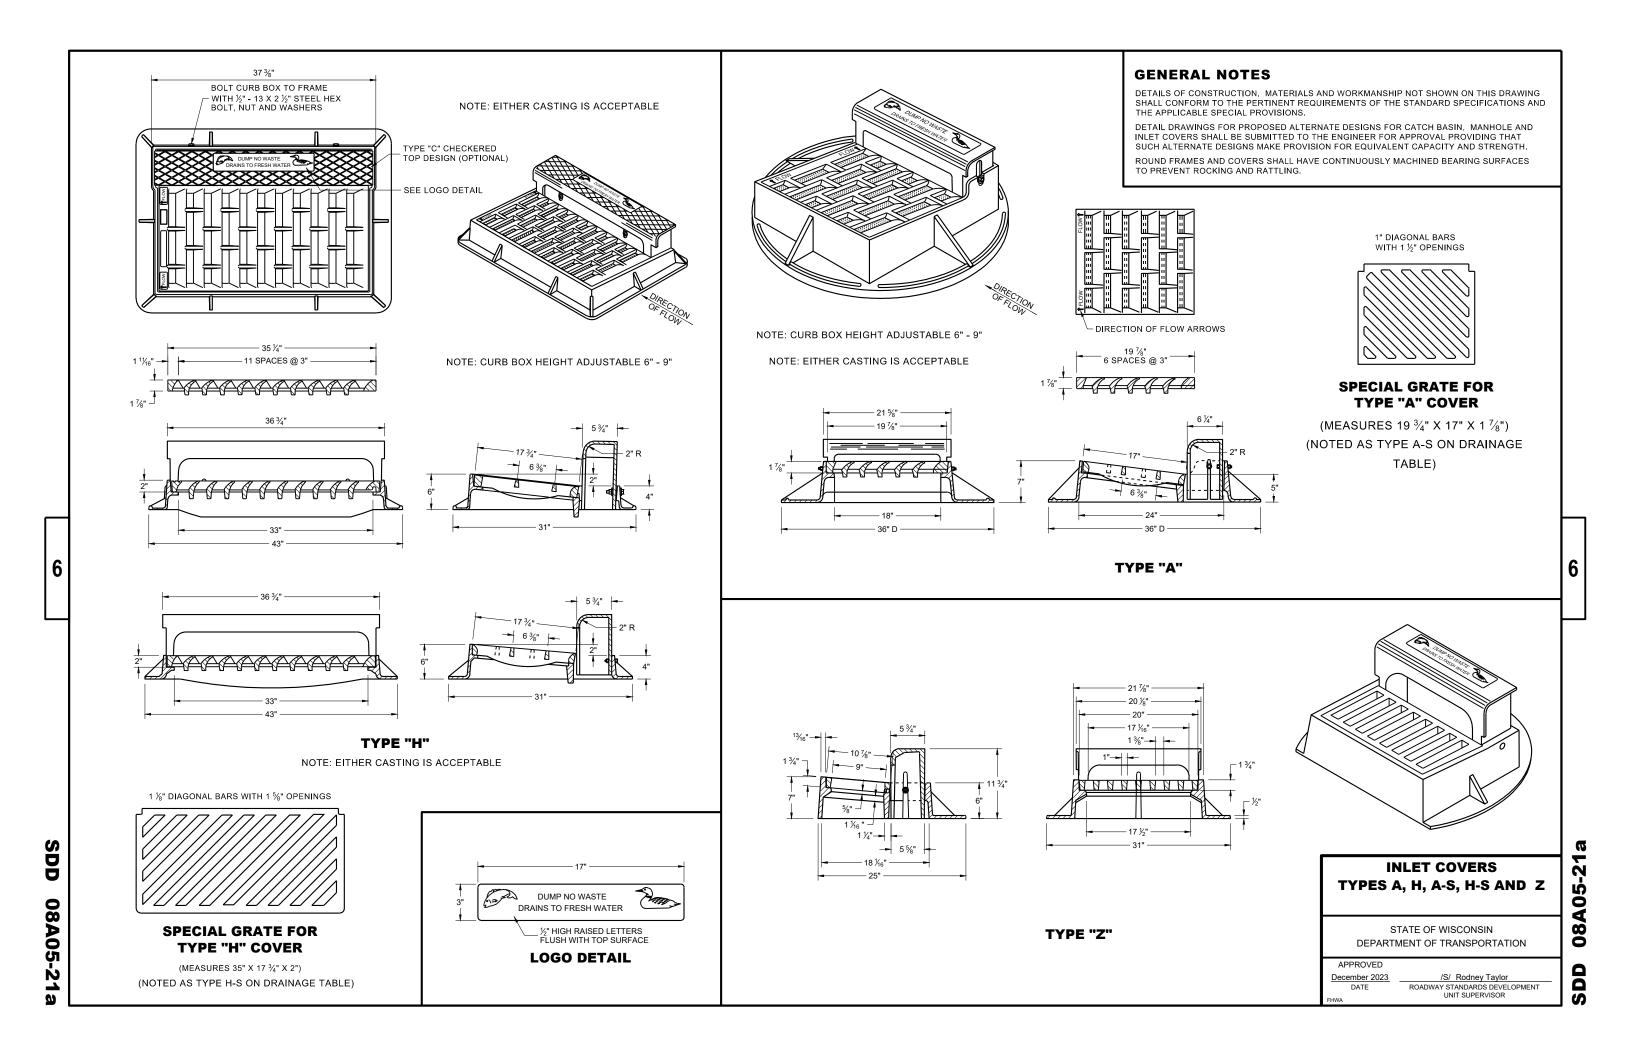



GENERAL NOTES


DETAILS OF CONSTRUCTION, MATERIALS AND WORKMANSHIP NOT SHOWN ON THIS DRAWING SHALL CONFORM TO THE PERTINENT REQUIREMENTS OF THE STANDARD SPECIFICATIONS AND THE APPLICABLE SPECIAL PROVISIONS.


DETAIL DRAWINGS FOR PROPOSED ALTERNATE DESIGNS FOR MANHOLE COVERS SHALL BE SUBMITTED TO THE ENGINEER FOR APPROVAL PROVIDING THAT SUCH ALTERNATE DESIGNS MAKE PROVISION FOR EQUIVALENT CAPACITY AND STRENGTH.


ROUND FRAMES AND COVERS SHALL HAVE CONTINUOUSLY MACHINED BEARING SURFACES TO PREVENT ROCKING AND RATTLING.

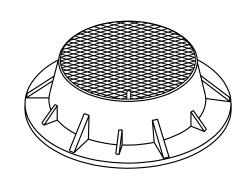


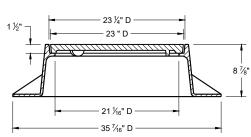


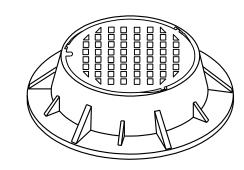


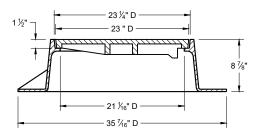


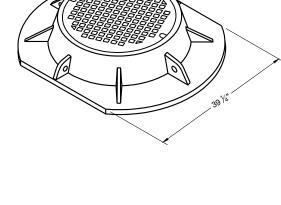


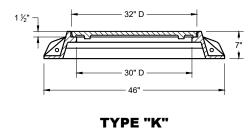

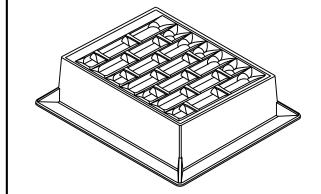


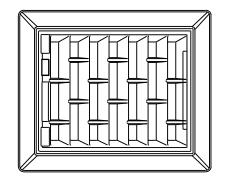


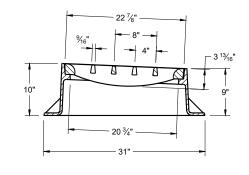

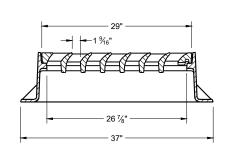


INLET COVER TYPE "BW"

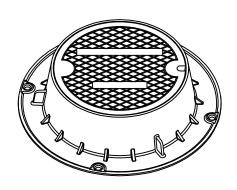


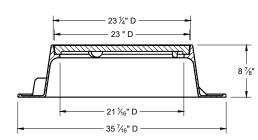

TYPE "J"

NOTE: EITHER CASTING IS ACCEPTABLE

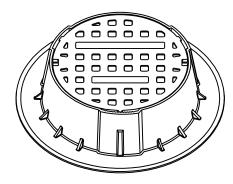


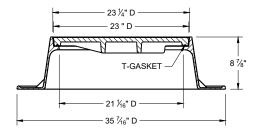


TYPE "J" SPECIAL


TYPE "B" NON-ROCKING SELF-SEAL LID (NOTED AS TYPE J-S ON THE DRAINAGE TABLE)


NOTE: EITHER CASTING IS ACCEPTABLE

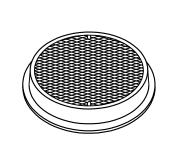

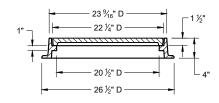

TYPE "L"

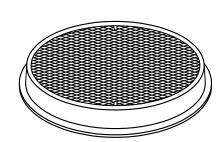

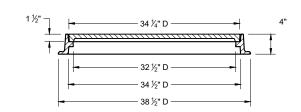

TYPE "M"

INLET COVERS TYPES BW MANHOLE COVERS TYPES K, J, J-S, L, AND M

STATE OF WISCONSIN
DEPARTMENT OF TRANSPORTATION

APPROVED

December 2023

/S/ Rodney Taylor


ROADWAY STANDARDS DEVELOPMENT
UNIT SUPERVISOR

SDD 08A05-21e


6

SDD 08A05-2

PLAN VIEW CIRCULAR OPENING

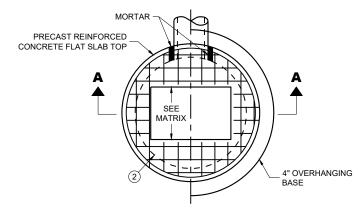

PLAN VIEW RECTANGULAR OPENING

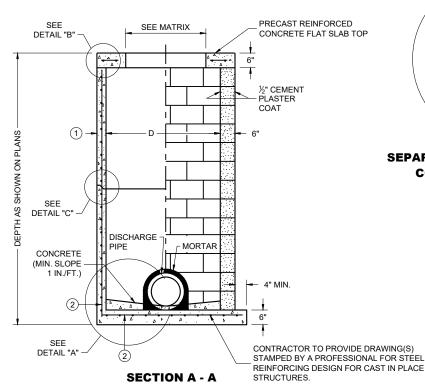


CONCRETE BLOCK WITH PRECAST REINFORCED **CAST IN PLACE OR** PRECAST REINFORCED **MONOLITHIC BASE** CONCRETE BASE ②

CATCH BASIN COVER OPENING MATRIX


INLET	INLET COVER TYPE	ALL A'S	ALL B'S	BW	С	F	ALL H'S	s	Т	٧	WM	Z
SIZE	OPENING SIZE (FT.)											
0.57	2 DIA.				Х							Х
3-FT	2 X 2	х	Х					Х		Х		
	2 DIA.				Х							Х
	2 X 2	х	Х					Х		Х		
4-FT	2 X 2.5			Х				Х	Х	Х	Х	
	2 X 3						×					
	2.5 X 3					Х						

PIPE MATRIX

INLET SIZE	MAXIMUM INSIDE PIPE DIAMETER FOR TWO PIPES						
SIZL	180° SEPARATION (IN)	90° SEPARATION (IN)					
3-FT	15	12					
4-FT	24	18					

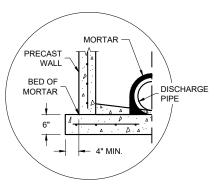


SEPARATE PRECAST REINFORCED CONCRETE BASE OPTION

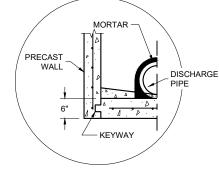


PRECAST REINFORCED CONCRETE WITH INTEGRAL BASE OPTION

DETAIL "A"

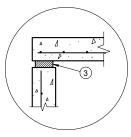

TOP WITH PLAIN END JOINT

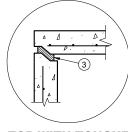

TOP WITH TONGUE AND GROOVE JOINT



AND GROOVE JOINT

DETAIL "C"

GENERAL NOTES

DETAILS OF CONSTRUCTION, MATERIALS AND WORKMANSHIP NOT SHOWN ON THIS DRAWING SHALL CONFORM TO THE PERTINENT REQUIREMENTS OF THE STANDARD SPECIFICATIONS AND THE APPLICABLE

UNLESS OTHERWISE AUTHORIZED IN WRITING BY THE ENGINEER, THE CONTRACTOR SHALL NOT ORDER AND DELIVER PRECAST INLET UNITS REQUIRED FOR THE PROJECT UNTIL A LIST OF SIZES IS FURNISHED BY

DETAILED DRAWINGS FOR PROPOSED ALTERNATE DESIGNS FOR UNDERGROUND DRAINAGE STRUCTURES SHALL BE SUBMITTED TO THE ENGINEER FOR APPROVAL PROVIDING THAT SUCH ALTERNATE DESIGNS MAKE PROVISION FOR EQUIVALENT CAPACITY AND STRENGTH.

ALL DRAINAGE STRUCTURES ARE DESIGNATED ON THE PLANS AS "MANHOLES 3X3-L", "CATCH BASINS 4-B", "INLETS 2X3-H", ETC. THE FIRST NUMBERS DESIGNATE THE SIZE OF THE STRUCTURE, AND THE FOLLOWING LETTER DESIGNATES THE TYPE OF COVER TO BE USED TO COMPRISE THE COMPLETE UNIT

BASES SHALL BE PLACED ON A BED OF MATERIAL AT LEAST 6 INCHES IN DEPTH. WHICH MEETS THE REQUIREMENTS OF FOUNDATION BACKFILL. THIS BEDDING SHALL BE COMPACTED AND PROVIDE UNIFORM SUPPORT FOR THE ENTIRE AREA OF THE BASE.

ALL BAR STEEL REINFORCEMENT SHALL BE EMBEDDED 2 INCHES CLEAR UNLESS OTHERWISE SHOWN OR NOTED.


ALL PRECAST INLET UNITS SHALL CONFORM TO THE PERTINENT REQUIREMENTS OF AASHTO DESIGNATION M199.

PRECAST REINFORCED RISERS SHALL HAVE A TONGUE AND GROOVE JOINT WITH TONGUE UP OR DOWN.

4" OVERHANGING BASES ARE REQUIRED FOR ALL CONCRETE BLOCK INSTALLATIONS. 4" OVERHANG IS REQUIRED WHEN SEPARATE PRECAST BASE IS PROVIDED. OVERHANG IS NOT REQUIRED ON PRECAST STRUCTURES WITH AN INTEGRAL OR MONOLITHIC BASE.

FOR ADDITIONAL CONFIGURATIONS, MAINTAIN A MINIMUM OF 12 INCHES AS MEASURED FROM THE INSIDE OF THE STRUCTURE WALL BETWEEN THE OUTSIDE PIPE WALLS OF ADJACENT PIPES. SEE DETAIL "D".

- (1) MINIMUM WALL THICKNESS SHALL BE 4 INCHES FOR 3-FT DIAMETER AND 5 INCHES FOR 4-FT DIAMTER PRECAST INLETS.
- (2) FOR PRECAST INLETS AND REINFORCED CONCRETE BASES PROVIDE REINFORCING STEEL IN ACCORDANCE TO AASHTO
- (3) JOINTS TO BE SEALED WITH A BUTYL RUBBER SEAL PER SEALANT MANUFACTURERS RECOMMENDATIONS CONFORMING TO ASTM C 990 OR RUBBER GASKETS CONFORMING TO ASTM C443.

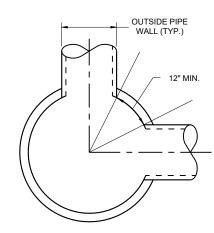

MINIMUM HORIZONTAL PIPE **SEPARATION DETAIL "D"**

INLETS 3-FT AND 4-FT DIAMETER

STATE OF WISCONSIN DEPARTMENT OF TRANSPORTATION

December 2023

ROADWAY STANDARDS DEVELOPMENT UNIT SUPERVISOR

CIRCULAR INLETS WITH FLAT TOP

CONCRETE WITH

08C06-03

INLETS 3-FT AND 4-FT DIAMETER

DETAIL "B"


902 ∞ Õ CONCRETE

(MIN. SLOPE 1 IN./FT.)

PRECAST REINFORCED

CONCRETE WITH

MONOLITHIC BASE

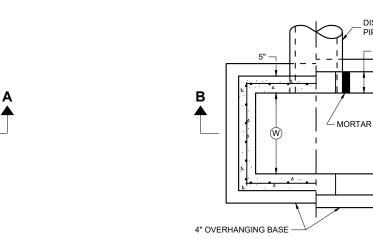

PLAN VIEW



PRECAST REINFORCED **CONCRETE WITH INTEGRAL BASE**

DISCHARGE

PLAN VIEW

RISER JOINT TO BE SEALED WITH

A BUTYL RUBBER SEAL PER SEALANT MANUFACTURERS RECOMMENDATIONS

CONFORMING TO ASTM C 990 (TYP.)

DISCHARGE

MORTAR

CAST IN PLACE REINFORCED CONCRETE

4" MIN

(2)

CONCRETE

(MIN. SLOPE

1 IN./FT.) CONSTRUCTION DISCHARGE


CONCRETE BLOCK WITH CAST IN PLACE OR PRECAST REINFORCED CONCRETE BASE (1)

6" MIN. CONCRETE BLOCK

> 1/4" CEMENT PLASTER


COAT

SECTION A - A SECTION B - B

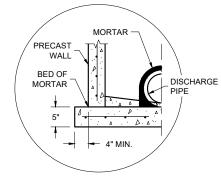

SEPARATE PRECAST REINFORCED **CONCRETE BASE OPTION**

DETAIL "B"

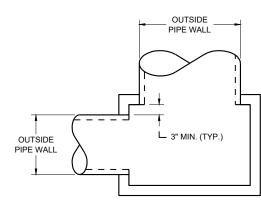

DETAIL "A"

INLETS 2 X 2-FT, 2 X 2.5-FT, 2 X 3-FT, 2.5 X 3-FT AND 2X3.5-FT

GENERAL NOTES

DETAILS OF CONSTRUCTION, MATERIALS AND WORKMANSHIP NOT SHOWN ON THIS DRAWING SHALL CONFORM TO THE PERTINENT REQUIREMENTS OF THE STANDARD SPECIFICATIONS AND THE APPLICABLE SPECIAL PROVISIONS.

UNLESS OTHERWISE AUTHORIZED IN WRITING BY THE ENGINEER. THE CONTRACTOR SHALL NOT ORDER AND DELIVER PRECAST INLET UNITS REQUIRED FOR THE PROJECT UNTIL A LIST OF SIZES IS FURNISHED BY

DETAILED DRAWINGS FOR PROPOSED ALTERNATE DESIGNS FOR UNDERGROUND DRAINAGE STRUCTURES SHALL BE SUBMITTED TO THE ENGINEER FOR APPROVAL PROVIDING THAT SUCH ALTERNATE DESIGNS MAKE PROVISION

ALL PRECAST INLET UNITS SHALL CONFORM TO THE PERTINENT REQUIREMENTS OF ASTM C 913.

ALL DRAINAGE STRUCTURES ARE DESIGNATED ON THE PLANS AS "MANHOLES 3X3-L", "CATCH BASINS 4-B", "INLETS 2X3-H", ETC. THE FIRST NUMBERS DESIGNATES THE SIZE OF THE STRUCTURE, AND THE FOLLOWING LETTER DESIGNATES THE TYPE OF COVER TO BE USED TO COMPRISE THE COMPLETE UNIT

BASES SHALL BE PLACED ON A BED OF MATERIAL AT LEAST 6 INCHES IN DEPTH, WHICH MEETS THE REQUIREMENTS OF FOUNDATION BACKFILL. THIS BEDDING SHALL BE COMPACTED AND PROVIDE UNIFORM SUPPORT FOR THE ENTIRE AREA OF THE BASE

ALL BAR STEEL REINFORCEMENT SHALL BE EMBEDDED 2 INCHES CLEAR UNLESS OTHERWISE SHOWN OR NOTED.

PRECAST REINFORCED RISERS SHALL HAVE A TONGUE AND GROOVE JOINT WITH TONGUE UP OR DOWN.

4" OVERHANGING BASES ARE REQUIRED FOR CAST-IN-PLACE REINFORCED CONCRETE AND CONCRETE BLOCK INSTALLATIONS. 4" OVERHANG IS REQUIRED WHEN SEPARATE PRECAST BASE IS PROVIDED. OVERHANG IS NOT REQUIRED ON PRECAST STRUCTURES WITH AN INTEGRAL OR MONOLITHIC BASE.

MAXIMUM INSIDE PIPE DIAMETER DETERMINED BY 3" CLEARANCE ON EACH SIDE OF THE OUTSIDE WALL OF THE PIPE. SEE DETAIL "A". ASSUMES PIPE ENTERS PERPENDICULAR TO THE STRUCTURE.

- $\stackrel{\textstyle \frown}{}$ FOR PRECAST INLETS AND REINFORCED CONCRETE BASES PROVIDE REINFORCING STEEL IN ACCORDANCE TO
- (2) CONTRACTOR TO PROVIDE DRAWING(S) STAMPED BY A PROFESSIONAL ENGINEER FOR STEEL REINFORCING DESIGN FOR CAST-IN-PLACE STRUCTURES.

CATCH BASIN COVER MATRIX

Γ	INLET WIDTH W (FT.)	LENGTH	INLET COVER TYPE										
1		(FT.)	ALL A'S	ALL B'S	BW	F	ALL H'S	S	Т	٧	WM	V V-B	
Γ	2 X 2-FT	2	2	Х	Х				Х				
Γ	2 X 2.5-FT	2	2.5			х			Х	х	х	Х	
	2 X 3-FT	2	3					Х					
Γ	2.5 X 3-FT	2.5	3				Х						
	2 X 3.5-FT	2	3.5										Х

PIPE MATRIX


		=						
	CATCH BASIN SIZE	MAXIMUM INSIDE PIPE DIAMETER FOR TWO PIPES						
		WIDTH (IN)	LENGTH (IN)					
	2 X 2-FT	12	12					
	2 X 2.5-FT	12	18					
	2 X 3-FT	12	24					
	2.5 X 3-FT	18	24					
	2 X 3.5-FT	12	30					


INLETS 2 X 2-FT, 2 X 2.5-FT, 2 X 3-FT, 2.5 X 3-FT **AND 2 X 3.5-FT**


STATE OF WISCONSIN DEPARTMENT OF TRANSPORTATION

December 2023 ROADWAY STANDARDS DEVELOPMENT UNIT SUPERVISOR

Ò 07 Õ

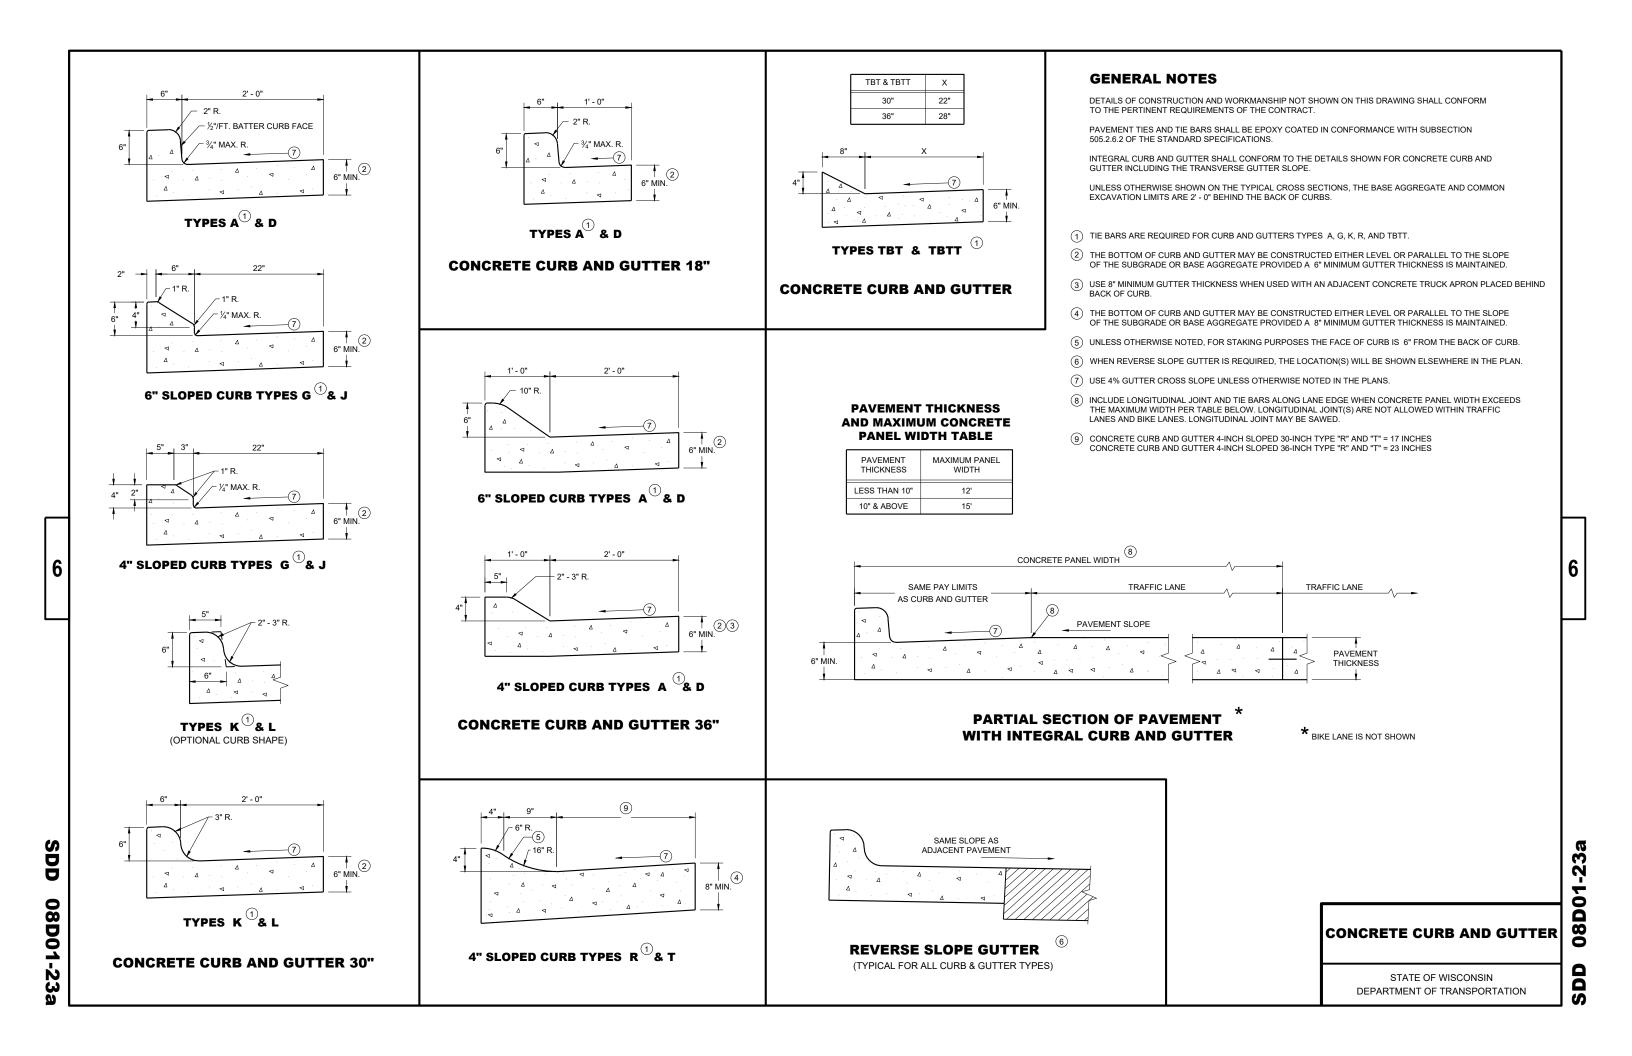

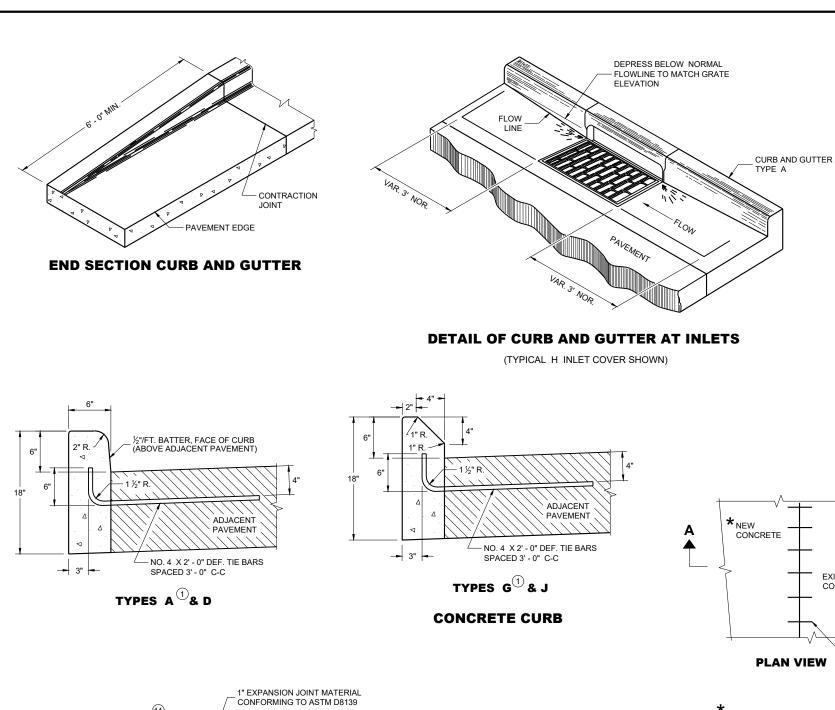

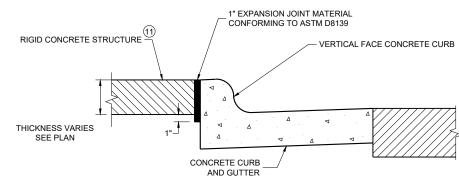

EXPANSION JOINT DETAIL FOR VERTICAL CURB ABUTTING A RIGID STRUCTURE ①

CONCRETE **EXISTING** CONCRETE * NEW CURB AND GUTTER, SURFACE DRAINS, CONCRETE PAVEMENT OR OTHER NEW CONCRETE. **PLAN VIEW** NO. 6 TIE BARS SPACED 2' - 6" C-C, INSTALLED PERPENDICULAR TO THE CONCRETE MAXIMUM DRILL HOLE SIZE IS 1/8" GREATER THAN TIE BAR DIAMETER 1/2 THICKNESS OF_ NEW CONCRETE **EXISTING**

TIE BARS DRILLED
INTO EXISTING PAVEMENT

SECTION A - A


GENERAL NOTES

DETAILS OF CONSTRUCTION AND WORKMANSHIP NOT SHOWN ON THIS DRAWING SHALL CONFORM TO THE PERTINENT REQUIREMENTS OF THE CONTRACT.


PAVEMENT TIES AND TIE BARS SHALL BE EPOXY COATED IN CONFORMANCE WITH SUBSECTION 505.2.6.2 OF THE STANDARD SPECIFICATIONS.

UNLESS OTHERWISE SHOWN ON THE TYPICAL CROSS SECTIONS, THE BASE AGGREGATE AND COMMON EXCAVATION LIMITS ARE 2'- 0" BEHIND THE BACK OF CURBS.

- 1) TIE BARS ARE REQUIRED FOR CURB AND GUTTERS TYPES A, G, K, R, AND TBTT.
- (2) THE BOTTOM OF CURB AND GUTTER MAY BE CONSTRUCTED EITHER LEVEL OR PARALLEL TO THE SLOPE OF THE SUBGRADE OR BASE AGGREGATE PROVIDED A 6" MINIMUM GUTTER THICKNESS IS MAINTAINED.
- 10 REFER TO SDD 08D18 AND 08D19 FOR ADDITIONAL DRIVEWAY ENTRANCE CURB DETAILS.
- 1 PLACE 1" THICK EXPANSION JOINT MATERIAL BETWEEN VERTICAL FACE CURB TYPES EXTENDING FROM THE TOP OF CURB TO 1 INCH BELOW THE ADJOINING CONCRETE SURFACE. RIGID CONCRETE STRUCTURES INCLUDE RAISED CONCRETE MEDIANS, CONCRETE SAFETY ISLANDS, SPLITTER ISLANDS, OR LOCATIONS IDENTIFIED ON THE PLANS.

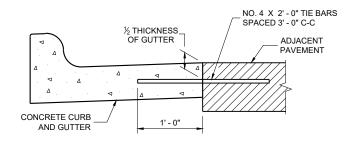

TYPICAL TIE BAR LOCATION

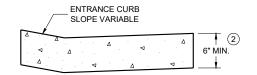

DRIVEWAY ENTRANCE CURB

(WHEN DIRECTED BY THE ENGINEER)

CONCRETE CURB, TIES AND CURB AND GUTTER APPLICATIONS


STATE OF WISCONSIN
DEPARTMENT OF TRANSPORTATION


APPROVED

May 2023
DATE
ROADWAY STANDARDS DEVELOPMENT
UNIT SUPERVISOR

SDD 08D01-23b

DD 08D01-23b

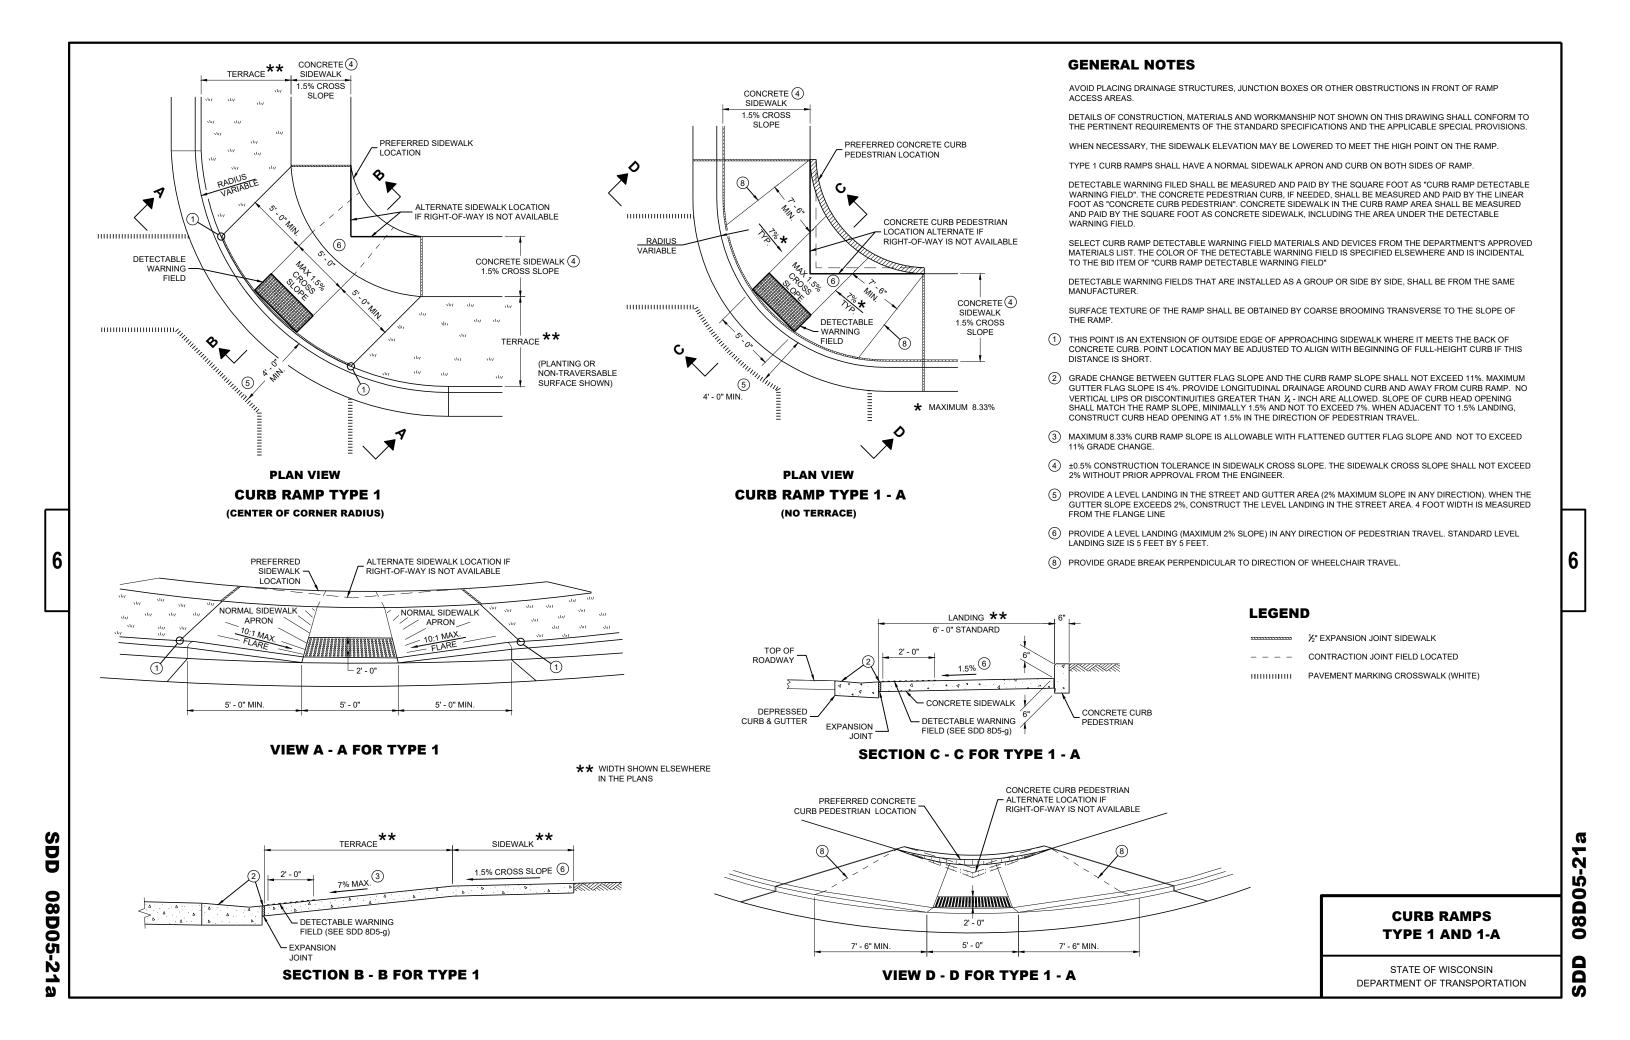


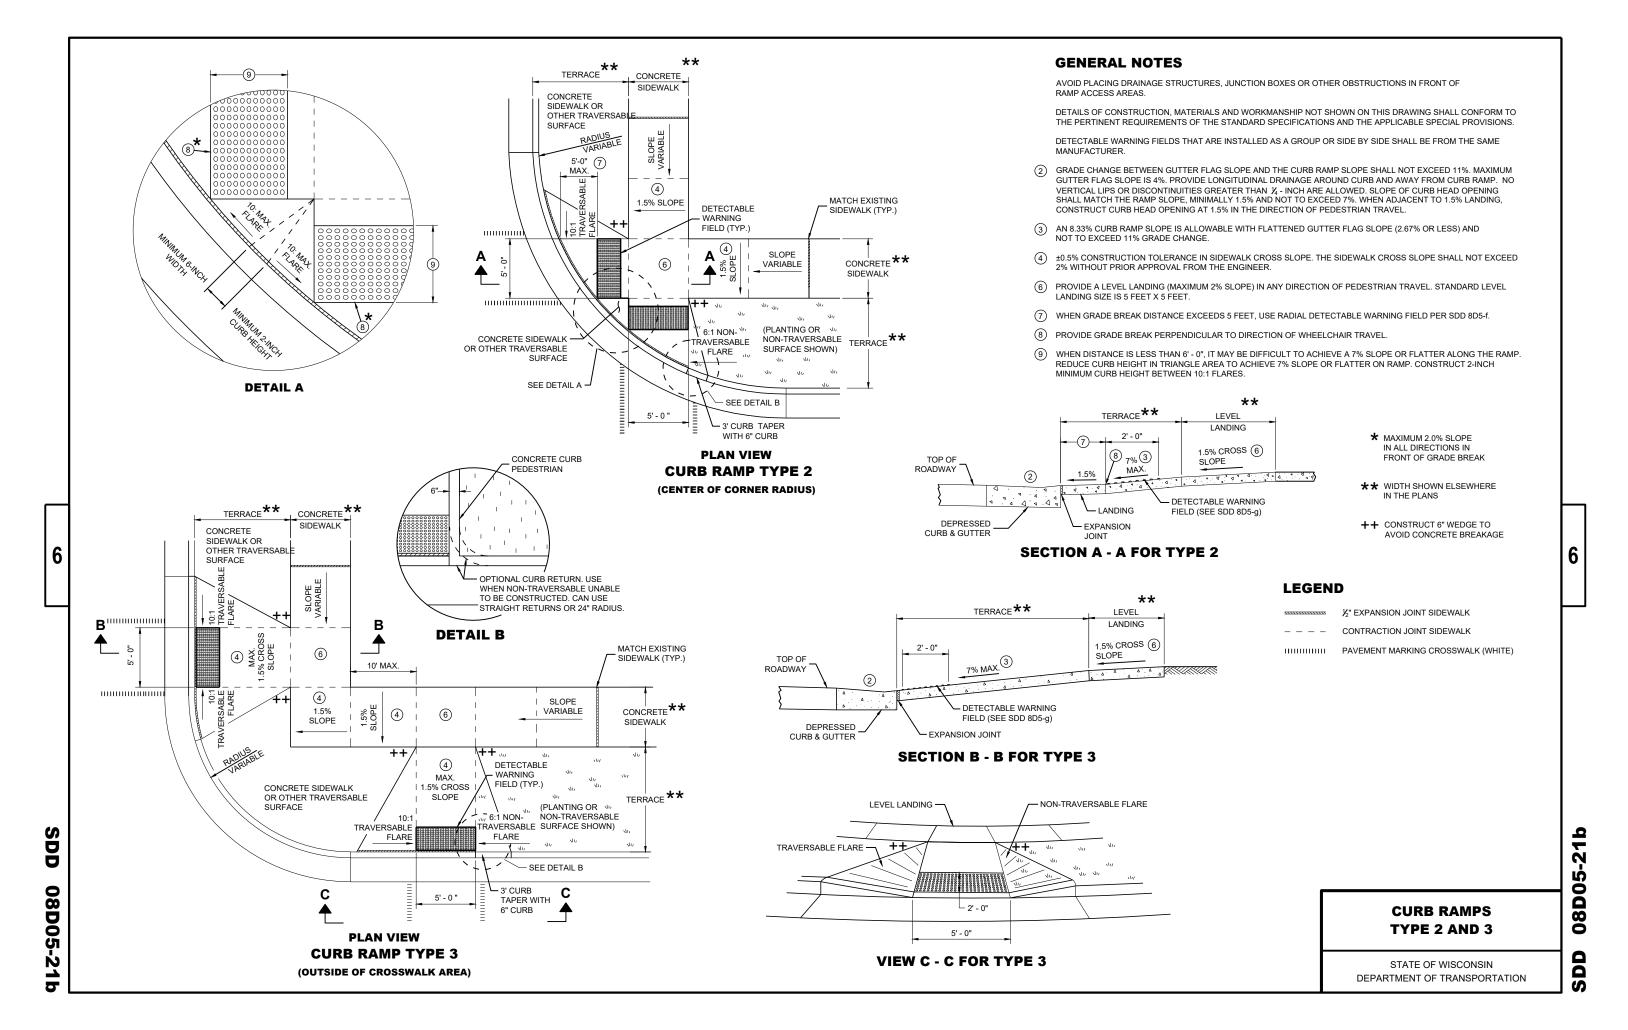



O


08D0


STATE OF WISCONSIN DEPARTMENT OF TRANSPORTATION

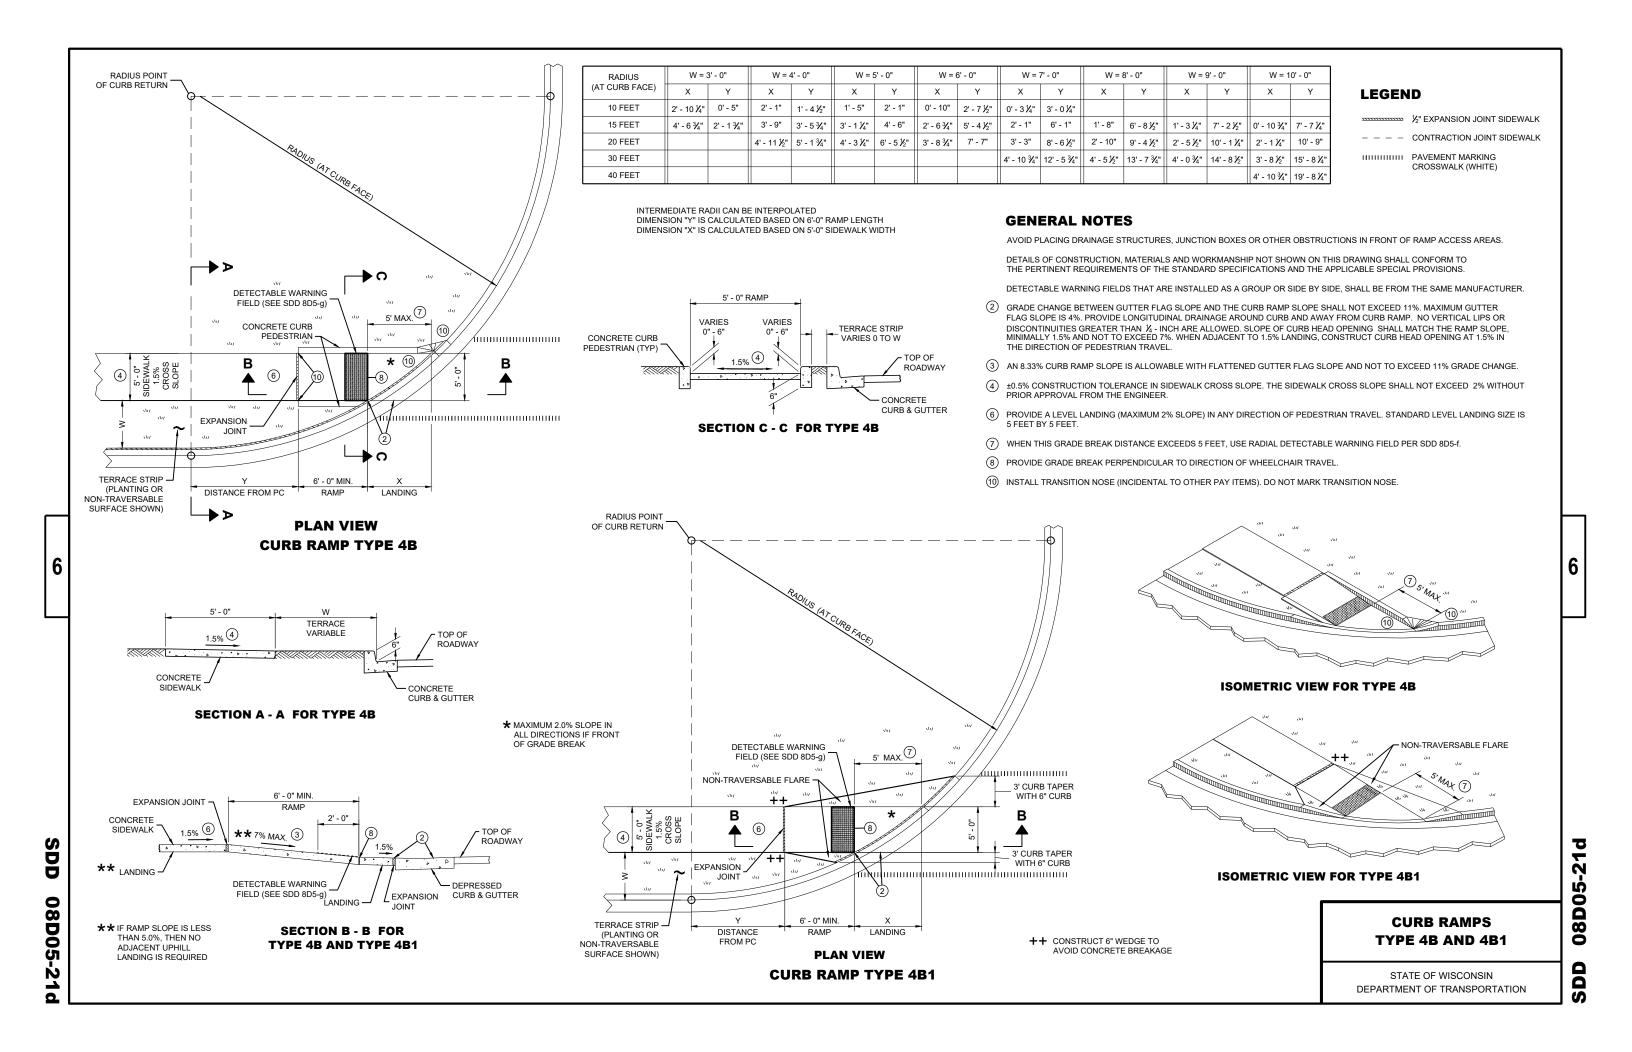

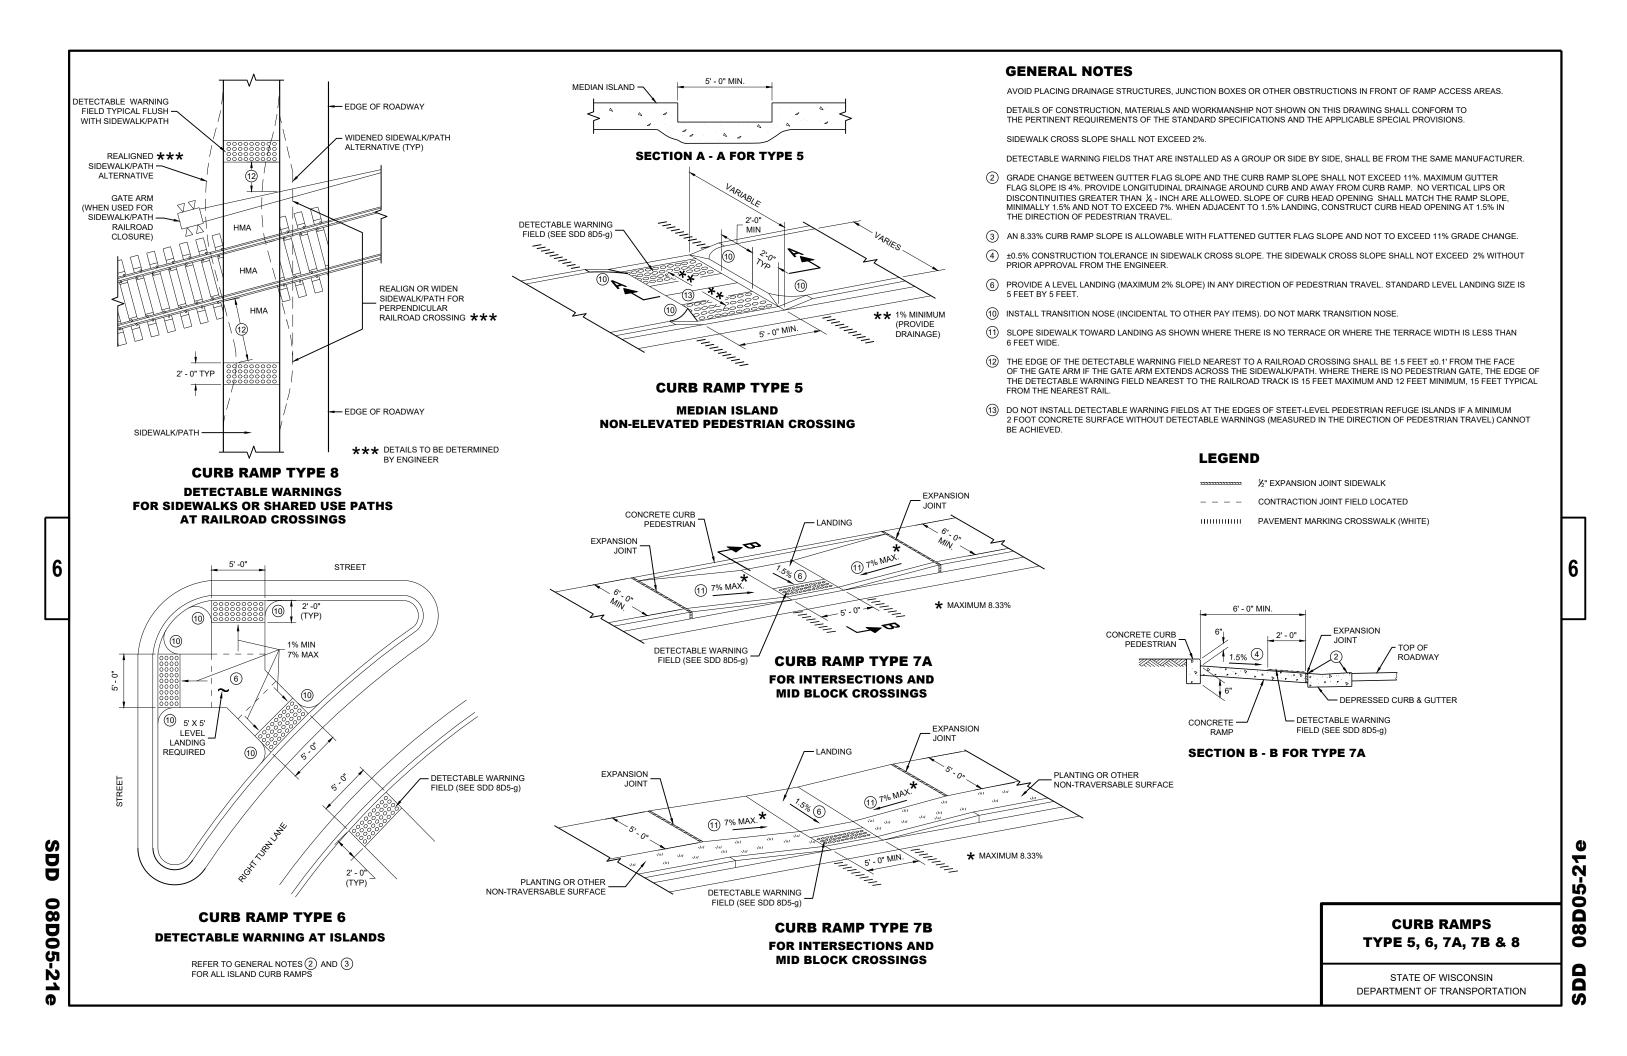

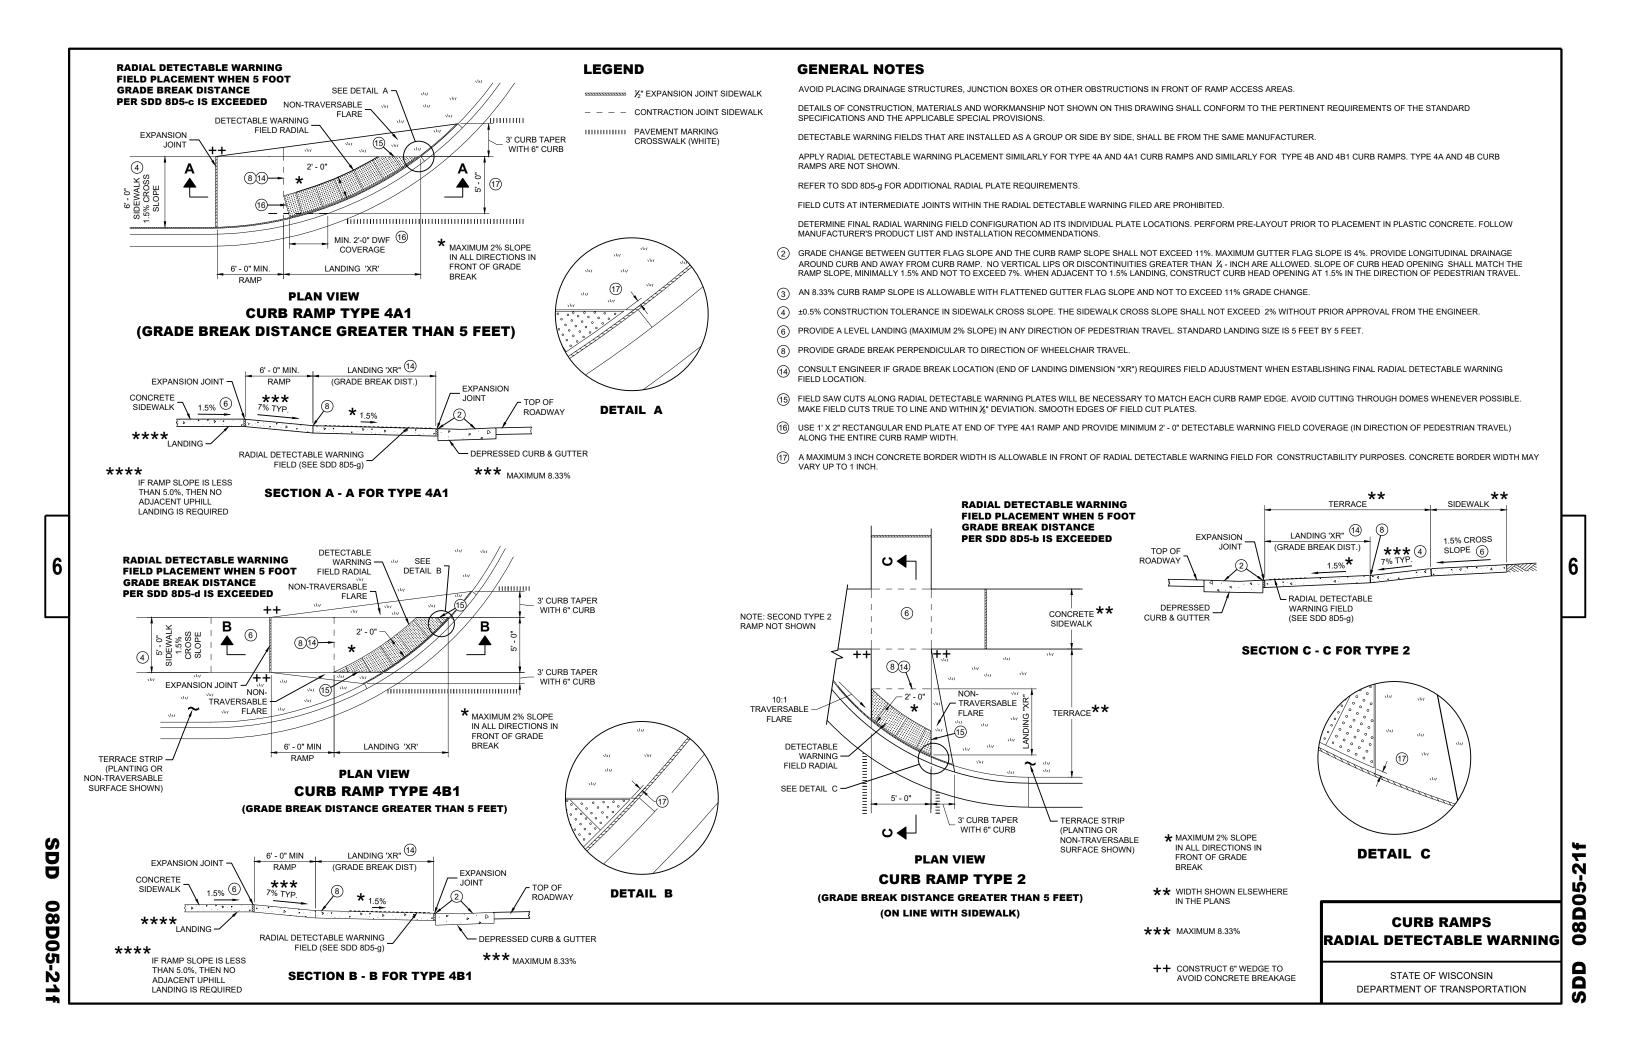

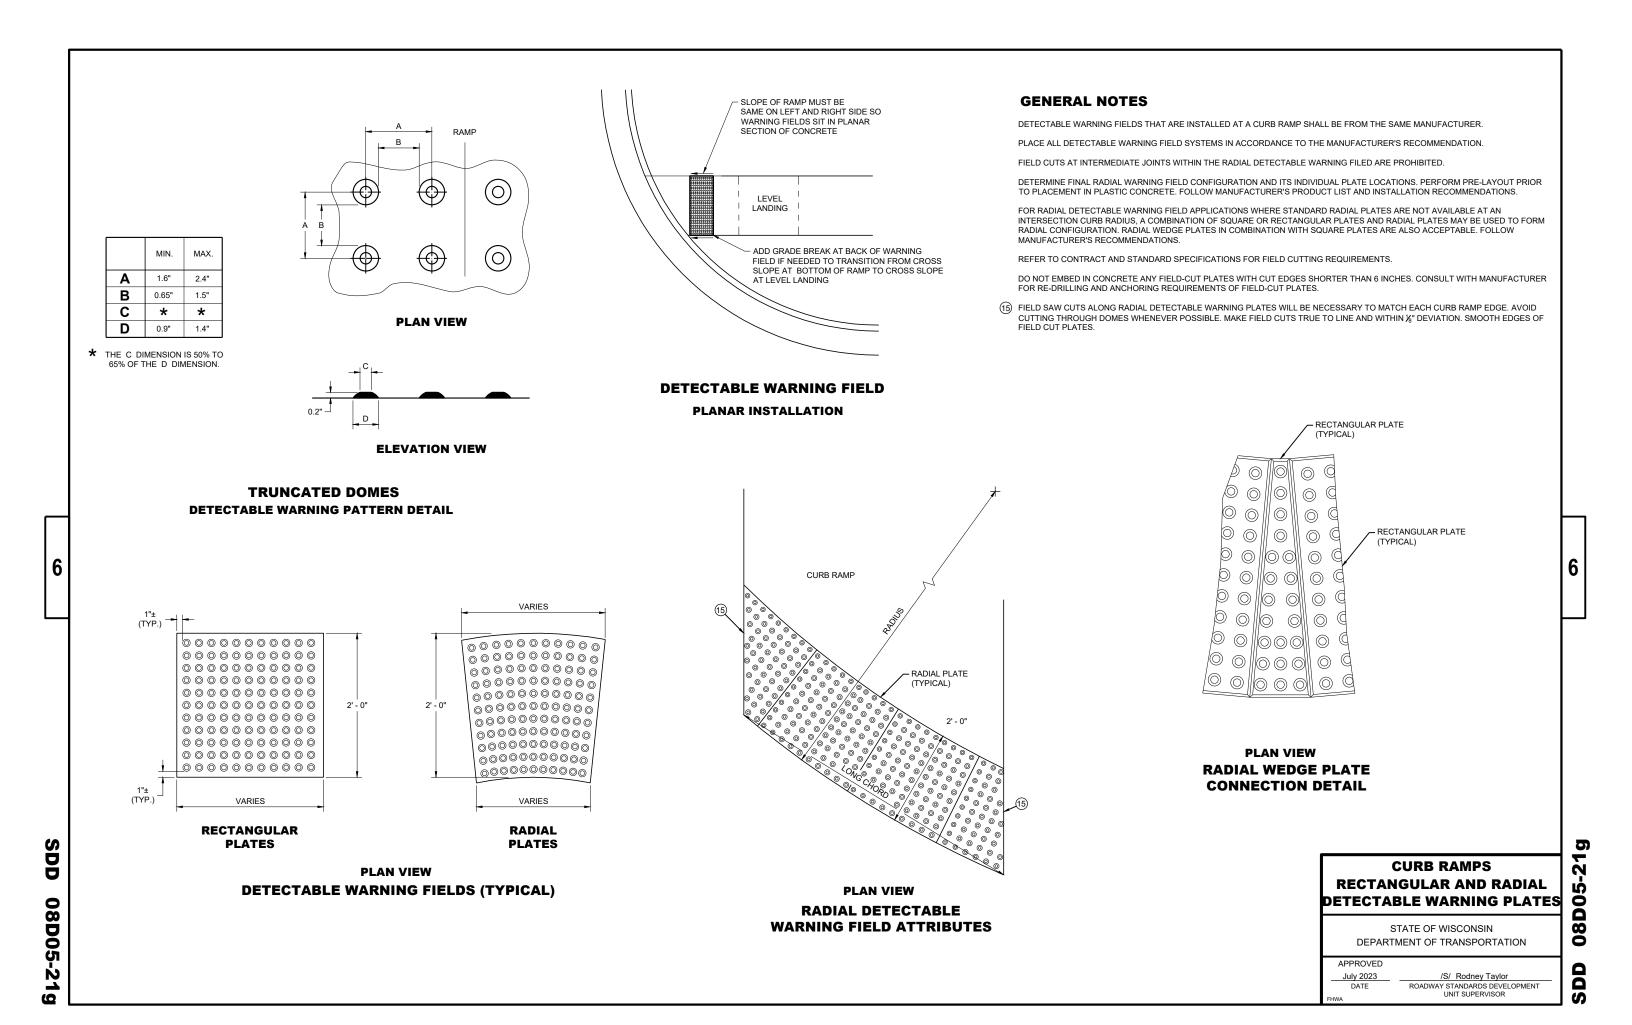


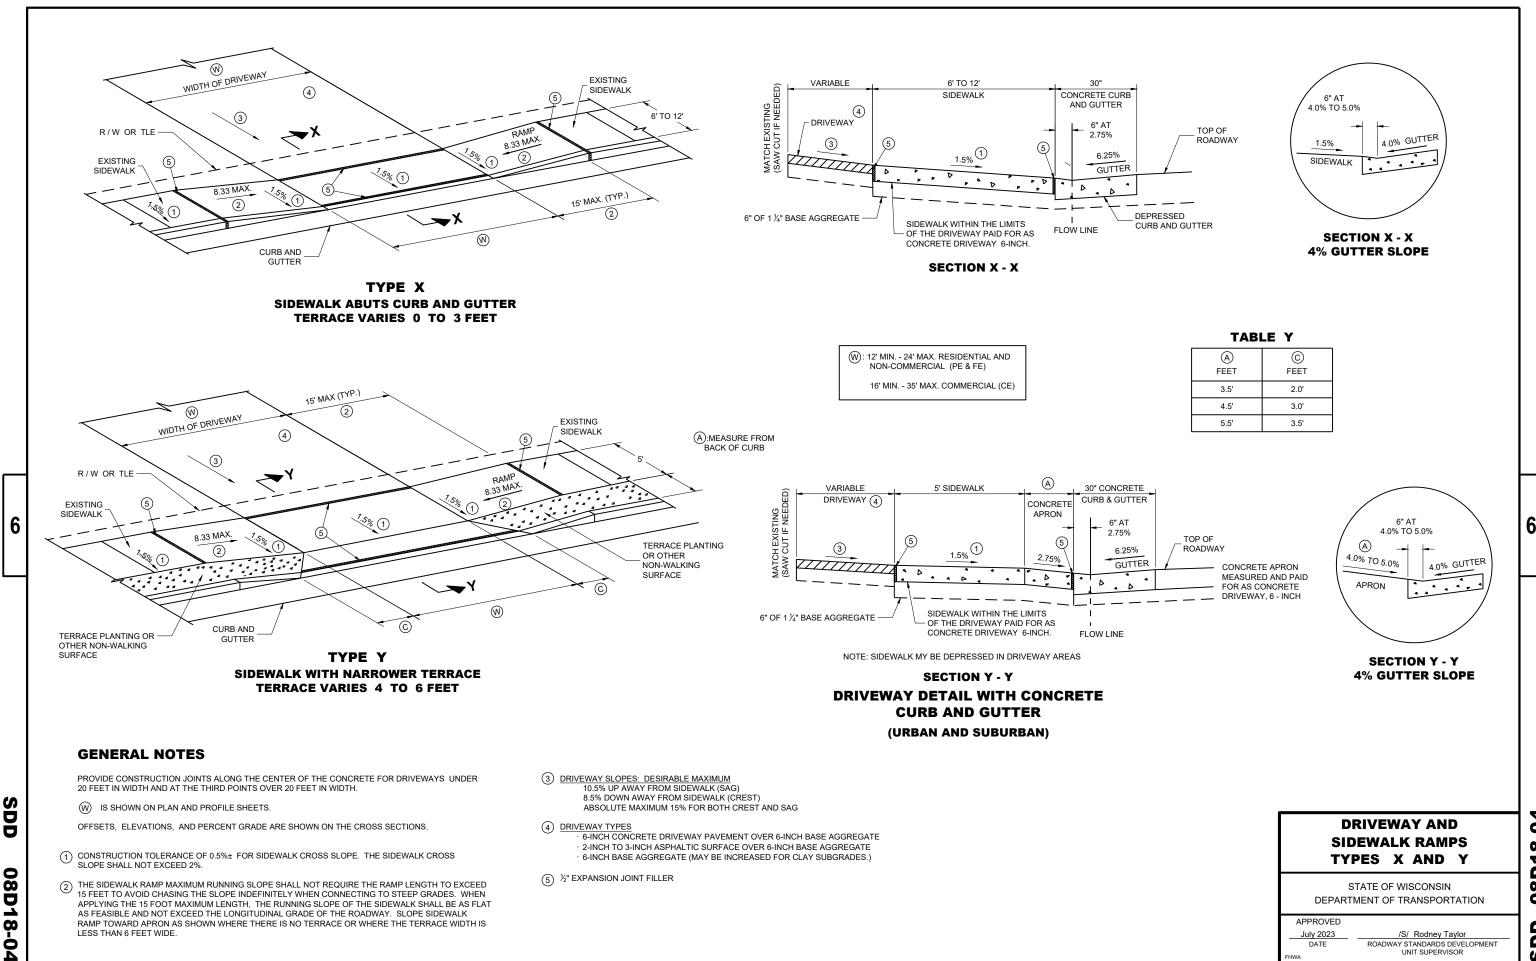

D18-0 ∞ Õ S

ROADWAY STANDARDS DEVELOPMENT UNIT SUPERVISOR

DATE

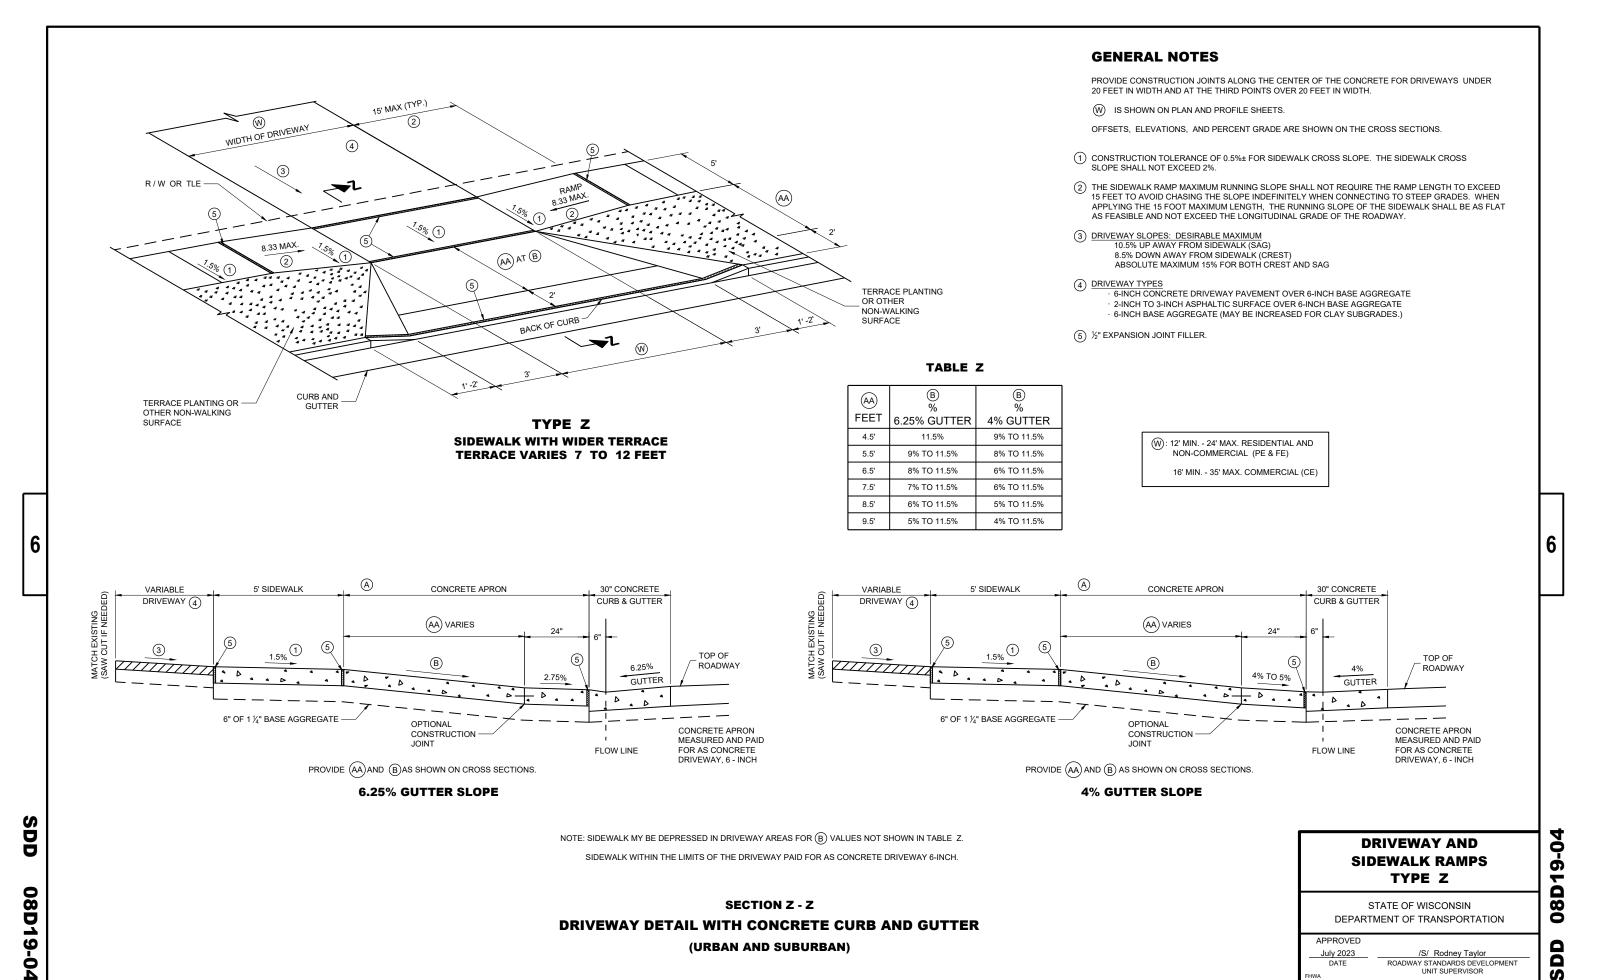

TYPICAL APPLICATION OF SILT FENCE

6

b

Ō

Ш





PLAN VIEW SILT FENCE AT MEDIAN SURFACE DRAINS



GENERAL NOTES

DETAILS OF CONSTRUCTION NOT SHOWN ON THIS DRAWING SHALL CONFORM TO THE PERTINENT REQUIREMENTS OF THE STANDARD SPECIFICATIONS AND APPLICABLE SPECIAL PROVISIONS.

- \bigcirc HORIZONTAL BRACE REQUIRED WITH 2" X 4" WOODEN FRAME OR EQUIVALENT AT TOP OF POSTS.
- ② FOR MANUAL INSTALLATIONS THE TRENCH SHALL BE A MINIMUM OF 4" WIDE & 6" DEEP TO BURY AND ANCHOR THE GEOTEXTILE FABRIC. FOLD MATERIAL TO FIT TRENCH AND BACKFILL & COMPACT TRENCH WITH EXCAVATED SOIL.
- 3 WOOD POSTS SHALL BE A MINIMUM SIZE OF 11/8" X 11/8" OF OAK OR HICKORY.
- 4) SILT FENCE TO EXTEND ACROSS THE TOP OF THE PIPE.
- (5) CONSTRUCT SILT FENCE FROM A CONTINUOUS ROLL IF POSSIBLE BY CUTTING LENGTHS TO AVOID JOINTS. IF A JOINT IS NECESSARY USE ONE OF THE FOLLOWING TWO METHODS; A) OVERLAP THE END POSTS AND TWIST, OR ROTATE, AT LEAST 180 DEGREES, B) HOOK THE END OF EACH SILT FENCE LENGTH.



TRENCH DETAIL



SILT FENCE TIE BACK


(WHEN REQUIRED BY THE ENGINEER)




6

ထ

D.D. 8 E 9-6

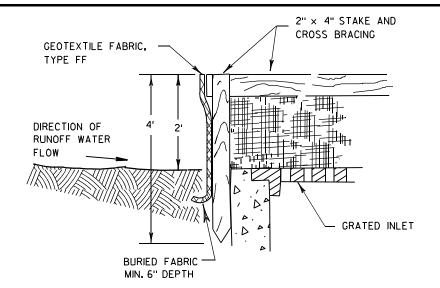

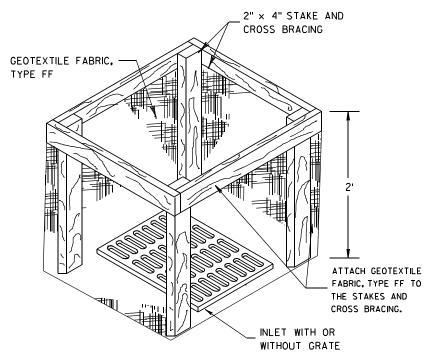

INLET PROTECTION, TYPE A


GENERAL NOTES

INLET PROTECTION DEVICES SHALL BE MAINTAINED OR REPLACED AT THE DIRECTION OF THE ENGINEER.

MANUFACTURED ALTERNATIVES APPROVED AND LISTED ON THE DEPARTMENT'S EROSION CONTROL PRODUCT ACCEPTABILITY LIST MAY BE

WHEN REMOVING OR MAINTAINING INLET PROTECTION, CARE SHALL BE TAKEN SO THAT THE SEDIMENT TRAPPED ON THE GEOTEXTILE FABRIC DOES NOT FALL INTO THE INLET. ANY MATERIAL FALLING INTO THE INLET SHALL BE REMOVED IMMEDIATELY.

- 1) FINISHED SIZE, INCLUDING FLAP POCKETS WHERE REQUIRED, SHALL EXTEND A MINIMUM OF 10" AROUND THE PERIMETER TO FACILITATE MAINTENANCE OR REMOVAL.
- (2) FOR INLET PROTECTION, TYPE C (WITH CURB BOX), AN ADDITIONAL 18" OF FABRIC IS WRAPPED AROUND THE WOOD AND SECURED WITH STAPLES. THE WOOD SHALL NOT BLOCK THE ENTIRE HEIGHT OF THE CURB BOX OPENING.
- (3) FLAP POCKETS SHALL BE LARGE ENOUGH TO ACCEPT WOOD 2X4.

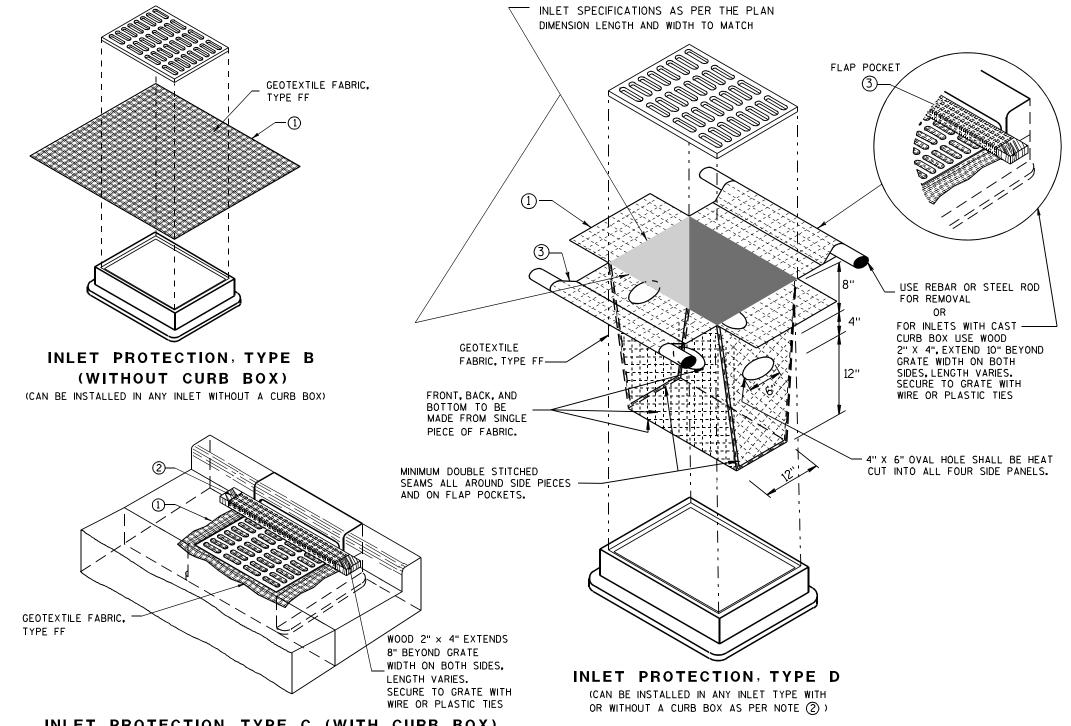

INLET PROTECTION, TYPE C (WITH CURB BOX)

INSTALLATION NOTES

TYPE B & C

TRIM EXCESS FABRIC IN THE FLOW LINE TO WITHIN 3" OF THE GRATE.

THE CONTRACTOR SHALL DEMONSTRATE A METHOD OF MAINTENANCE, USING A SEWN FLAP, HAND HOLDS OR OTHER METHOD TO PREVENT ACCUMULATED SEDIMENT FROM ENTERING THE INLET.

TYPE D

DO NOT INSTALL INLET PROTECTION TYPE D IN INLETS SHALLOWER THAN 30", MEASURED FROM THE BOTTOM OF THE INLET TO THE TOP OF THE GRATE.

TRIM EXCESS FABRIC IN THE FLOW LINE TO WITHIN 3" OF THE GRATE.

THE INSTALLED BAG SHALL HAVE A MINIMUM SIDE CLEARANCE, BETWEEN THE INLET WALLS AND THE BAG, MEASURED AT THE BOTTOM OF THE OVERFLOW HOLES, OF 3". WHERE NECESSARY THE CONTRACTOR SHALL CINCH THE BAG, USING PLASTIC ZIP TIES, TO ACHIEVE THE 3" CLEARANCE, THE TIES SHALL BE PLACED AT A MAXIMUM OF 4" FROM THE BOTTOM OF THE BAG.

INLET PROTECTION TYPE A, B, C, AND D

6

0

ш


 ∞

STATE OF WISCONSIN DEPARTMENT OF TRANSPORTATION

APPROVED

/S/ Beth Cannestra CHIEF ROADWAY DEVELOPMENT ENGINEER

10/16/02

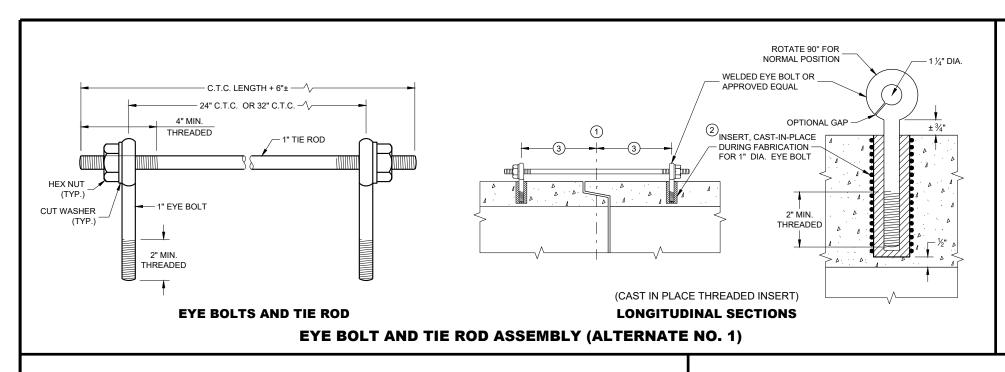

GENERAL NOTES


DETAILS OF CONSTRUCTION, MATERIALS, AND WORKMANSHIP NOT SHOWN ON THIS DRAWING SHALL CONFORM TO THE PERTINENT REQUIREMENTS OF THE STANDARD SPECIFICATIONS AND APPLICABLE SPECIAL PROVISIONS.

CONCRETE CULVERT AND STORM SEWER PIPE SHALL BE TIED TOGETHER IN THE MANNER ILLUSTRATED BY THIS DETAIL AT LOCATIONS DESIGNATED IN THE STANDARD SPECIFICATIONS AND THE PLAN. THE CONTRACTOR MAY USE EITHER ALTERNATE 1, 2 OR 3 FOR DRAINAGE STRUCTURES, ONLY ALTERNATE 1 AND 3 MAY BE USED FOR CATTLE PASSES, UNLESS OTHERWISE STATED IN THE CONTRACT. THE MATERIALS, FABRICATION AND WORK NECESSARY TO TIE THE PIPE BY THIS DETAIL WILL BE CONSIDERED INCIDENTAL TO THE PIPE AND APRON ENDWALLS IF REQUIRED.

DETAILED DRAWINGS FOR PROPOSED ALTERNATE DESIGNS FOR JOINT TIES SHALL BE SUBMITTED TO THE ENGINEER FOR APPROVAL.

JOINT TIES TO BE HOT-DIP GALVANIZED PER ASTM A 153.


- 1) CENTER LINE OF TONGUE AND GROOVE OR BELL AND SPIGOT JOINTS.
- 2 THE INSIDE OF THE THREADED INSERTS SHALL BE CLEAN TO ALLOW THE INSERTION OF THREADED EYE BOLTS.
- (3) HOLES SHALL BE CAST-IN-PLACE OR DRILLED PER THE APPLICABLE DETAIL, AND EQUAL DISTANCE FROM THE CENTERLINE OF THE JOINT.
- 4 BOLT PROJECTION INSIDE OF PIPE SHALL NOT EXCEED 2 INCHES.
- 5 OPENING TO BE ROD DIAMETER PLUS 1 INCH.
- 6 LENGTH ADEQUATE TO EXTEND TO WITHIN ½ INCH OF THE INNER SURFACE OF THE PIPE.
- (7) EYE BOLT LENGTH DETERMINED BY WALL THICKNESS, BELL THICKNESS AND BOLT PROJECTION INSIDE PIPE.

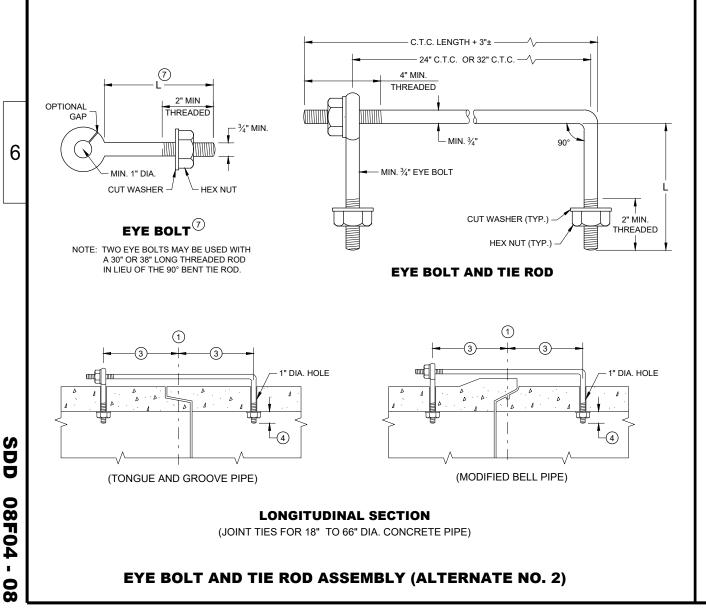


PIPE DIAMETER TIE ROD DIAMETER D L 1 N 12 - 60 ½ 5 ½ 66 - 84 ¾ ¾ 5 ½ 90 - 144 1 1 7 1½

ADJUSTABLE TIE ROD TABLE

DIMENSIONS SHOWN ARE IN INCHES

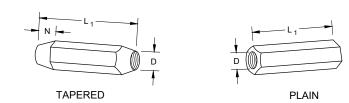


RIGHT AND LEFT THREADS
SLEEVE NUTS

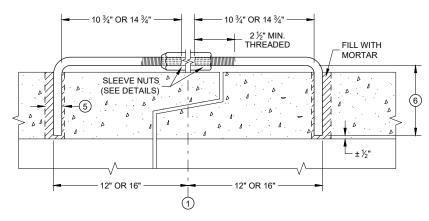


LONGITUDINAL SECTION

ADJUSTABLE TIE ROD (ALTERNATE NO. 3)

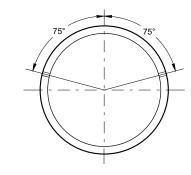

PLACEMENT OF (2) CAST-IN-PLACE INSERTS OR HOLES DURING FABRICATION FOR PIPE SECTIONS REQUIRING TIE RODS

TRANSVERSE SECTION

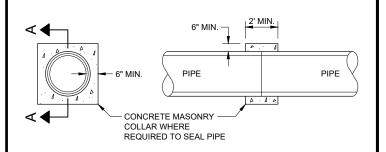

SECTION A - A

CONCRETE COLLAR DETAIL

JOINT TIES FOR CONCRETE PIPE AND CONCRETE COLLAR DETAIL

STATE OF WISCONSIN
DEPARTMENT OF TRANSPORTATION


 APPROVED


 November 2021
 /S/ R


 DATE
 ROADWAY STAN

/S/ Rodney Taylor
ROADWAY STANDARDS DEVELOPMENT
ENGINEER

D 08F04 - 08

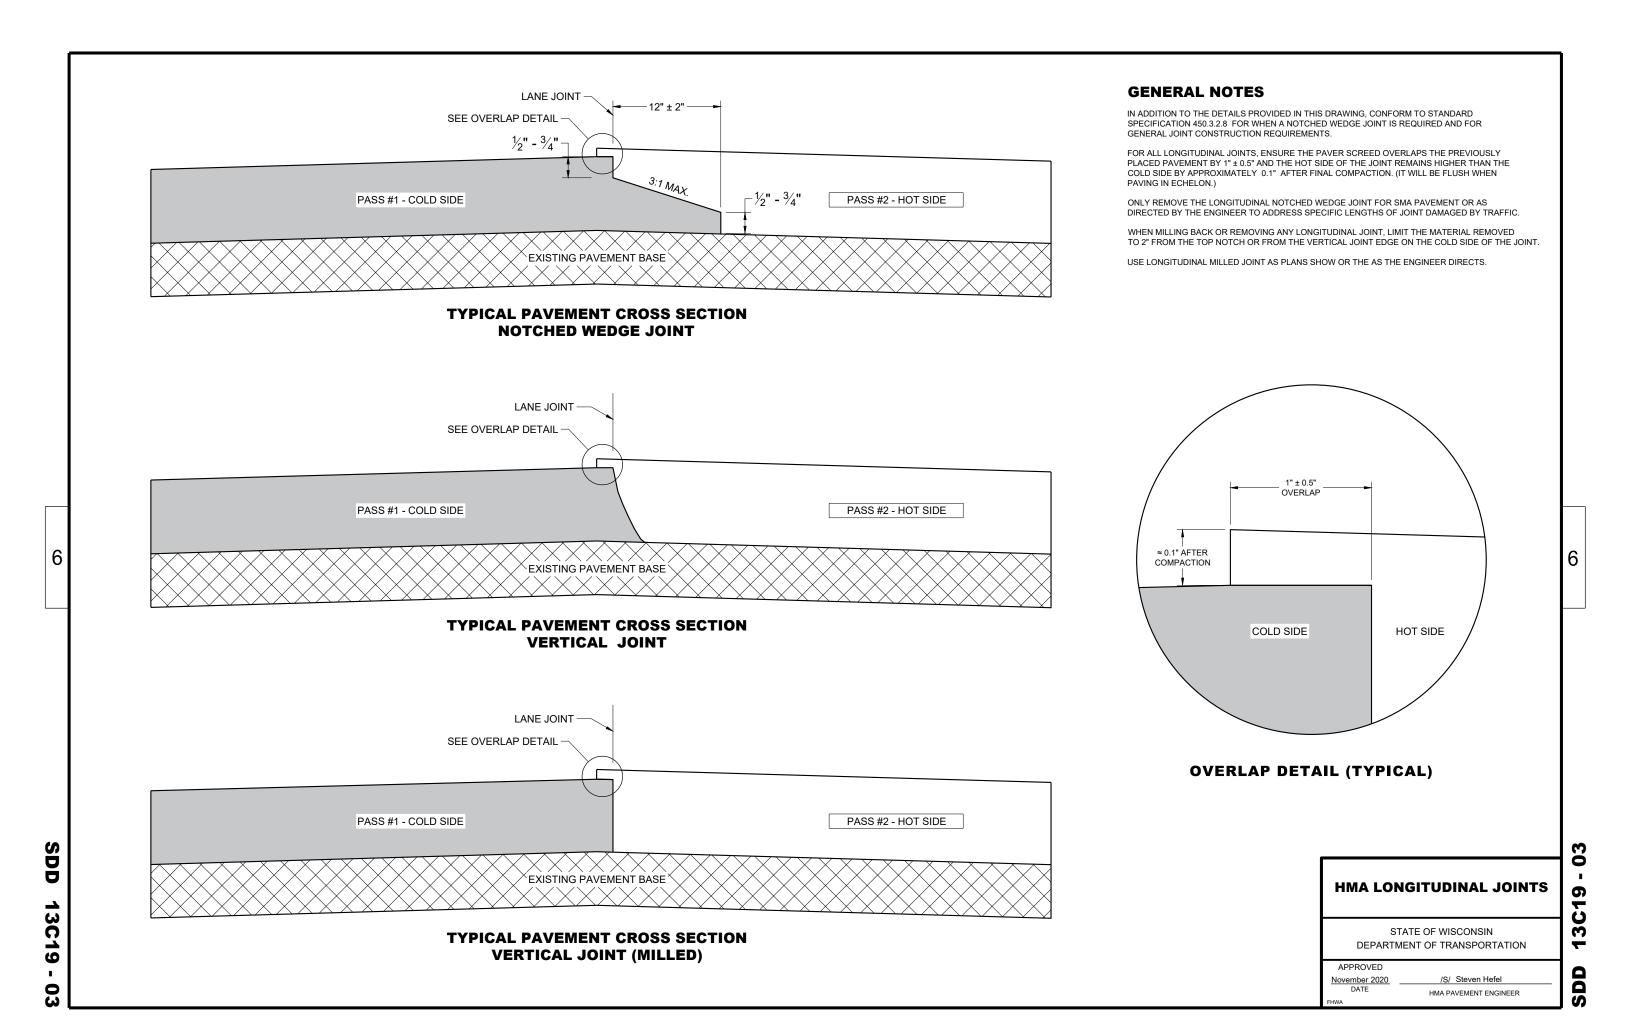


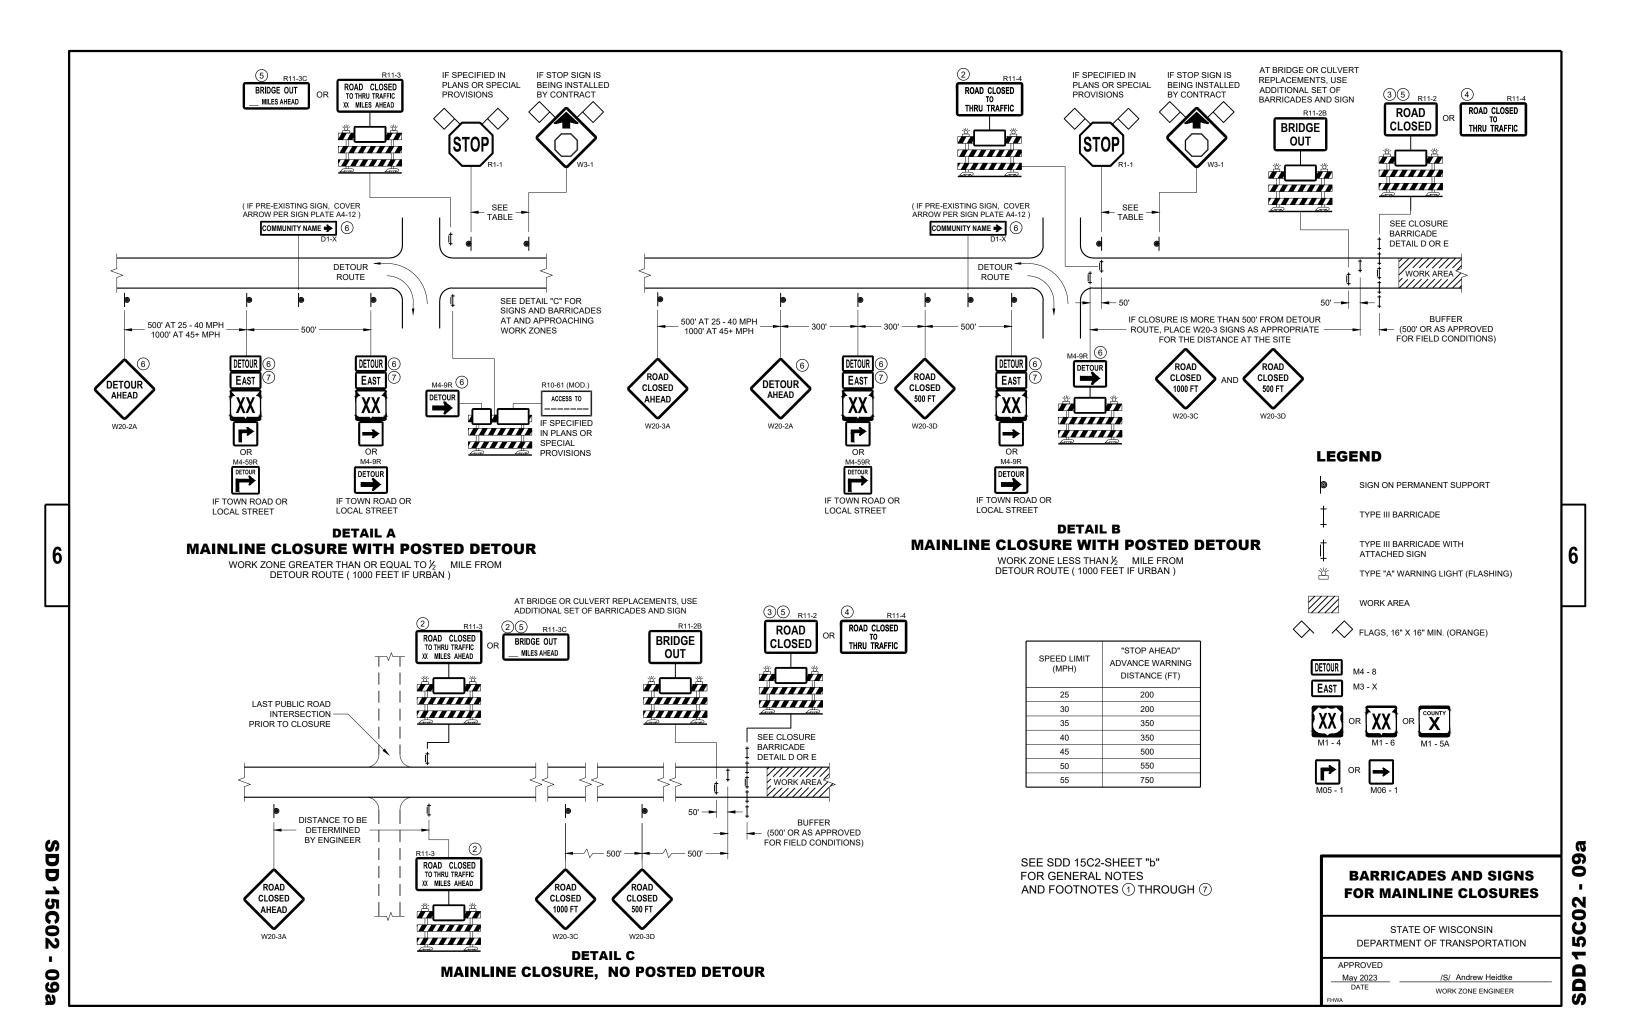

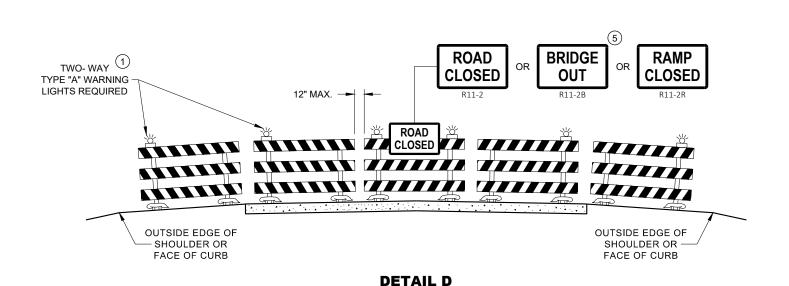

ROAD CLOSURE BARRICADE DETAIL

APPROACH VIEW

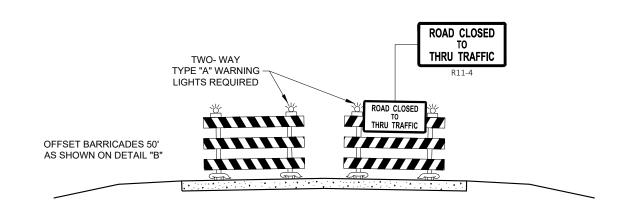

DETAIL E LANE CLOSURE BARRICADE DETAIL APPROACH VIEW

SEE SDD 15C2 - SHEET "a" FOR LEGEND

GENERAL NOTES

THE EXACT NUMBER, LOCATION, AND SPACING OF ALL SIGNS AND BARRICADES SHALL BE ADJUSTED TO FIT FIELD CONDITIONS AS APPROVED BY THE ENGINEER.

ANY SIGNS TEMPORARY OR EXISTING, WHICH CONFLICT WITH TRAFFIC CONTROL "IN USE", SHALL BE REMOVED OR COVERED AS NEEDED AND AS APPROVED BY THE ENGINEER.

THE SPACING BETWEEN TRAFFIC CONTROL SIGNS SHOULD BE ADJUSTED TO NOT CONFLICT WITH AND SHOULD PROVIDE A DESIRABLE MINIMUM OF 200 FEET CLEARANCE TO EXISTING SIGNS THAT WILL REMAIN IN PLACE.

BARRICADES THAT MUST BE MOVED FOR A WORK OPERATION SHALL BE IMMEDIATELY RE-ESTABLISHED UPON COMPLETION OF THE OPERATION, OR FOR CONTINUING OPERATIONS, AT THE END OF EACH WORKING DAY.

SIGNS THAT WILL BE IN PLACE LESS THAN 7 CONTINUOUS DAYS AND NIGHTS MAY BE MOUNTED ON PORTABLE SUPPORTS

ALL TYPE III BARRICADES SHALL HAVE RAILS REFLECTORIZED ON BOTH FACES. STRIPES SHALL BE PROPERLY SLOPED DOWN TOWARD THE TRAFFIC SIDE OR AS SHOWN IN THE ROAD CLOSURE BARRICADE DETAIL "D" FOR FULL ROAD CLOSURES.

TYPE "A" LOW - INTENSITY FLASHING WARNING LIGHTS SHALL BE VISIBLE ON BOTH SIDES OF THE BARRICADE.

THE R11 - 2, R11 - 3, M4 - 9, R11 - 4, AND R10 - 61 SIGNS PLACED ON THE BARRICADES SHALL COVER NO MORE THAN THE TOP RAIL. THE SIGNS SHALL NOT COVER ANY PORTION OF THE MIDDLE RAIL OR BOTTOM RAILS.

"WO" AND "MO" SIGNS ARE THE SAME AS "W" AND "M" SIGNS EXCEPT THE BACKGROUND IS ORANGE.

ALL SIGNS SHALL BE 48" X 48" UNLESS OTHERWISE NOTED BELOW:

R11 - 2 SHALL BE 48" X 30"

R11 - 3 SHALL, R11 - 4 AND R10 - 61 SHALL BE 60 " X 30"

M4 - 9 SHALL BE 30" X 24"

M3 - X SHALL BE 24" X 12" (36" X 18" IF NEEDED TO MATCH EXISTING SIGNS)

M4 - 8 SHALL BE 24" X 12" (36" X 18" IF NEEDED TO MATCH EXISTING SIGNS)

M1 - 4, M1 - 5A AND M1 - 6 SHALL BE 24" X 24" (36" X 36" IF NEEDED TO MATCH EXISTING SIGNS)

MO5 - 1 AND MO6 - 1 SHALL BE 21" X 21" (30" X 30" IF NEEDED TO MATCH EXISTING SIGNS)

D1 - X SHALL BE AS SHOWN ON SPECIFIC PROJECT SIGNING DETAIL SHEETS.


R1 - 1 SHALL BE 36" X 36"

- TWO WARNING LIGHTS SHALL BE PROVIDED ON THE CENTER BARRICADE AND A MINIMUM OF ONE WARNING LIGHT SHALL BE PROVIDED ON EACH OF THE OTHER BARRICADES WITHIN THE ROADWAY LIMITS. SPACING OF THE WARNING LIGHTS SHALL BE UNIFORM TO THE EDGE OF ROADWAY AS SHOWN (APPROX. 8 FOOT LIGHT SPACING.
- THESE SIGNS AND BARRICADES ARE NOT REQUIRED IF ROAD CLOSURE BEGINS AT AN INTERSECTION.
- (3) FOR ROAD CLOSURE <u>WITHOUT</u> LOCAL ACCESS TO PROJECT, SEE ROAD CLOSURE BARRICADE DETAIL "D".
- (4) FOR ROAD CLOSURE WITH LOCAL ACCESS TO PROJECT, SEE ROAD CLOSURE BARRICADE DETAIL "E".
- (5) FOR BRIDGE OR CULVERT REPLACEMENTS, SUBSTITUTE "BRIDGE OUT" INSTEAD OF "ROAD CLOSED" ON R11 2 AND R11 3 SIGNS.
- (6) INSTALL DETOUR AND COMMUNITY GUIDE SIGNS AND ARROWS ONLY IF SPECIFIED IN THE CONTRACT. IF THERE ARE EXISTING ROUTE MARKER ASSEMBLIES THAT WILL REMAIN IN PLACE, ADJUST THE LOCATION OF THE DETOUR ROUTE SIGNS TO CORRESPOND WITH THE EXISTING ASSEMBLIES. MODIFY EXISTING SIGNS WHERE POSSIBLE. SEE SPECIFIC PROJECT DETOUR SIGNING DETAIL SHEETS. IF DETOUR SIGNS ARE BEING INSTALLED BY OTHERS, PLACE THE CONTRACTED TRAFFIC CONTROL SIGNS TO ALLOW FOR PLACEMENT OF ALL WARNING, DETOUR AND GUIDE SIGNS AS SHOWN.
- (7) "EAST" CARDINAL DIRECTION MARKERS AND RIGHT TURN ARROWS ARE SHOWN. USE OTHER CARDINAL DIRECTIONS AND ARROWS AS APPROPRIATE.

BARRICADES AND SIGNS FOR VARIOUS CLOSURES

STATE OF WISCONSIN
DEPARTMENT OF TRANSPORTATION

15C02 - 0

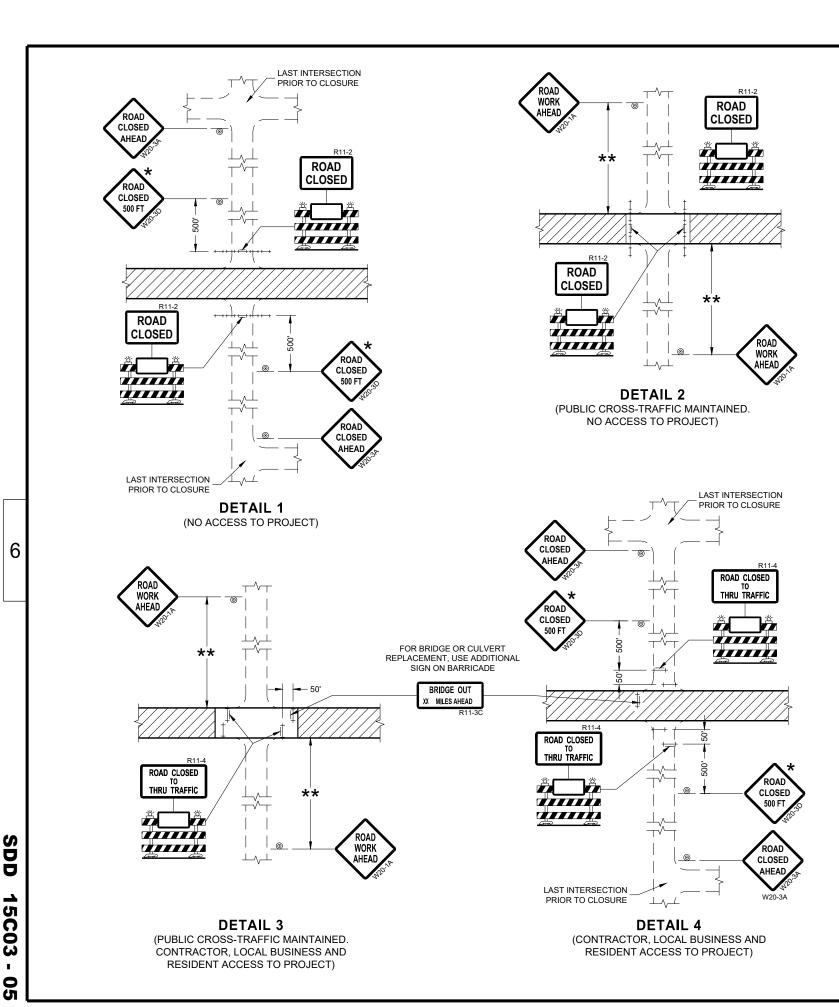

GENERAL NOTES

THE EXACT NUMBER, LOCATION, AND SPACING OF ALL SIGNS AND BARRICADES SHALL BE ADJUSTED TO FIT FIELD CONDITIONS AS APPROVED BY THE ENGINEER.

ANY SIGNS TEMPORARY OR EXISTING, WHICH CONFLICT WITH TRAFFIC CONTROL "IN USE" SHALL BE REMOVED OR COVERED AS NEEDED AND AS APPROVED BY THE ENGINEER.

THE SPACING BETWEEN TRAFFIC CONTROL SIGNS SHOULD BE ADJUSTED TO NOT CONFLICT WITH AND SHOULD PROVIDE A DESIRABLE MINIMUM OF 200 FEET CLEARANCE (500 FEET DESIRABLE) TO EXISTING SIGNS THAT WILL REMAIN IN PLACE.

IF A "STOP" SIGN MUST BE REMOVED FOR A WORK OPERATION, A TEMPORARY "STOP" SIGN SHALL BE PLACED PRIOR TO THE SIGN REMOVAL, OR A FLAGGER SHALL BE PROVIDED UNTIL THE SIGN IS REESTABLISHED.

BARRICADES THAT MUST BE MOVED FOR A WORK OPERATION SHALL BE IMMEDIATELY REESTABLISHED UPON COMPLETION OF THE OPERATION OR FOR CONTINUING OPERATIONS, AT THE END OF EACH WORKING DAY.

SIGNS THAT WILL BE IN PLACE LESS THAN SEVEN CONTINUOUS DAYS AND NIGHTS MAY BE MOUNTED ON PORTABLE SUPPORTS.

ALL TYPE III BARRICADES SHALL HAVE RAILS REFLECTORIZED ON BOTH FACES. STRIPES SHALL BE PROPERLY SLOPED DOWN TOWARD THE TRAFFIC SIDE OR AS SHOWN IN THE ROAD CLOSURE BARRICADE DETAIL "D" FOR FULL ROAD CLOSURES.

TYPE "A" LOW-INTENSITY FLASHING WARNING LIGHTS SHALL BE VISIBLE ON BOTH SIDES OF THE BARRICADE.

THE R11-2, R11-3, AND R11-4 SIGNS PLACED ON BARRICADES SHALL COVER NO MORE THAN THE TOP RAIL. THE SIGNS SHALL NOT COVER ANY PORTION OF THE MIDDLE OR BOTTOM RAILS.

ALL SIGNS SHALL BE 48" X 48" UNLESS OTHERWISE NOTED BELOW: R11-2 SHALL BE 48" X 30".
R11-4 AND R11-3 SHALL BE 60" X 30".

- ★ OMIT THE "ROAD CLOSED 500 FT." SIGN IF THE LAST INTERSECTION IS 500 FEET OR LESS FROM THE WORK ZONE.
- ** 500' MAX. OR AT LAST INTERSECTION, WHICHEVER IS CLOSEST.

LEGEND

SIGN ON PERMANENT SUPPORT

TYPE III BARRICADE

TYPE III BARRICADE WITH ATTACHED SIGN

TYPE "A" WARNING LIGHT (FLASHING)

WORK AREA


BARRICADES AND SIGNS FOR SIDEROAD CLOSURES


STATE OF WISCONSIN
DEPARTMENT OF TRANSPORTATION

 APPROVED


 July 2018
 /S/ Andrew Heidtke


 DATE
 WORK ZONE ENGINEER

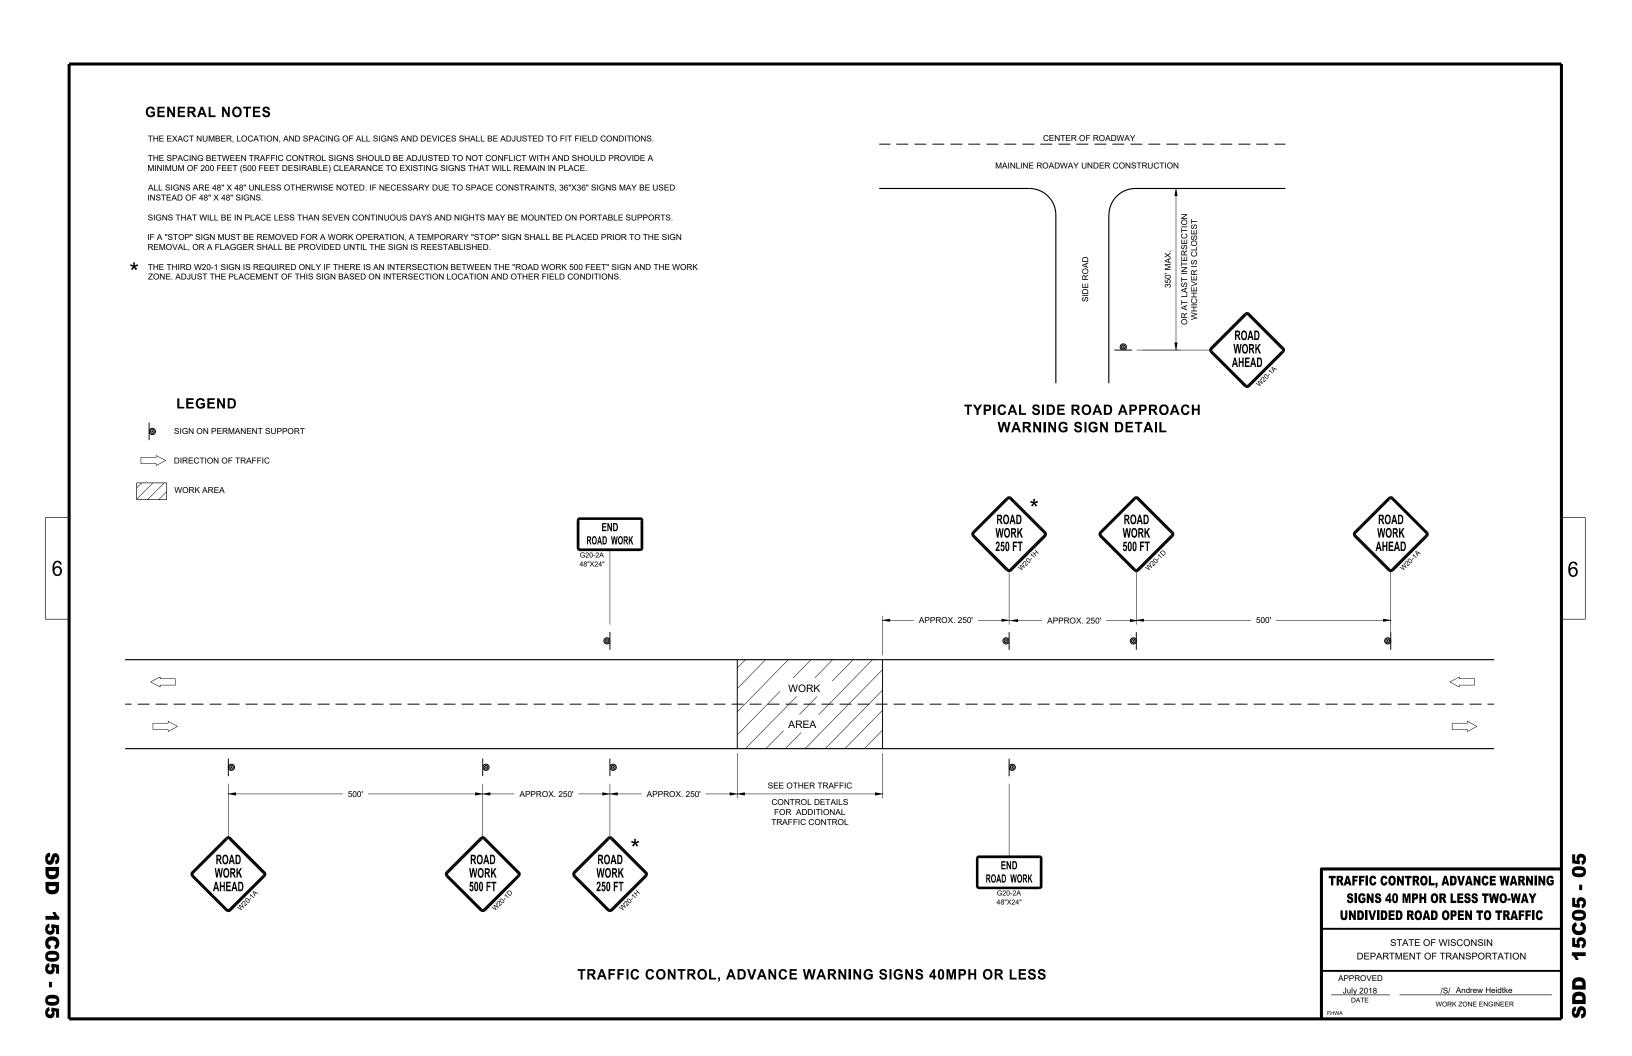

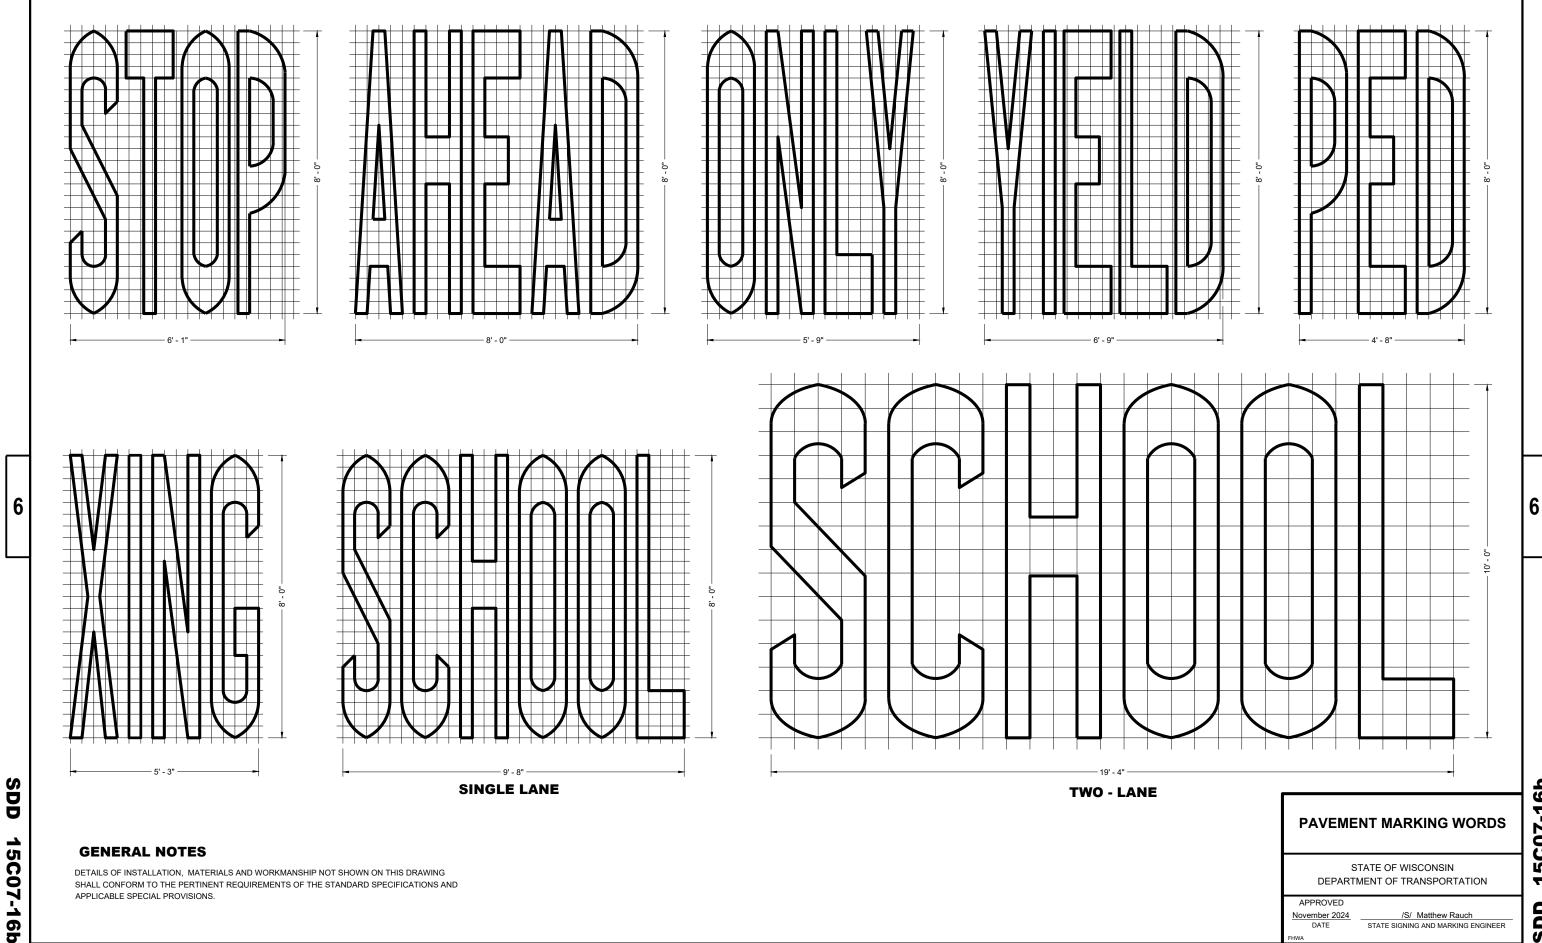

15C07-16b SDD

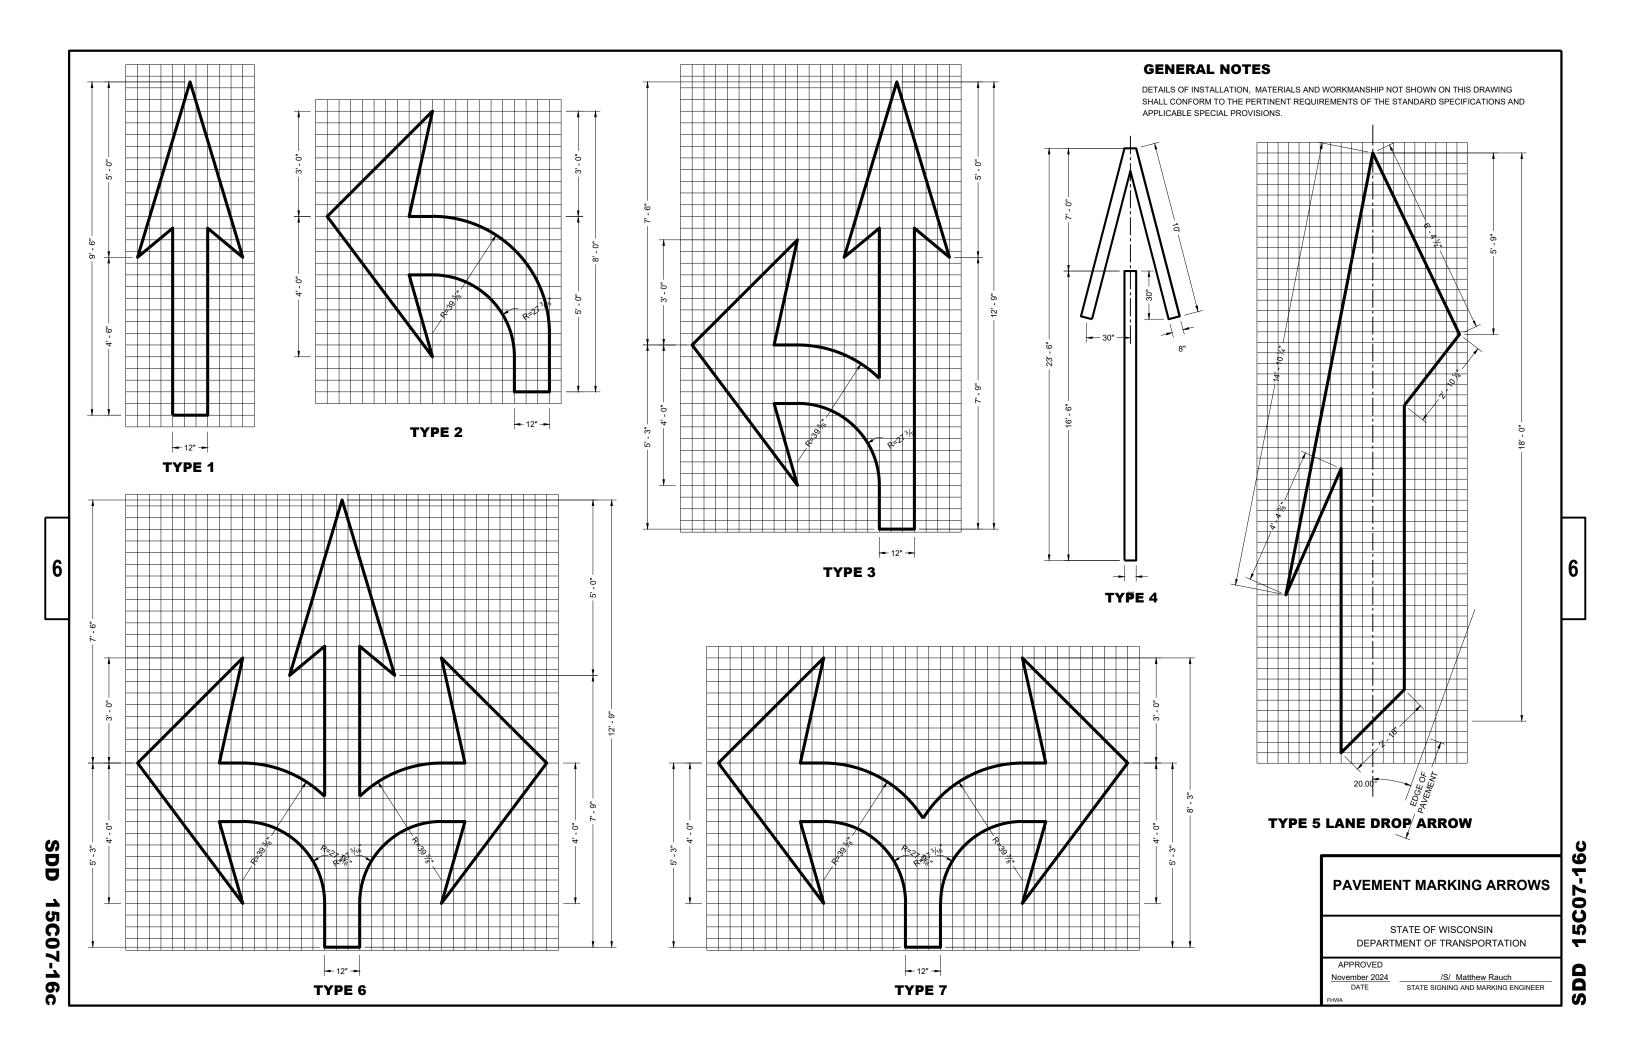

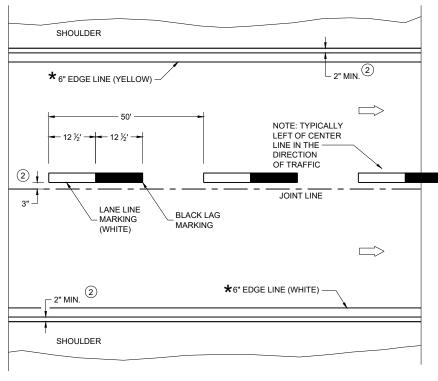

ONE WAY TRAFFIC

PERMANENT PAVEMENT MARKING

GENERAL NOTES

DETAILS OF CONSTRUCTION NOT SHOWN ON THIS DRAWING SHALL CONFORM TO STANDARD SPECIFICATIONS AND SPECIAL PROVISIONS.

- 1) LOCATE THE NO PASSING ZONE W14-3 SIGN WITHIN 50 FEET OF THE "T" MARKING
- (2) MEASURE FROM EDGE OF MARKING TO JOINT LINE. THIS DOES NOT INCLUDE SPACE NEEDED FOR GROOVING OPERATIONS.

LEGEND

"T" MARKING

SIGN ON PERMANENT SUPPORT

DIRECTION OF TRAFFIC

PERMANENT LONGITUDINAL **PAVEMENT MARKINGS**

STATE OF WISCONSIN DEPARTMENT OF TRANSPORTATION

May 2023 DATE

Statewide Pavement Marking Engineer


/S/ Jeannie Silver

6


SDD

15C08-23a

C08-23 Ŋ SD

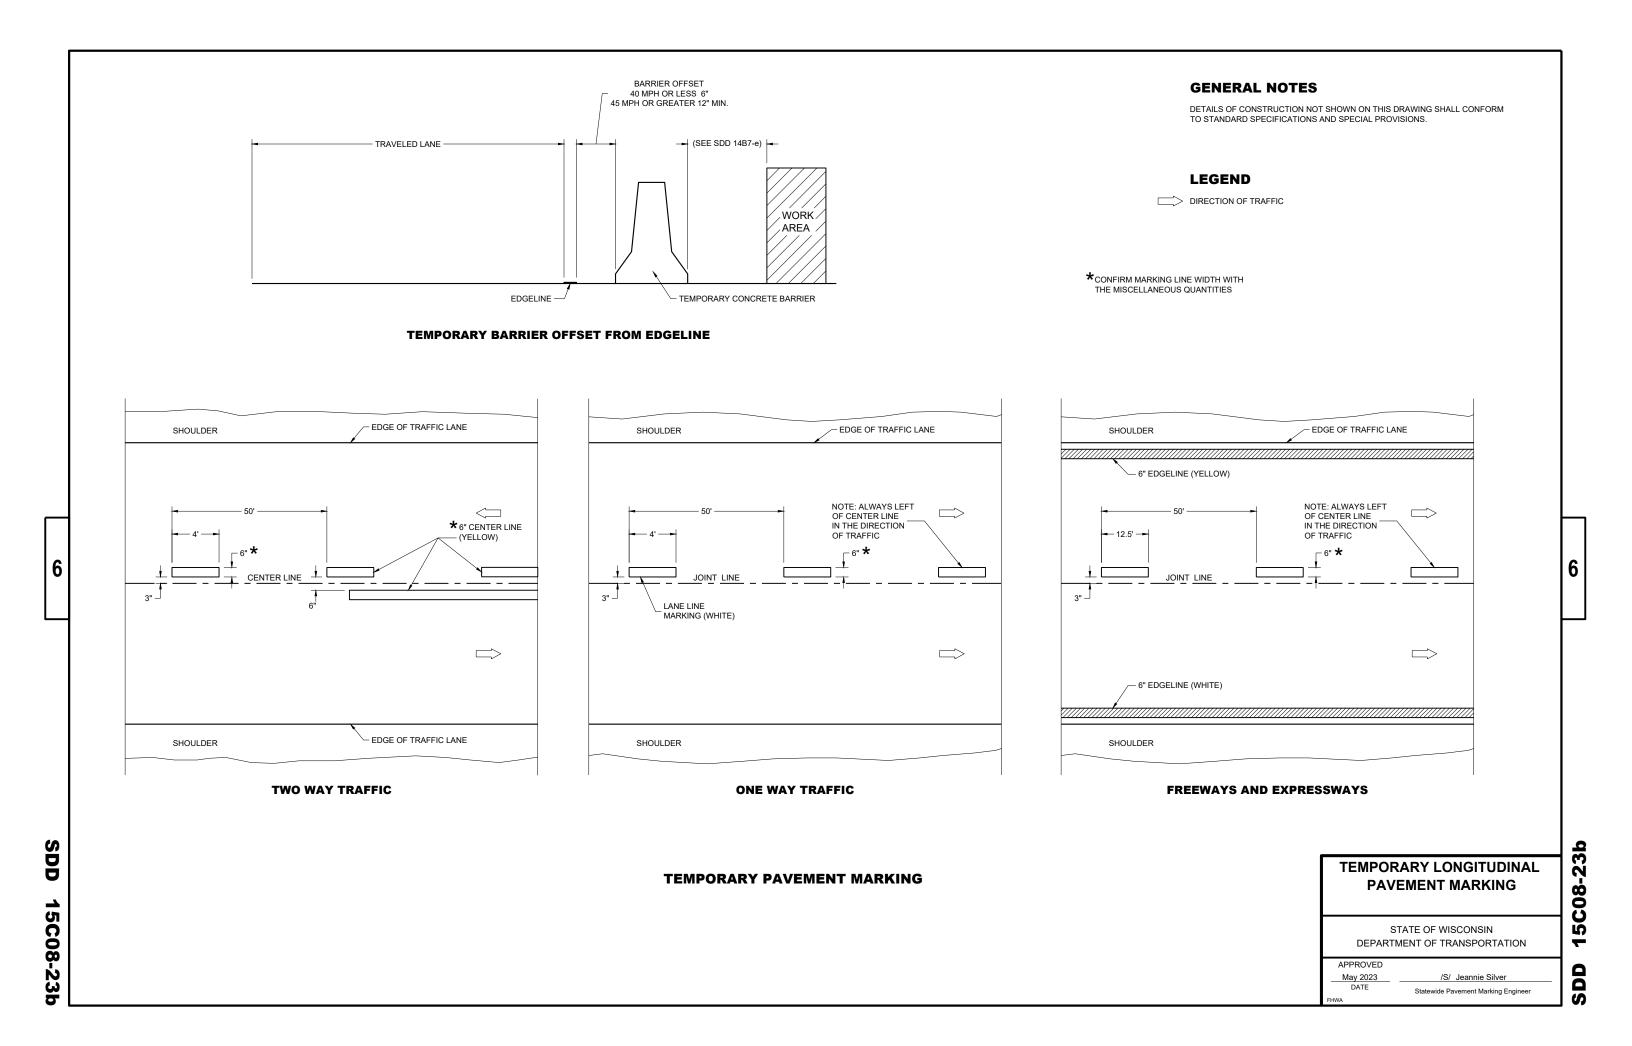


STATE OF WISCONSIN DEPARTMENT OF TRANSPORTATION

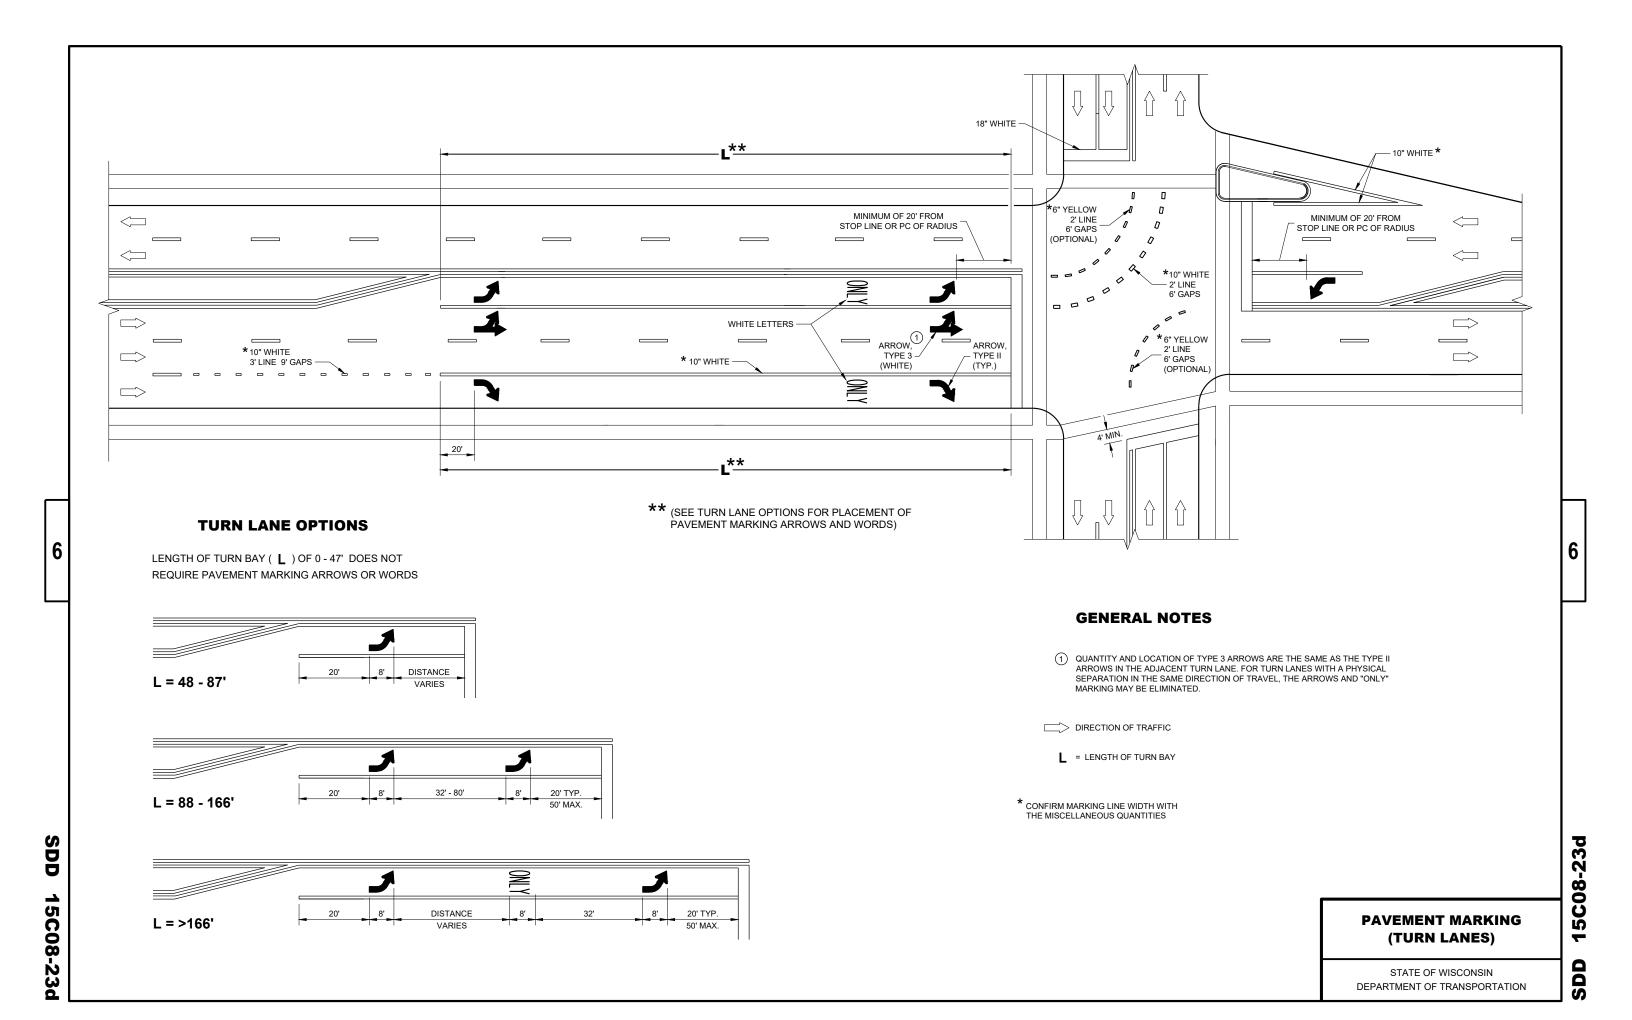


GENERAL NOTES

- (1) REFLECTIVE SHEETING SHALL FOLLOW THE REQUIREMENTS IN THE APPROVED PRODUCTS LISTING FOR SIGN SHEETING.
- (2) LOCATION OF WARNING LIGHTS WHEN SHOWN ON THE PLAN.

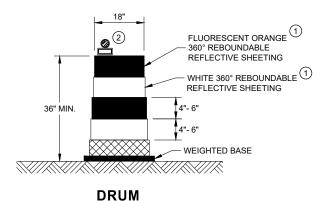


BALLAST WIDTHS RANGE FROM 24"-36"

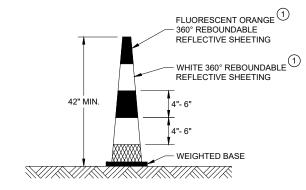


42" CONE

DO NOT USE IN TAPERS ½ SPACING OF DRUMS BALLAST WIDTHS RANGE FROM 14"-20"

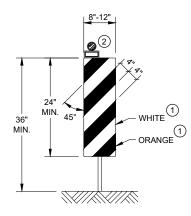


VERTICAL PANEL

THE STRIPES SHALL SLOPE DOWNWARD TO THE TRAFFIC SIDE FOR CHANNELIZATION.

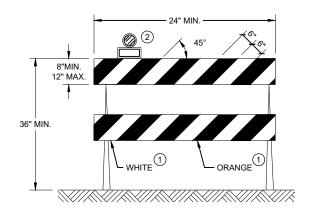

TYPE II BARRICADE

FOR RAILS LESS THAN 36" LONG, 4" WIDE STRIPES MAY BE USED. ALL STRIPES SHALL SLOPE DOWNWARD TO THE TRAFFIC SIDE FOR CHANNELIZATION.

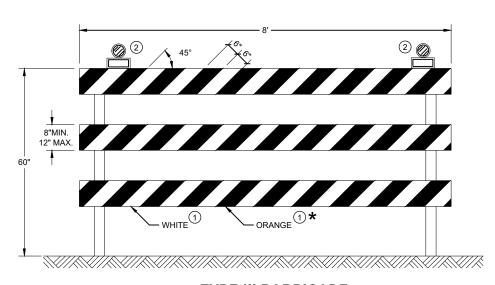

TYPE III BARRICADE

IF SIGN MOUNTED, DO NOT COVER MORE THAN 50% OF THE TOP TWO RAILS OR 33% OF THE TOTAL AREA OF THE THREE RAILS.

* IF USED FOR A PERMANENT APPLICATION USE RED SHEETING.

CHANNELIZING DEVICES DRUMS, CONES, BARRICADES AND VERTICAL PANELS

STATE OF WISCONSIN DEPARTMENT OF TRANSPORTATION 15C

APPROVED	
November 2022	/S/ Andrew Heidtke
DATE	WORK ZONE ENGINEER
ELDA/A	

END

WORK

RUMBLE

STRIPS

ROAD

GENERAL NOTES FLAGGING DETAILS OF TRAFFIC CONTROL DEVICES AND INSTALLATION NOT SHOWN ON THIS DRAWING SHALL CONFORM TO THE PERTINENT REQUIREMENTS OF THE STANDARD SPECIFICATIONS, THE SPECIAL PROVISIONS, AND THE MANUAL ON FLAGGERS SHALL BE IN SIGHT OF EACH OTHER OR IN DIRECT COMMUNICATION AT ALL TIMES. THEY SHALL BE EQUIPPED WITH STOP/SLOW PADDLES FASTENED ON SUPPORT STAFFS. WHEN THE FLAGGING OPERATION IS NOT IN EFFECT REMOVE TEMPORARY SIGN ON PORTABLE OR PERMANENT SUPPORT UNIFORM TRAFFIC CONTROL DEVICES. PORTABLE RUMBLE STRIPS PRIOR TO COVERING OR REMOVING ALL ADVANCE SIGNING. ① FOR MOVING WORK OPERATIONS, POST ADDITIONAL W20-7A FLAGGER SIGNS AT APPROXIMATELY 3,500' INTERVALS IN THE MOVING ALL SIGNS ARE 48" X 48" UNLESS OTHERWISE NOTED. TEMPORARY PORTABLE RUMBLE WORK OPERATION OR AS APPROVED BY THE ENGINEER. "WO" SIGNS ARE THE SAME AS "W" SIGNS EXCEPT THE BACKGROUND IS ORANGE. (2) SIGN NOT REQUIRED IF FLAGGING OPERATION OCCURS WITHIN A SIGNED ROAD WORK ZONE AREA. THE EXACT NUMBER, LOCATION AND SPACING OF ALL SIGNS, DEVICES, AND LOCATION OF ALL FLAGGERS SHALL BE DIRECTION OF TRAFFIC ADJUSTED TO FIT FIELD CONDITIONS AS APPROVED BY THE ENGINEER. WHEN THE DISTANCE BETWEEN FLAGGERS EXCEEDS 2 MILES, A PILOT CAR IS REQUIRED. WHEN CURVES REDUCE SIGHT DISTANCE BELOW 400', A PILOT CAR IS REQUIRED. THE FIRST ADVANCE WARNING SIGN SHOULD TYPICALLY BE LOCATED IN ADVANCE OF THE ANTICIPATED TRAFFIC BACKUP **TEMPORARY PORTABLE RUMBLE STRIPS** WHEN A SIDE ROAD OR RAMP INTERSECTS THE FACILITY ON WHICH THE WORK IS BEING PERFORMED, ADDITIONAL UTILIZE TEMPORARY PORTABLE RUMBLE STRIPS ON ALL FLAGGING OPERATIONS. TRAFFIC CONTROLS SHALL BE PROVIDED AS SPECIFIED IN THE PLANS AND/OR THE SPECIAL PROVISIONS OR AS APPROVED FLAGGER, EQUIPPED WITH STOP/SLOW ③ EACH TEMPORARY PORTABLE RUMBLE STRIP ARRAY CONSISTS OF THREE RUMBLE STRIPS PLACED TRANSVERSE ACROSS THE LANE AT PADDLE FASTENED ON SUPPORT STAFF THE LOCATIONS SHOWN. WITHIN EACH ARRAY, SPACING BETWEEN RUMBLE STRIPS SHALL BE 15 FEET ON CENTER ONLY USE TEMPORARY PORTABLE RUMBLE STRIPS FROM THE APPROVED PRODUCTS LIST. INSTALL TEMPORARY RUMBLE STRIPS PER MANUFACTURER'S RECOMMENDATIONS. PLACE ADVANCE SIGNING PRIOR TO INSTALLING TEMPORARY RUMBLE STRIPS. DO NOT INSTALL TEMPORARY PORTABLE RUMBLE STRIPS ON GRAVEL, MILLED SURFACES, OR ASPHALT THAT HAS BEEN PAVED LESS THAN 12 HOURS. SIGN AND TEMPORARY RUMBLE STRIP ARRAY SPACING TABLE BE SPACING "A" SPEED LIMIT USE OF WO3-4 SIGN IS OPTIONAL. WHEN USED, PREPARED THIS SIGN SHALL BE LOCATED BETWEEN THE 25-30 MPH TO STOP W20-7A AND W20-4A SIGNS, USING SPACING "A". 35-40 MPH 350' STOP/SLOW PADDLE ŔUMBLĖ 45-55 MPH 500' WO3-4 WORK **ON SUPPORT STAFF** ROAD STRIPS 1 VARIABLE DISTANCE - 200' - 300' (TYP.) |||3 WORK AREA A/2 END ROAD WORK 200' - 300' (TYP.) VARIABLE DISTANCE

TRAFFIC CONTROL FOR LANE CLOSURE WITH **FLAGGING OPERATION**

0

2

Ŋ

STATE OF WISCONSIN DEPARTMENT OF TRANSPORTATION

(O.) A., J.,
/S/ Andrew Heidtke
WORK ZONE ENGINEER

GENERAL NOTES

DETAILS OF TRAFFIC CONTROL DEVICES AND INSTALLATION NOT SHOWN ON THIS DRAWING SHALL CONFORM TO THE PERTINENT REQUIREMENTS OF THE STANDARD SPECIFICATIONS, THE SPECIAL PROVISIONS, AND THE MANUAL ON UNIFORM TRAFFIC CONTROL DEVICES.

ALL SIGNS ARE 48" X 48" UNLESS OTHERWISE NOTED.

"WO" SIGNS ARE THE SAME AS "W" SIGNS EXCEPT THE BACKGROUND IS ORANGE.

THE EXACT NUMBER, LOCATION AND SPACING OF ALL SIGNS, DEVICES, AND LOCATION OF ALL FLAGGERS SHALL BE ADJUSTED TO FIT FIELD CONDITIONS AS APPROVED BY THE ENGINEER.

THE FIRST ADVANCE WARNING SIGN SHOULD TYPICALLY BE LOCATED IN ADVANCE OF THE ANTICIPATED TRAFFIC BACKUP OR QUELIE

WHEN A SIDE ROAD OR RAMP INTERSECTS THE FACILITY ON WHICH THE WORK IS BEING PERFORMED, ADDITIONAL TRAFFIC CONTROLS SHALL BE PROVIDED AS SPECIFIED IN THE PLANS AND/OR THE SPECIAL PROVISIONS OR AS APPROVED BY THE ENGINEER.

FLAGGING

IF THE AUTOMATED FLAGGER ASSISTANCE DEVICE (AFAD) STOPS WORKING, FLAGGERS SHALL BE IN SIGHT OF EACH OTHER OR IN DIRECT COMMUNICATION AT ALL TIMES. THEY SHALL BE EQUIPPED WITH STOP/SLOW PADDLES FASTENED ON SUPPORT STAFFS. WHEN THE FLAGGING OPERATION IS NOT IN EFFECT REMOVE TEMPORARY PORTABLE RUMBLE STRIPS PRIOR TO COVERING OR REMOVING ALL ADVANCE SIGNING.

WHEN THE DISTANCE BETWEEN FLAGGERS EXCEEDS 2 MILES, A PILOT CAR IS REQUIRED. WHEN CURVES REDUCE SIGHT DISTANCE BELOW 400', A PILOT CAR IS REQUIRED.

- 1) SIGN NOT REQUIRED IF FLAGGING OPERATION OCCURS WITHIN A SIGNED ROAD WORK ZONE AREA.
- (2) IF FLAGGERS ARE PHYSICALLY NEEDED TO FLAG, REPLACE WO3-4 SIGNS WITH W20-7A SIGNS.

TEMPORARY PORTABLE RUMBLE STRIPS

UTILIZE TEMPORARY PORTABLE RUMBLE STRIPS ON ALL FLAGGING OPERATIONS

ONLY USE TEMPORARY PORTABLE RUMBLE STRIPS FROM THE APPROVED PRODUCTS LIST.

PLACE ADVANCE SIGNING PRIOR TO INSTALLING TEMPORARY RUMBLE STRIPS.


DO NOT INSTALL TEMPORARY PORTABLE RUMBLE STRIPS ON GRAVEL, MILLED SURFACES, OR ASPHALT THAT HAS BEEN PAVED LESS THAN 12 HOURS.

(3) EACH TEMPORARY PORTABLE RUMBLE STRIP ARRAY CONSISTS OF THREE RUMBLE STRIPS PLACED TRANSVERSELY AT THE LOCATIONS SHOWN. WITHIN EACH ARRAY, SPACING BETWEEN RUMBLE STRIPS SHALL BE 15 FEET ON CENTER.



SIGN AND TEMPORARY RUMBLE STRIP ARRAY SPACING TABLE

SPEED LIMIT	SPACING "A"
25-30 MPH	200'
35-40 MPH	350'
45-55 MPH	500'

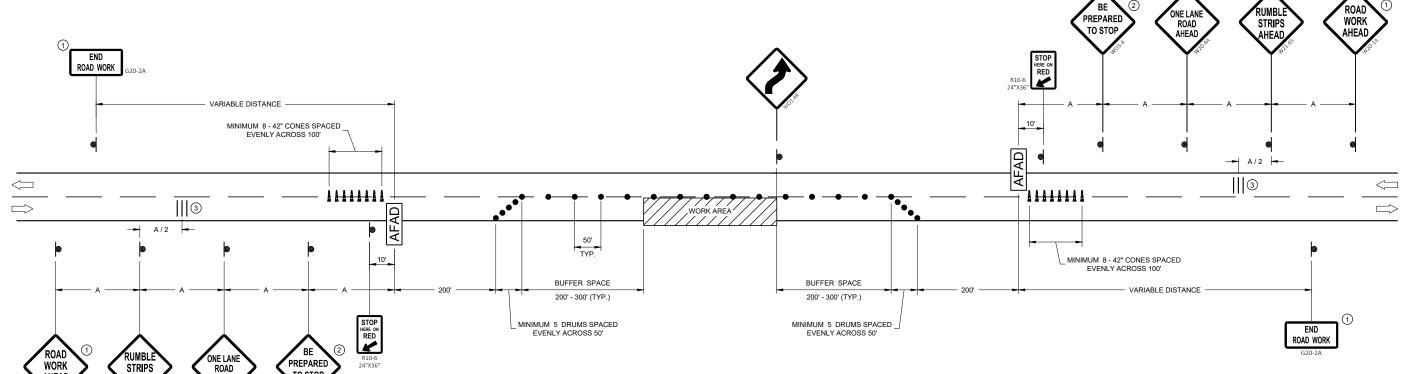


TRAFFIC CONTROL, LANE CLOSURE WITH AUTOMATED FLAGGER ASSISTANCE DEVICE


Ŏ


Ŋ

STATE OF WISCONSIN
DEPARTMENT OF TRANSPORTATION

AFFROVED	
May 2022	/S/ Andrew Heidtke
DATE	WORK ZONE ENGINEER

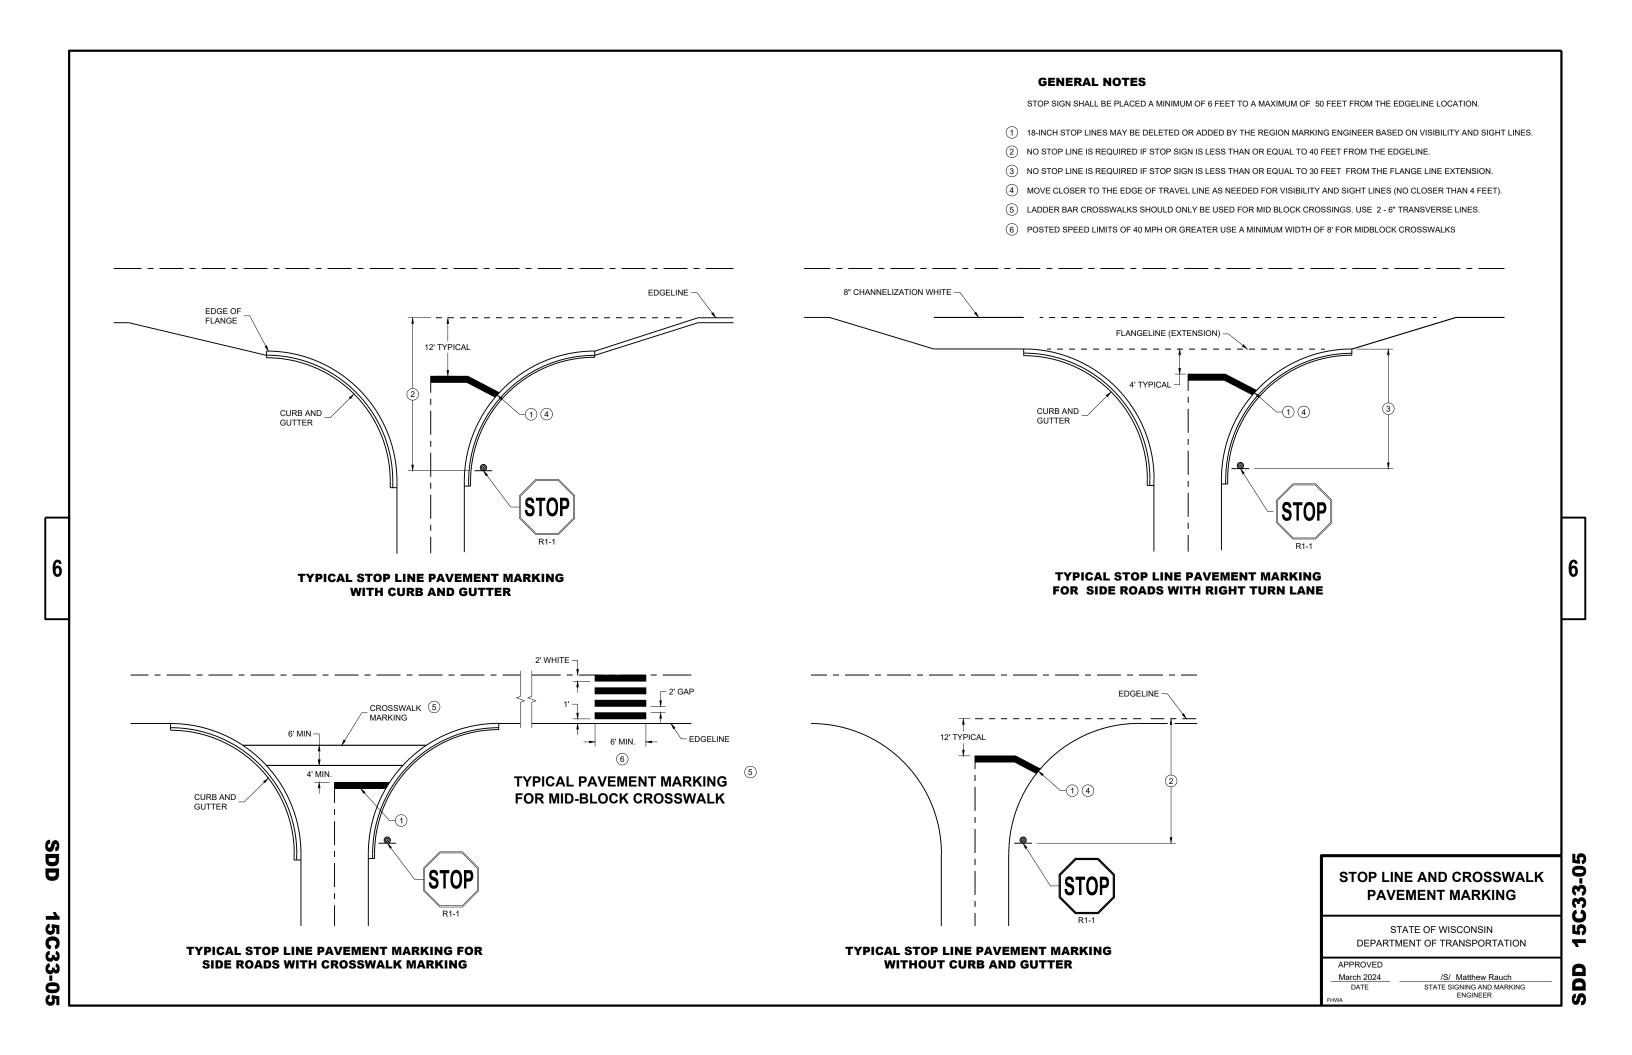


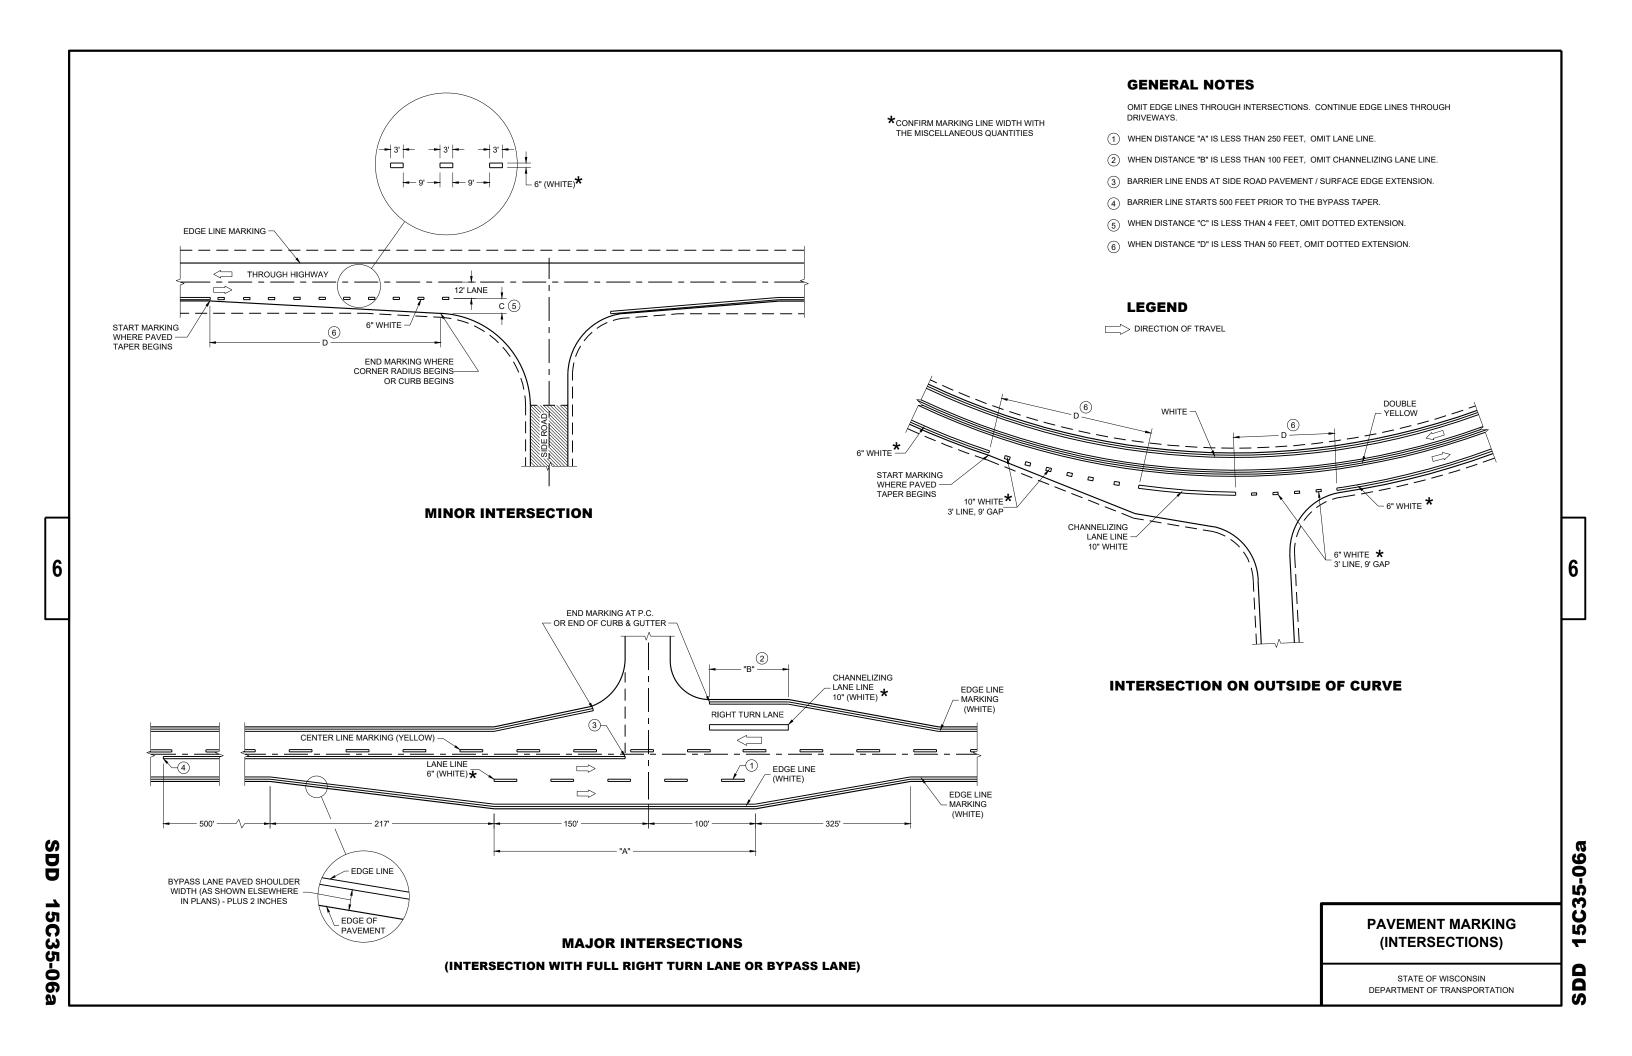

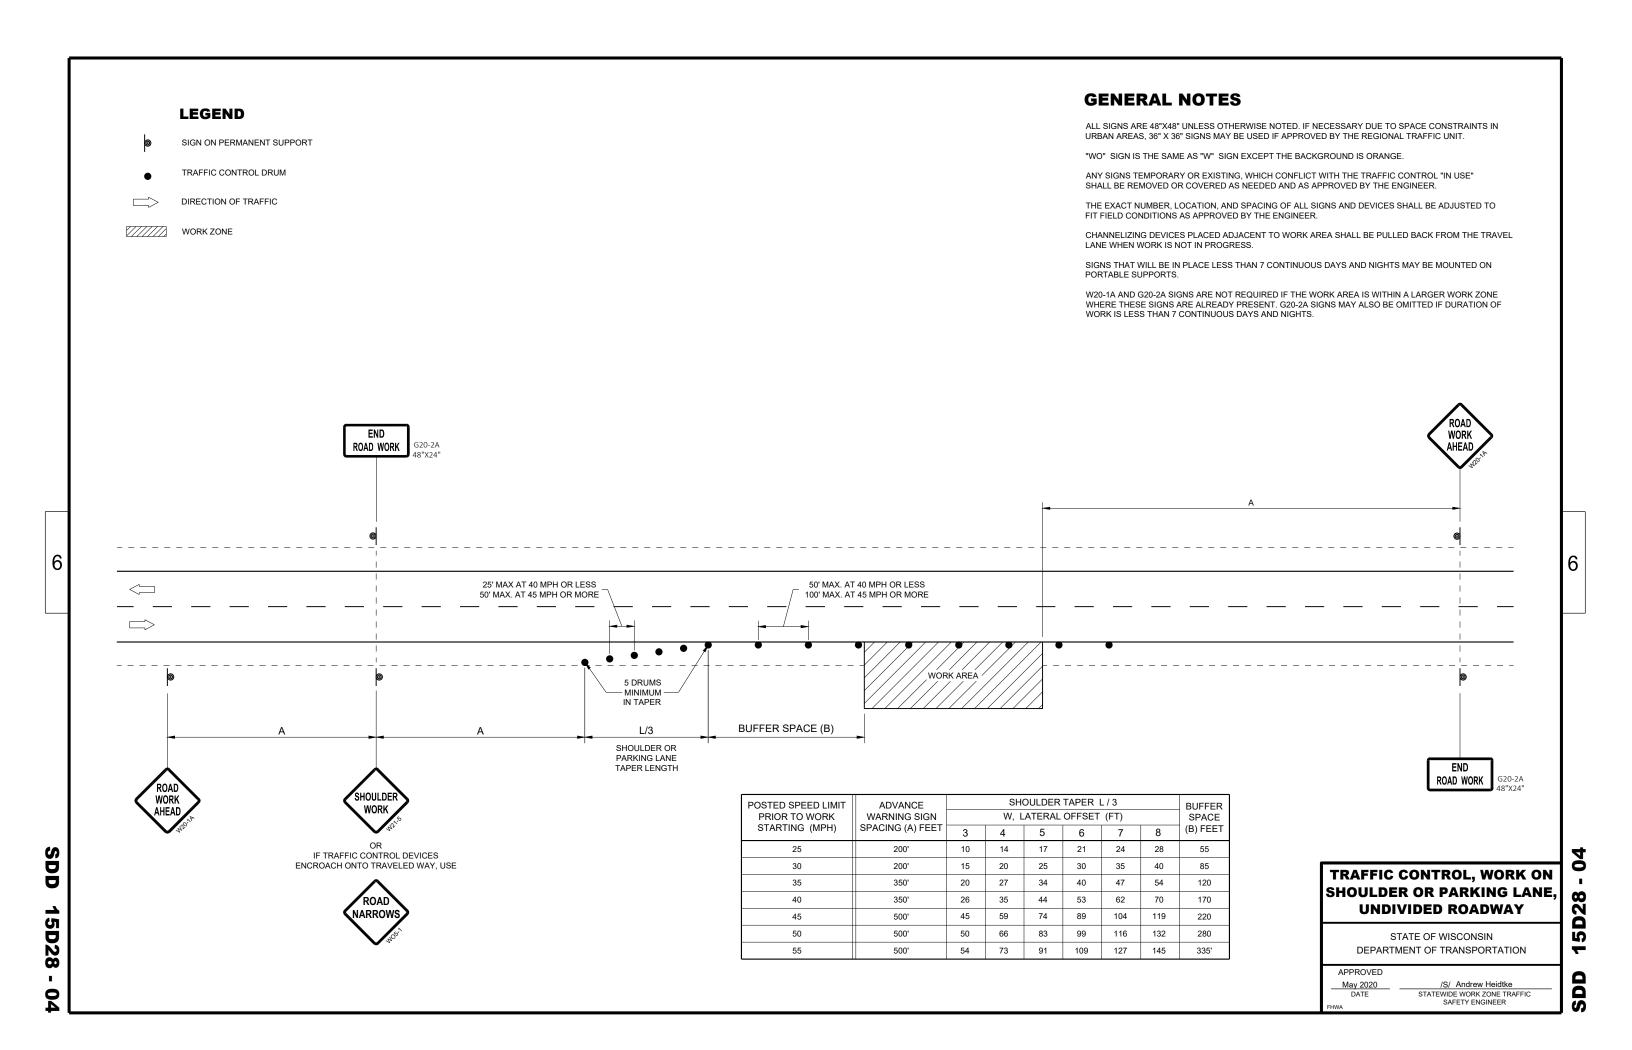

BARRICADE DEVICE SELECTED FROM APPROVED PRODUCT LIST

- 1 REFLECTIVE SHEETING SHALL FOLLOW THE REQUIREMENTS IN THE APPROVED PRODUCTS LISTING FOR SIGN SHEETING.
- $\ensuremath{\textcircled{2}}$ Sheeting required on more than 50% of barricade width.
- (3) PLACE SHEETING ON BOTH SIDES OF THE BARRICADE.

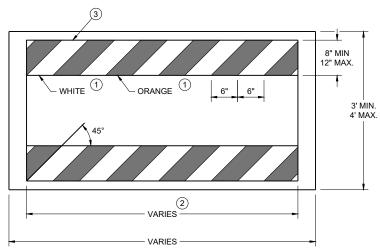

THE TOP OF THE BARRICADE IS TO BE A SMOOTH CONTINUOUS SURFACE FREE OF SHARP OR ROUGH EDGES INSTALL PEDESTRIAN PLACE CONCRETE BARRIER TEMPORARY PRECAST IF TEMPORARY PEDESTRIAN BARRICADE PER 4' MINIMUM 5' DESIRABLE MANUFACTURERS RECOMMENDATIONS INSTALL PEDESTRIAN ACCESS IS ADJACENT TO AN BARRICADE PER ACTIVE WORK ZONE OR LIVE PEDESTRIAN BARRICADE MANUFACTURERS RECOMMENDATIONS TRAFFIC LANE TEMPORARY PEDESTRIAN SURFACE 2" MAX. 2% MAX. SLOPE 4 4-INCH BASE AGGREGATE 4-INCH BASE AGGREGATE DENSE 1 1/4-INCH DENSE 1 1/4-INCH **TEMPORARY PEDESTRIAN ACCESS**

NARROW SIDEWALK PASSING DETAIL

JOINT ALLOWANCES

200' MAX SPACING FROM

LAST PASSING LANE

MAXIMUM HORIZONTAL GAP

200' MAX SPACING FROM

LAST PASSING LANE

- LEADING EDGE

½" MAXIMUM

- 1/4" MAXIMUM

MAXIMUM VERTICAL GAP

TRAFFIC CONTROL, **PEDESTRIAN ACCOMMODATION**

15D30-10a

SD

STATE OF WISCONSIN DEPARTMENT OF TRANSPORTATION

SDD 15D30-10a

PERSPECTIVE VIEW

GENERAL NOTES


CURB RAMPS SHALL BE 48" MIN. WIDTH WITH A FIRM, STABLE AND SLIP RESISTANT SURFACE.

CURB RAMPS AND LANDINGS SHALL HAVE A 1:50 (2%) MAX. CROSS-SLOPE.

CLEAR SPACE OF 48" X 48" SHALL BE PROVIDED ABOVE AND BELOW THE CURB RAMP. LATERAL JOINTS OR GAPS BETWEEN SURFACES SHALL BE LESS THAN ½" WIDTH.

CHANGES BETWEEN SURFACE HEIGHTS SHALL NOT EXCEED $\frac{1}{2}$ ". LATERAL EDGES MAY BE VERTICAL UP TO $\frac{1}{4}$ " HIGH AND SHALL BE BEVELED AT 1:2 BETWEEN $\frac{1}{4}$ " AND $\frac{1}{2}$ ".

- (1) INSTALL CONTRASTING TEMPORARY DETECTABLE WARNING FIELD AT PEDESTRIAN STREET CROSSINGS, AS SHOWN IN THE PLANS.
- (2) PROTECTIVE EDGING WITH A 2" MIN. HEIGHT SHALL BE INSTALLED WHEN A CURB RAMP OR LANDING PLATFORM HAS A VERTICAL DROP OF 6" OR GREATER OR HAS A SIDE APRON SLOPE STEEPER THAN 1:3 (33%). PROTECTIVE EDGING SHOULD BE CONSIDERED WHEN CURB RAMPS OR LANDING PLATFORMS HAVE A VERTICAL DROP OF 3" OR MORE.
- (3) DETECTABLE EDGING WITH 6" MIN. HEIGHT AND CONTRASTING COLOR SHALL BE INSTALLED ON ALL CURB RAMP LANDINGS WHERE THE WALKWAY CHANGES DIRECTION (TURNS).
- (4) DO NOT RESTRICT WATER FLOW IN THE GUTTER SYSTEM.
- (5) ENSURE CURB RAMP IS OUT OF THE GUTTER PAN.
- (6) IF ONLY PART OF THE END PANEL OF TEMPORARY PEDESTRIAN BARRICADE PANEL IS NEEDED, EXTEND EXCESS PORTION OF TEMPORARY PEDESTRIAN BARRICADE PANEL HERE.

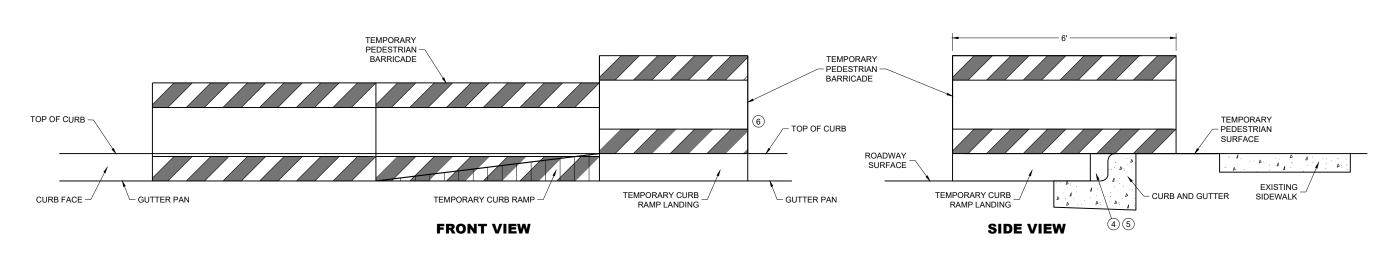

TEMPORARY CURB RAMP PARALLEL TO CURB

TRAFFIC CONTROL,
PEDESTRIAN
ACCOMMODATION

STATE OF WISCONSIN DEPARTMENT OF TRANSPORTATION

6

U

SDD

15D30-10b

SDD 15D30-10b

TEMPORARY CURB RAMP PERPENDICULAR TO CURB

WITH PROTECTIVE EDGE

GENERAL NOTES

CURB RAMPS SHALL BE 48" MINIMUM WIDTH WITH A FIRM, STABLE AND SLIP RESISTANT SURFACE.

ALTERNATE SIDEWALK WORK BETWEEN LEFT AND RIGHT SIDE OF ROADWAY TO MAINTAIN PEDESTRIAN ACCESS.

CURB RAMPS AND LANDINGS SHALL HAVE A 1:50 (2%) MAX. CROSS-SLOPE.

CLEAR SPACE OF 48" X 48" SHALL BE PROVIDED ABOVE AND BELOW THE CURB RAMP.

LATERAL JOINTS OR GAPS BETWEEN SURFACES SHALL BE LESS THAN ½" WIDTH.

CHANGES BETWEEN SURFACE HEIGHTS SHALL NOT EXCEED $\frac{1}{2}$ ". LATERAL EDGES MAY BE VERTICAL UP TO $\frac{1}{4}$ " HIGH AND SHALL BE BEVELED AT 1:2 BETWEEN $\frac{1}{4}$ " AND $\frac{1}{2}$ ".

- (1) INSTALL CONTRASTING TEMPORARY DETECTABLE WARNING FIELD AT PEDESTRIAN STREET CROSSINGS, AS SHOWN IN THE DI ANS
- (2) PROTECTIVE EDGING WITH A 2" MIN. HEIGHT SHALL BE INSTALLED WHEN A CURB RAMP OR LANDING PLATFORM HAS A VERTICAL DROP OF 6" OR GREATER OR HAS A SIDE APRON SLOPE STEEPER THAN 1:3 (33%). PROTECTIVE EDGING SHOULD BE CONSIDERED WHEN CURB RAMPS OR LANDING PLATFORMS HAVE A VERTICAL DROP OF 3" OR MORE.
- (3) DETECTABLE EDGING WITH 6" MIN. HEIGHT AND CONTRASTING COLOR SHALL BE INSTALLED ON ALL CURB RAMP LANDINGS WHERE THE WALKWAY CHANGES DIRECTION (TURNS).
- (4) DO NOT RESTRICT WATER FLOW IN THE GUTTER SYSTEM.
- (5) CAN ONLY BE USED FOR RAMPS WITH 6" OR LESS OF VERTICAL CHANGE.


6


15D30-10c

STATE OF WISCONSIN
DEPARTMENT OF TRANSPORTATION

SDD 15D30-10c

TRAFFIC CONTROL,
PEDESTRIAN ACCOMMODATION

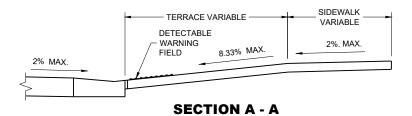

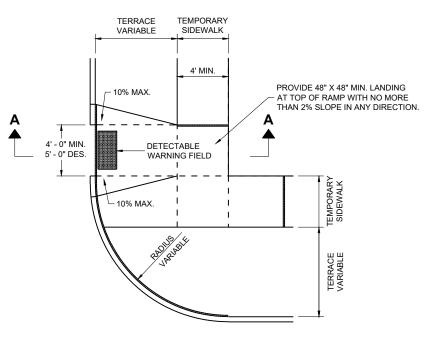

PLAN VIEW TEMPORARY TYPE 3 RAMP

(OUTSIDE OF CROSSWALK AREA)

TRAFFIC CONTROL, PEDESTRIAN ACCOMMODATION

> STATE OF WISCONSIN DEPARTMENT OF TRANSPORTATION

May 2023 DATE /S/ Andrew Heidtke

<position>

6

SDD 15D30-10d

15D30-10d SDD WORK AREA

10' (MIN.)

3

0

WORK AREA

PROFILE
VIEW
TEMPORARY BUS STOP PAD

GENERAL NOTES

TYPICAL TEMPORARY PEDESTRIAN BARRICADE PANEL IS 6 FEET LONG.

NOTIFY THE BUS COMPANY 7 DAYS IN ADVANCE OF THE BUS STOP RELOCATION.

PROTECTIVE EDGING WITH A 2" MIN. HEIGHT SHALL BE INSTALLED WHEN A CURB RAMP OR LANDING PLATFORM HAS A VERTICAL DROP OF 6" OR GREATER OR HAS A SIDE APRON SLOPE STEEPER THAN 1:3 (33%). PROTECTIVE EDGING SHOULD BE CONSIDERED WHEN CURB RAMPS OR LANDING PLATFORMS HAVE A VERTICAL DROP OF 3" OR MORE.

DETECTABLE EDGING WITH 6" MIN. HEIGHT AND CONTRASTING COLOR SHALL BE INSTALLED ON ALL CURB RAMP LANDINGS WHERE THE WALKWAY CHANGES DIRECTION (TURNS).

LATERAL JOINTS OR GAPS BETWEEN SURFACES SHALL BE LESS THAN ½" WIDTH.

CHANGES BETWEEN SURFACE HEIGHTS SHALL NOT EXCEED $\frac{1}{2}$ ". LATERAL EDGES MAY BE VERTICAL UP TO $\frac{1}{4}$ " HIGH AND SHALL BE BEVELED AT 1:2 BETWEEN $\frac{1}{4}$ " AND $\frac{1}{2}$ ".

CURB RAMPS AND LANDINGS SHALL HAVE A 1:50 (2%) MAX. CROSS-SLOPE.

- (1) DO NOT RESTRICT WATER FLOW IN THE GUTTER SYSTEM.
- (2) 5' WIDE MIN. WITH TEMPORARY PEDESTRIAN BARRICADE, 10' WIDE MIN. WITHOUT TEMPORARY PEDESTRIAN BARRICADE.
- (3) PLACE EXCESS PORTION OF TEMPORARY PEDESTRIAN BARRICADE INTO THIS SPACE.

LEGEND

) T

TRAFFIC CONTROL DRUM



TYPE III BARRICADE

TEMPORARY PEDESTRIAN BARRICADE



TEMPORARY DETECTABLE WARNING FIELD



WORK AREA




TEMPORARY AUDIBLE MESSAGE DEVICE (EXACT PLACEMENT BASED UPON FIELD CONDITIONS)

TRAFFIC CONTROL,
PEDESTRIAN ACCOMMODATION

STATE OF WISCONSIN DEPARTMENT OF TRANSPORTATION

SDD 15D30-10e

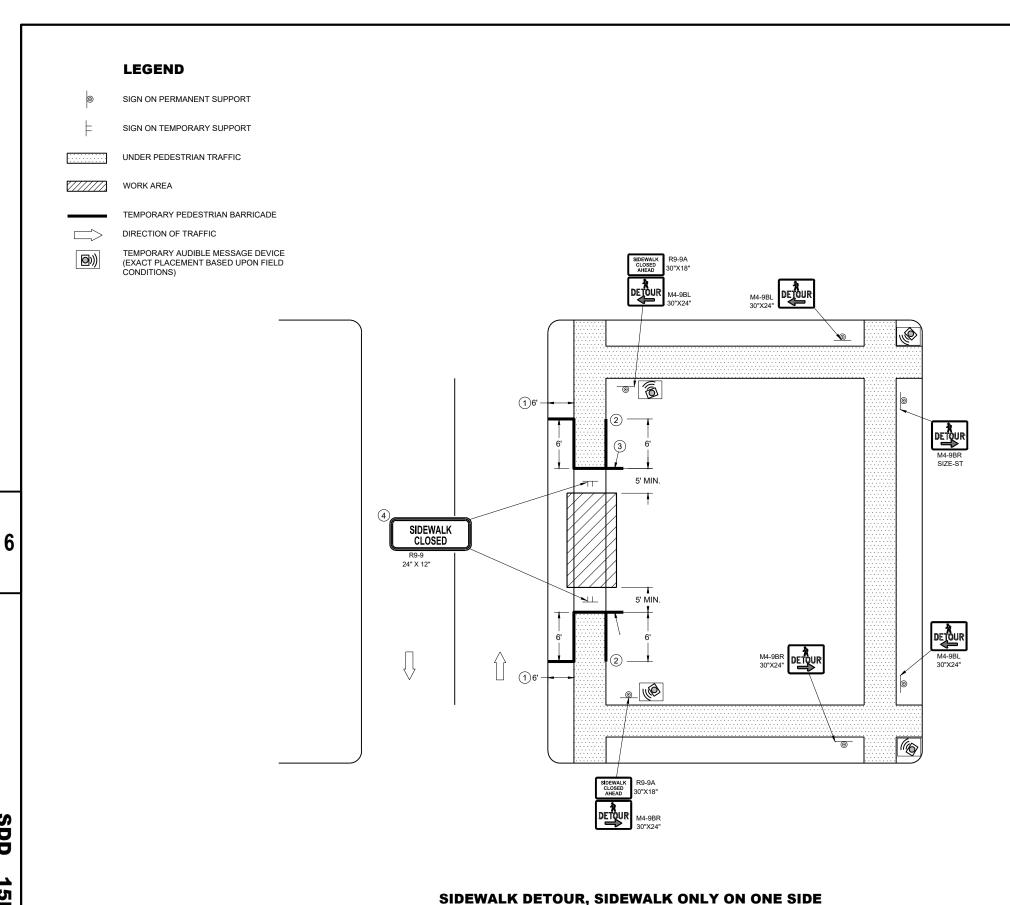

GENERAL NOTES

WHERE TEMPORARY BARRICADE RUNS PARALLEL ALONG SIDEWALK, PLACE THE FACE OF THE BARRICADE AT THE EDGE OF THE SIDEWALK.

SIGNS THAT REMAIN IN PLACE LESS THAN SEVEN CONTINUOUS DAYS AND NIGHTS MAY BE MOUNTED ON PORTABLE SUPPORTS.

PLACE TEMPORARY PEDESTRIAN BARRICADE TO FIT FIELD CONDITIONS, AVOIDING CONFLICTS WITH DRIVEWAYS AND OTHER EXISTING FEATURES.

- $\scriptsize \textcircled{1}$ IF TERRACE IS LESS THAN 6 FEET WIDE, OMIT TEMPORARY PEDESTRIAN BARRICADE FROM THE SIDEWALK TO THE CURB.
- PLACE BARRICADE CLOSURE SO THAT THE TEMPORARY PEDESTRIAN BARRICADE END IS AT 2) THE LAST OPEN SIDEWALK ACCESS TO RESIDENCES OR BUSINESSES BEFORE THE SIDEWALK CLOSURE.
- ③ IF TEMPORARY PEDESTRIAN BARRICADE PANEL IS WIDER THAN THE SIDEWALK WIDTH, THE PORTION OF EXCESS PANEL SHOULD EXTEND INTO THE TERRACE.
- (4) MOUNTING HEIGHT OF 5 FEET FROM THE SURFACE TO THE BOTTOM OF SIGN.

SDD

15D30-10f

TRAFFIC CONTROL, PEDESTRIAN ACCOMMODATION

> STATE OF WISCONSIN DEPARTMENT OF TRANSPORTATION

5D30-10f

S

SIDEWALK BYPASS SINGLE SIDE

GENERAL NOTES

TYPICAL TEMPORARY PEDESTRIAN BARRICADE PANEL IS 6 FEET LONG.

WHERE TEMPORARY BARRICADE RUNS PARALLEL ALONG SIDEWALK, PLACE THE FACE OF THE BARRICADE AT THE EDGE OF THE SIDEWALK.

SIGNS THAT REMAIN IN PLACE LESS THAN SEVEN CONTINUOUS DAYS AND NIGHTS MAY BE MOUNTED ON PORTABLE SUPPORTS.

- ① USE TEMPORARY PEDESTRIAN BARRICADE TO SEPARATE PEDESTRIANS FROM DROP OFFS OR FOR ADDITIONAL PEDESTRIAN CHANNELIZATION.
- (3) MOUNTING HEIGHT OF 5 FEET FROM THE SURFACE TO THE BOTTOM OF SIGN.

6

15D30-10g

S

TRAFFIC CONTROL, PEDESTRIAN ACCOMMODATION

STATE OF WISCONSIN
DEPARTMENT OF TRANSPORTATION

SDD 15D30-10g

DD 15D30-10h

S

GENERAL NOTES


TYPICAL TEMPORARY PEDESTRIAN BARRICADE PANEL IS 6 FEET LONG.

WHERE TEMPORARY BARRICADE RUNS PARALLEL ALONG SIDEWALK, PLACE THE FACE OF THE BARRICADE AT THE EDGE OF THE SIDEWALK.

- 1) SHOULDER OR LANE CLOSURE ADVANCE WARNING AND BUFFER SPACE REQUIRED.
- $\ensuremath{\textcircled{2}}$ PLACE EXCESS PORTION OF TEMPORARY PEDESTRIAN BARRICADE PANEL PAST THE SIDEWALK ON THE SIDE AWAY FROM THE ROAD.
- 3 MOUNTING HEIGHT OF 5 FEET FROM THE SURFACE TO THE BOTTOM OF SIGN.

USE EXISTING PAVEMENT SURFACE. IF EXISTING PAVEMENT SURFACE HAS BEEN REMOVED,

USE A TEMPORARY PEDESTRIAN SURFACE. WHEN THE TEMPORARY PEDESTRIAN ACCESS
ROUTE RUNS PARALLEL ON THE ROADWAY SURFACE, THE MAXIMUM CROSS SLOPE WILL MATCH
THE EXISTING ROADWAY CROSS SLOPE.

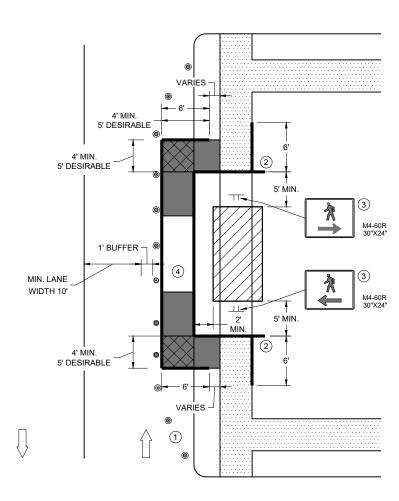

SIDEWALK BYPASS, SINGLE SIDE

TRAFFIC CONTROL, PEDESTRIAN ACCOMMODATION

STATE OF WISCONSIN
DEPARTMENT OF TRANSPORTATION

CURB RAMP PEDESTRIAN TRAFFIC CONTROL

SIDEWALK ON SINGLE SIDE

Ŏ

15D30-1

0


S

STATE OF WISCONSIN
DEPARTMENT OF TRANSPORTATION

TRAFFIC CONTROL,

PEDESTRIAN ACCOMMODATION

S

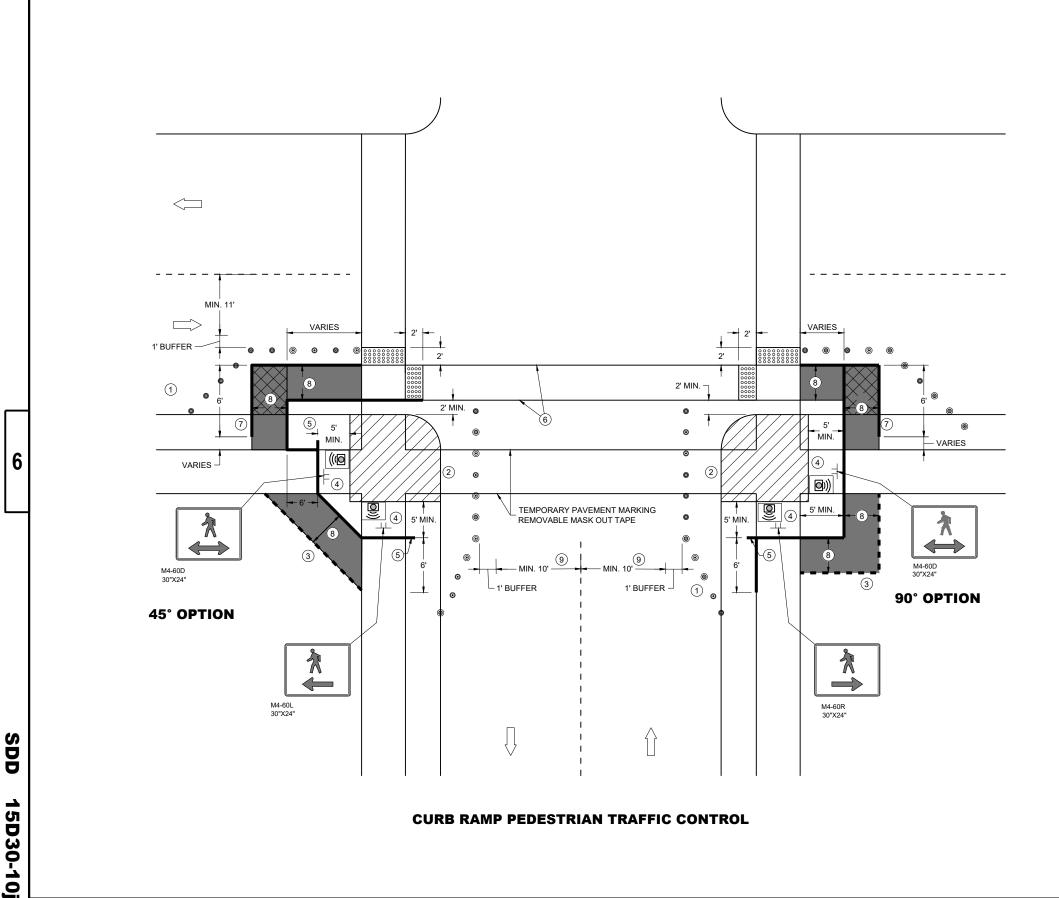

GENERAL NOTES

IF PEDESTRIAN PUSH BUTTONS ARE PRESENT ON THE EXISTING FACILITY, ENSURE THEY ARE MAINTAINED/ACCESSIBLE FOR PEDESTRIAN USE THROUGHOUT THE TEMPORARY PEDESTRIAN ACCOMMODATIONS.

TYPICAL TEMPORARY PEDESTRIAN BARRICADE PANEL IS 6 FEET LONG

WHEN TEMPORARY PEDESTRIAN BARRICADE RUNS PARALLEL ALONG THE SIDEWALK, PLACE THE FACE OF THE BARRICADE AT THE EDGE OF THE SIDEWALK.

WHEN THE TEMPORARY PEDESTRIAN ACCESS ROUTE RUNS PARALLEL ON THE ROADWAY SURFACE, THE MAXIMUM CROSS SLOPE WILL MATCH THE EXISTING ROADWAY CROSS SLOPE

- ① SHOULDER OR LANE CLOSURE ADVANCE WARNING AND PROPER BUFFER SPACE REQUIRED.
- (2) PROVIDE ADEQUATE SPACE FOR CONTRACTOR OPERATIONS
- $\ensuremath{\mathfrak{J}}$ USE TEMPORARY PEDESTRIAN BARRICADE TO SEPARATE PEDESTRIANS FROM DROP OFFS OR FOR ADDITIONAL PEDESTRIAN CHANNELIZATION.
- $\stackrel{\textstyle \leftarrow}{4}$ MOUNTING HEIGHT OF 5 FEET FROM SIDEWALK SURFACE TO BOTTOM OF SIGN.
- $\ensuremath{\mathfrak{D}}$ PLACE EXCESS PORTION OF TEMPORARY PEDESTRIAN BARRICADE PANEL IN THE SIDEWALK TERRACE.
- 6 WHITE 6" TEMPORARY PAVEMENT MARKING
- IF TEMPORARY PEDESTRIAN BARRICADE DOES NOT REACH THE FACE OF THE CURB, USE AN ADDITIONAL PANEL AND EXTEND INTO THE TERRACE.
- 8 4 FEET MINIMUM, 5 FEET DESIRABLE
- IF MINIMUM LANE WIDTHS CAN'T BE ATTAINED, CURB RAMPS MAY NEED TO BE CONSTRUCTED AT SEPARATE TIMES.

LEGEND

SIGN ON TEMPORARY SUPPORT

TRAFFIC CONTROL DRUM

WORK AREA

TEMPORARY CURB RAMP

TEMPORARY PEDESTRIAN SURFACE "A" TEMPORARY PEDESTRIAN SURFACE "B"

TEMPORARY DETECTABLE WARNING FIELD

TEMPORARY PEDESTRIAN BARRICADE OPTIONAL TEMPORARY PEDESTRIAN BARRICADE

DIRECTION OF TRAFFIC

TEMPORARY AUDIBLE MESSAGE DEVICE (EXACT PLACEMENT BASED UPON FIELD CONDITIONS)

> TRAFFIC CONTROL, PEDESTRIAN ACCOMMODATION

> > STATE OF WISCONSIN DEPARTMENT OF TRANSPORTATION

9

SIGN ON PERMANENT SUPPORT

1

SIGN ON TEMPORARY SUPPORT
UNDER PEDESTRIAN TRAFFIC

DIRECTION OF TRAFFIC

//////

WORK AREA

 $\overline{}$

TEMPORARY PEDESTRIAN BARRICADE

TEMPORARY AUDIBLE MESSAGE DEVICE (EXACT PLACEMENT BASED UPON FIELD CONDITIONS)

(1)6' SIDEWALK 24" X 12" 1)6'

SIDEWALK DETOUR, SIDEWALK ON BOTH SIDES

GENERAL NOTES

WHERE TEMPORARY BARRICADE RUNS PARALLEL ALONG SIDEWALK, PLACE THE FACE OF THE BARRICADE AT THE EDGE OF THE SIDEWALK.

SIGNS THAT REMAIN IN PLACE LESS THAN SEVEN CONTINUOUS DAYS AND NIGHTS MAY BE MOUNTED ON PORTABLE SUPPORTS.

PLACE TEMPORARY PEDESTRIAN BARRICADE TO FIT FIELD CONDITIONS, AVOIDING CONFLICT WITH DRIVEWAYS AND OTHER EXISTING FEATURES.

- 1 IF TERRACE IS LESS THAN 6 FEET WIDE, OMIT TEMPORARY PEDESTRIAN BARRICADE FROM THE SIDEWALK TO THE CURB.
- PLACE BARRICADE CLOSURE SO THAT THE TEMPORARY PEDESTRIAN BARRICADE END IS AT THE LAST OPEN SIDEWALK ACCESS TO RESIDENCES OR BUSINESSES BEFORE THE SIDEWALK CLOSURE.
- $\ \, \ \,$ IF TEMPORARY PEDESTRIAN BARRICADE PANEL IS WIDER THAN THE SIDEWALK WIDTH, THE PORTION OF EXCESS PANEL SHOULD EXTEND INTO THE TERRACE.
- 4 MOUNTING HEIGHT OF 5 FEET FROM THE SURFACE TO THE BOTTOM OF SIGN.

6

15D30-10k

S

TRAFFIC CONTROL, PEDESTRIAN ACCOMMODATION

STATE OF WISCONSIN
DEPARTMENT OF TRANSPORTATION

SDD 15D30-10k

6

GENERAL NOTES

TYPICAL TEMPORARY PEDESTRIAN BARRICADE PANEL IS 6 FEET LONG. SEE OTHER PEDESTRIAN ACCOMMODATION DETAILS FOR SIGNING AND DEVICES FOR DIFFERENT PEDESTRIAN FACILITIES CLOSURES.

WHEN THE TEMPORARY PEDESTRIAN ACCESS ROUTE RUNS PARALLEL ON THE ROADWAY SURFACE, THE MAXIMUM CROSS SLOPE WILL MATCH THE EXISTING ROADWAY CROSS SLOPE.

- 1 SHOULDER OR LANE CLOSURE ADVANCED WARNING AND PROPER BUFFER SPACE REQUIRED.
- 2) 4 FEET MINIMUM, 5 FEET DESIRABLE.
- 3 WHITE 6" TEMPORARY PAVEMENT MARKING.
- 4 IF MINIMUM LANE WIDTHS CAN'T BE ATTAINED, PERPENDICULAR CURB RAMPS MAY NEED TO BE UTILIZED.
- IF MINIMUM 100' SPACING FROM THE MID-BLOCK CROSSING CANNOT BE ATTAINED BEFORE THE INTERSECTION, REMOVE THIS SIGN ASSEMBLY.
- (6) IF TERRACE IS LESS THAN 6 FEET WIDE, OMIT TEMPORARY PEDESTRIAN BARRICADE FROM THE SIDEWALK TO THE CURB.
- PLACE BARRICADE CLOSURE SO THAT THE TEMPORARY PEDESTRIAN BARRICADE END IS AT THE LAST OPEN SIDEWALK ACCESS TO RESIDENCES OR BUSINESSES BEFORE THE SIDEWALK CLOSURE.
- IF TEMPORARY PEDESTRIAN BARRICADE PANEL IS WIDER THAN THE SIDEWALK WIDTH, THE PORTION OF THE EXCESS PANEL SHOULD EXTEND INTO THE TERRACE.
- (9) MOUNTING HEIGHT OF 5 FEET FROM THE SURFACE TO THE BOTTOM OF THE SIGN.

LEGEND

TRAFFIC CONTROL DRUM

SIGN ON TEMPORARY SUPPORT

TEMPORARY CURB RAMP

TEMPORARY DETECTABLE WARNING FIELD

TEMPORARY PEDESTRIAN SURFACE "A"

TEMPORARY PEDESTRIAN SURFACE "B"

DIRECTION OF TRAFFIC

TEMPORARY AUDIBLE MESSAGE DEVICE (EXACT PLACEMENT BASED UPON FIELD CONDITIONS)

TRAFFIC CONTROL, PEDESTRIAN ACCOMMODATION


> STATE OF WISCONSIN DEPARTMENT OF TRANSPORTATION

TEMPORARY PEDESTRIAN BARRICADE

SDD 15D30-1

9

30-101

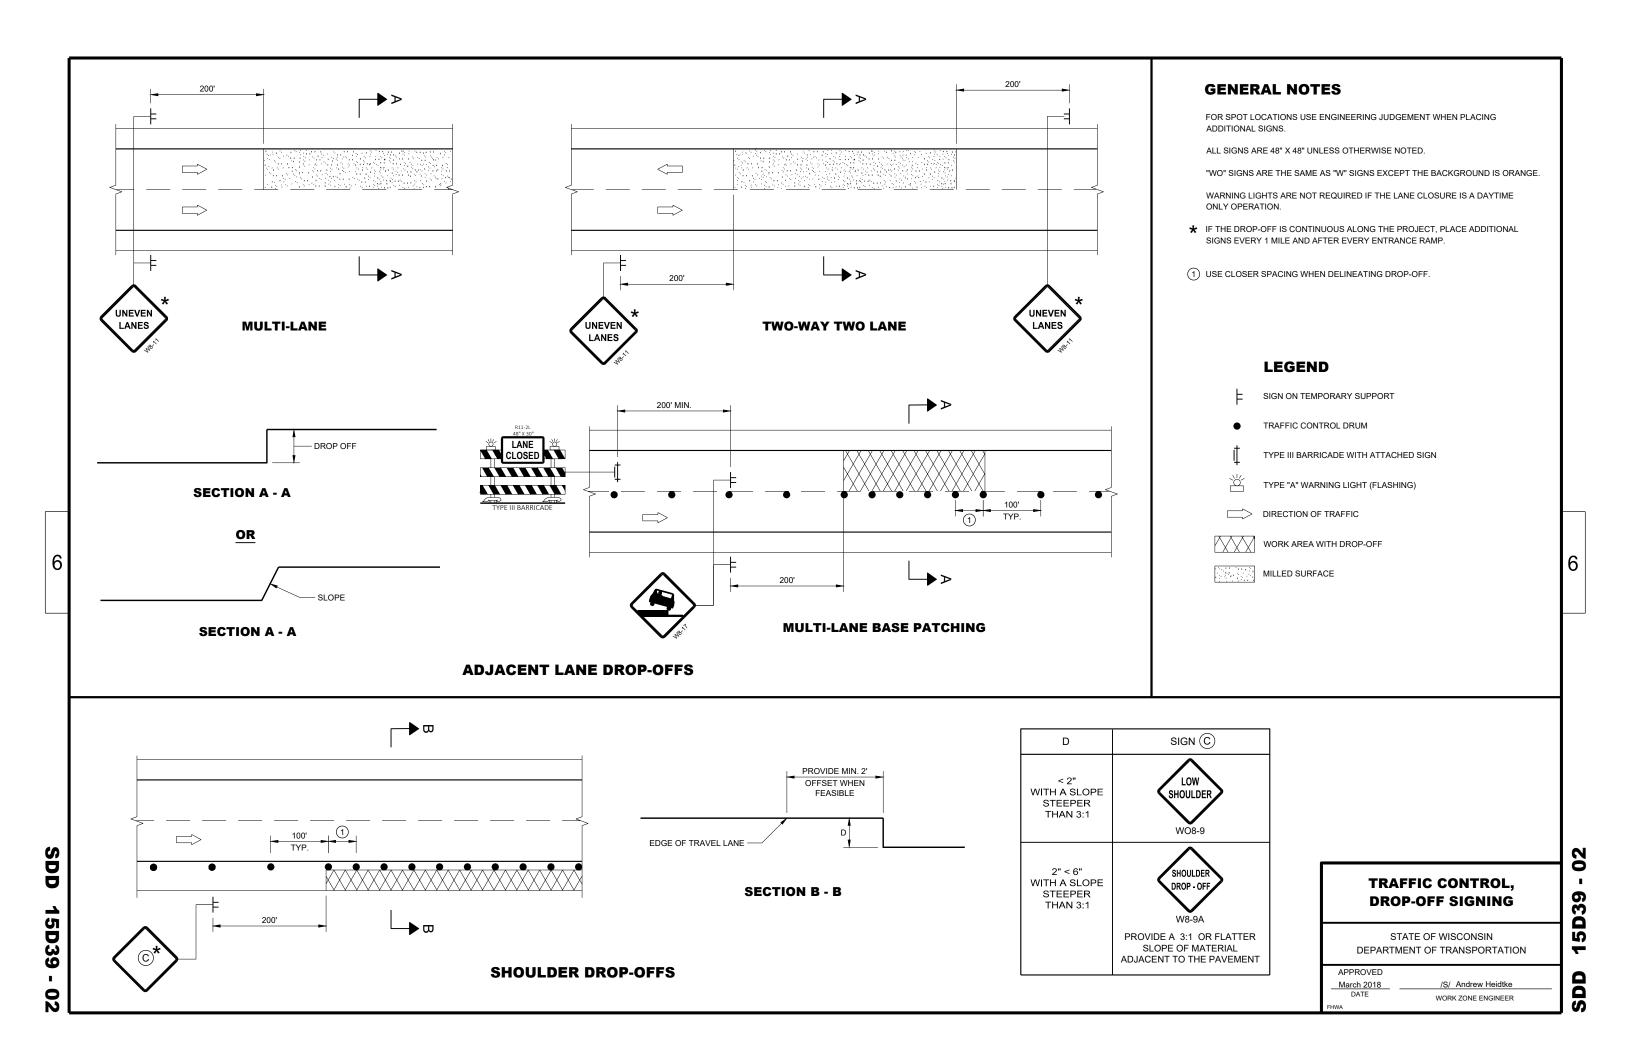

45

50

V1 WORK VEHICLE

V2 SHADOW VEHICLE

TRUCK MOUNTED ATTENUATOR (TMA)

FLASHING ARROW PANEL (CAUTION)

WORK AREA

DIRECTION OF TRAFFIC

GENERAL NOTES

ALL SIGNS ARE 48"X48" UNLESS OTHERWISE NOTED.

MOBILE IS WORK THAT MOVES CONTINUOUSLY OR MOVES AT LEAST THE DECISION


ALL VEHICLES SHALL BE EQUIPPED WITH TWO 360 DEGREE HIGH INTENSITY YELLOW FLASHING LIGHTS OR STROBE LIGHTS AND OPERATED WITH HEADLIGHTS TURNED ON.

ALL ARROW PANELS SHALL BE REAR FACING, TYPE "B" OR "C", AND DISPLAYING THE FLASHING CAUTION MODE. SIGNS PLACED ON VEHICLES MUST NOT OBSCURE THE

USE AN ATTENUATOR ON THE REARMOST VEHICLE THAT BLOCKS ALL OR PART OF

DISTANCE BETWEEN VEHICLES MAY INCREASE FROM THE ATTENUATOR'S ROLL AHEAD BASED ON TERRAIN, SIGHT DISTANCE, AND OTHER FACTORS. WHENEVER ADEQUATE STOPPING SIGHT DISTANCE EXISTS TO THE REAR, SHADOW VEHICLES SHOULD MAINTAIN THE MINIMUM DISTANCE FROM THE WORK VEHICLE AND PROCEED AT THE SAME SPEED AS THE WORK VEHICLE. SHADOW VEHICLES SHOULD SLOW DOWN IN ADVANCE OF VERTICAL OR HORIZONTAL CURVES THAT RESTRICT SIGHT DISTANCE.

2) ALIGN LEFT SIDE OF SHADOW VEHICLE WITH EDGE OF WORK AREA.

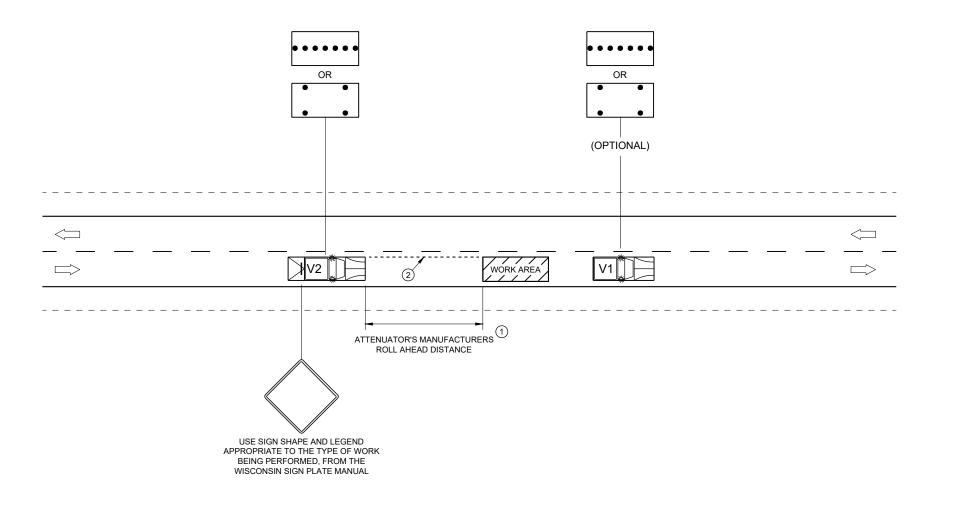

POSTED SPEED PRIOR TO DECISION SIGHT

DISTANCE (D)

550'

700'

700'

900'

900'

1200'

WORK STARTING (MPH)

30

35

40

45

50

55

TRAFFIC CONTROL, **MOBILE OPERATIONS ON AN UNDIVIDED ROADWAY**

STATE OF WISCONSIN DEPARTMENT OF TRANSPORTATION

APPROVED


February 2021 DATE


/S/ Andrew Heidtke
STATEWIDE WORK ZONE TRAFFIC
SAFETY ENGINEER


D

IJ

TYPICAL ASSEMBLIES

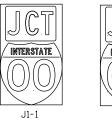

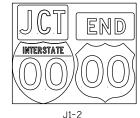

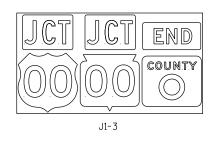



MISTIC

ROAD

JR99-1





(Typical Vertical J-Assembly See Note 10 and 11)







INTERSTATE

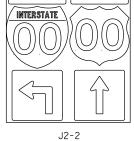

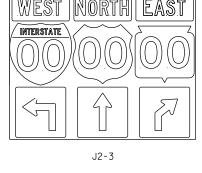


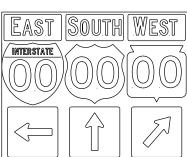

J3-3

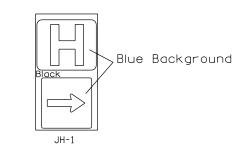



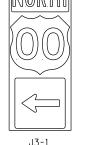




J4-1


COUNTY


J13-1

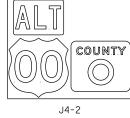



J3-2



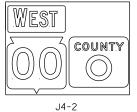

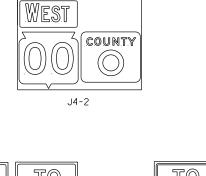

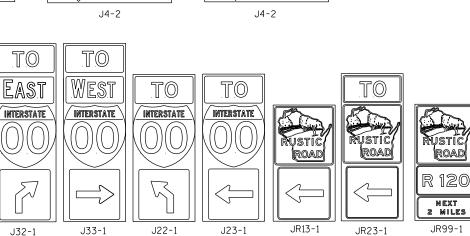

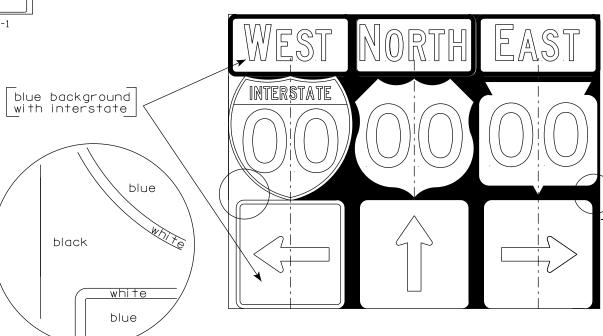

NOTES

1. Signs are Type II - Type H Reflective

2. Color:

Background - Black Non-reflective Message - see Note 4

- 3. Message Series See Note 4
- 4. The colors and message spacing on each marker shall be according to the applicable route marker panel specifications.
- 5. Certain marker heads require the component pieces to be the same color. As an example, all the components used with an M1-1 Interstate marker shall be blue.
- 6. Single panel j-assemblies shall only be used with route marker shields that are same size. If the route marker shields are different size use multiple piece component.
- 7. Route assemblies that have 24 inch route shields and have dimensions greater than 48 inches (both vertical and horizontal) shall have one horizontal splice between the arrows and route shields. Vertical splices shall not be used on route assemblies with a horizontal dimension of 144 inches or less. The contractor shall not use more than one vertical joint per sign and the joint shall be between route shields.
- 8. Route assemblies that have 36 inch shields and have dimensions greater than 48 inchs (both vertical and horizontal) shall have two horizontal splices. One horizontal splice shall be between the cardinal direction and route shields and the other horizontal splice shall be between the arrows and route shields. Vertical splices shall not be used on route assemblies with a horizontal dimension of 144 or less. The contractor shall not use more than one vertical joint per sign and the joint shall be between route shields.
- 9. All Vertical J Assemblies are given a Sign Code of JV
- 10. For JV Assemblies that have a mixture of Interstate and Non-Interstate shields, arrows and cardinals shall be white on blue.
- 11. For JV Assemblies that have a mixture of Non-Interstate and Auto-Tour shields, arrows and cardinals shall be black on white.

black white black background

ROUTE MARKERS & COMPONENTS IN TYPICAL ASSEMBLIES

WISCONSIN DEPT OF TRANSPORTATION

APPROVED For State Traffic Engineer

DATE 6/7/23

PLATE NO. <u>A2-1S.10</u> Ε SHFFT NO:

PROJECT NO:

FRONTAGE

ROAD

J12-1

PLOT NAME :





RURAL AREA (See Note 2)



GENERAL NOTES

- 1. Signs wider than 4 feet or 20 sq.ft or larger, shall be mounted on multiple posts. Refer to plate A4-4.
- 2. If signs are mounted on or behind barrier wall, see A4-10 sign plate.

The Double Arrow sign (W12-1D) shall be mounted at a height of 2'-3" (\pm) 3". The Chevron sign (W1-8), Roundabout Chevron panel (R6-4B), Enhanced Reference Markers, Clearance Markers (W5-52), Mile Markers (D10 series), In Road Object Markers (W5-54) & End of Road Markers (W5-56) shall be mounted at a height of 4'-3" (\pm) 3".

- 3. For expressways and freeways, mounting height is 7'- 3" (\pm) 3" or 6'-3" (\pm) 3" depending upon existence of a sub-sign.
- 4. Minimum mounting height for signs mounted on traffic signal poles is 5' 3'' ($\frac{+}{-}$) 3''.
- 5. Offset distance shall be consistent with existing signs or consistent throughout length of project.
- 6. Folding signs shall be mounted at a height of 5'-3'' (\pm) 3'' or as directd by the Engineer.

2' Min - 4' Max (See Note 5)



White Edgeline
Location

Outside Edge
of Gravel

POST EMBEDMENT DEPTH

Area of Sign	
Installation	D
(Sq.Ft.)	(Min)
20 or Less	4'
Greater than 20	5'

The existence of curb and gutter does not in itself mandate the vertical clearance illustrated. That height is typically measured where there is sidewalk adjacent to the roadway or parking is permitted. In the absence of sidewalk vertical clearance is measured from the top of the curb. Offset of signs is measured from the flow line.

* 6 feet from edge of a paved shoulder or 12 feet from the edge of pavement (edge line location) or 2 feet from outside edge of gravel, whichever is greater unless directed by project engineer.

PLOT BY : mscj9h

TYPICAL INSTALLATION
OF PERMANENT TYPE II
SIGNS ON SINGLE POSTS

WISCONSIN DEPT OF TRANSPORTATION

APPROVED

Matthew R Rawh

For State Traffic Engineer

DATE 12/6/23 PLATE NO. __A4-3.23

Ε

PROJECT NO: HWY: COUNTY: SHEET NO:



NOTES: 1. ALL MATERIAL TO BE APPROVED

BY ENGINEER PRIOR TO INSTALLATION

- 2. SEE SIGN PLATE A4-8 FOR SIGN HARDWARE REQUIREMENTS
- 3. 18 INCH X 18 INCH SQUARE BOX-OUTS MAY BE USED FOR INSTALLATIONS IN EXISTING CONCRETE OR ASPHALT LOCATIONS.



ELEVATION VIEW

DETAIL OF STEEL 2 X 2 SIGN POST IN BOX-OUT



DETAIL OF WOOD 4 X 6 SIGN POST IN BOX-OUT

HWY:



PLAN VIEW

COUNTY:

FOR NEW CONCRETE/ASPHALT INSTALLATIONS

SIGN POST BOX-OUTS A4-3B

WISCONSIN DEPT OF TRANSPORTATION

For State Traffic Engineer

DATE 1/27/14 PLATE NO. A4-3B.1

SHEET NO:

FILE NAME : C:\CAEFiles\Projects\tr_stdplate\A43B.DGN

PROJECT NO:

PLOT DATE: 27-JAN-2014 09:48

PLOT NAME :

PLOT BY: mscsja

PLOT SCALE: 13.659812:1.000000

APPROVED

WISDOT/CADDS SHEET 42





2'Min - 4'Max (See Note 6)



	SIGN SHAPE OTHER THAN (TWO POSTS REQUIRE)	
	L	E
***	Greater than 48" Less than 60"	12"
	60" to 108"	L/5

HWY:

SIGN SHAPE OTHER THAN	DIAMOND
(THREE POSTS REQUIRED)	
L	E
Greater than 108" to 144"	12''

GENERAL NOTES

- 1. For 3 or 4 post installations, individual post spacing shall be greater than 3'-6".
- 2. See tables below for required number of posts.
- 3. For expressways and freeways, mounting height is 7'-3" (±) 3" or 6'-3" (±) 3" depending upon existence of sub-sign.
- 4. The (±) tolerance for mounting height is 3 inches.
- 5. J-Assemblies are considered to be one sign for mounting height.
- 6. Offset distance shall be consistent with existing signs or consistent throughout length of project.
- 7. Folding signs shall be mounted at a height of 5'-3'' (\pm) 3'' or as directed by the engineer.
- 8. The Double Arrow sign (W12-1) shall be mounted at a height of 2'-3" (±) 3". The Chevron sign (W1-8), Roundabout Chevron panel (R6-4B), Clearance Markers (W5-52), Mile Markers (D10 series), In Road Object Markers (W5-54) & End of Road Markers (W5-56) shall be mounted at a height of 4"-3" (±) 3".
- * 6 feet from edge of a paved shoulder or 12 feet from the edge of pavement (edge line location) or 2 feet from outside edge of gravel, whichever is greater unless directed by project engineer.
- ** The existence of curb and gutter does not in itself mandate the vertical clearance illustrated. That height is typically measured where there is sidewalk adjacent to the roadway or parking is permitted. In the absence of sidewalk vertical clearance is measured from the top of the curb. Offset of signs is measured from the flow line.
- $\times \times \times$ See A4-3 sign plate for signs 4' or less in width and less than 20 S.F. in area.

POST EMBEDMENT DEPTH

	ı
Area of Sign	
Installation	D
(Sq. Ft.)	(Min)
20 or Less	4'
Greater than 20	5'

TYPICAL INSTALLATION OF TYPE II SIGNS ON MULTIPLE POSTS

WISCONSIN DEPT OF TRANSPORTATION

APPROVED

Matther R Rauch
For State Traffic Engineer

DATE 12/6/23

PLATE NO. <u>A4-4.16</u>

Ε

CUEET NO.

SHEET NO:

FILE NAME : C:\CAEfiles\Project\tr_stdplate\A44.dgn

PROJECT NO:


COUNTY:

PLOT DATE: 6-DEC 2023 11:31

PLOT NAME :

PLOT BY : mscj9h

PLOT SCALE: \$\$.....plotscale.....\$\$ WISDOT/CADDS SHEET 42

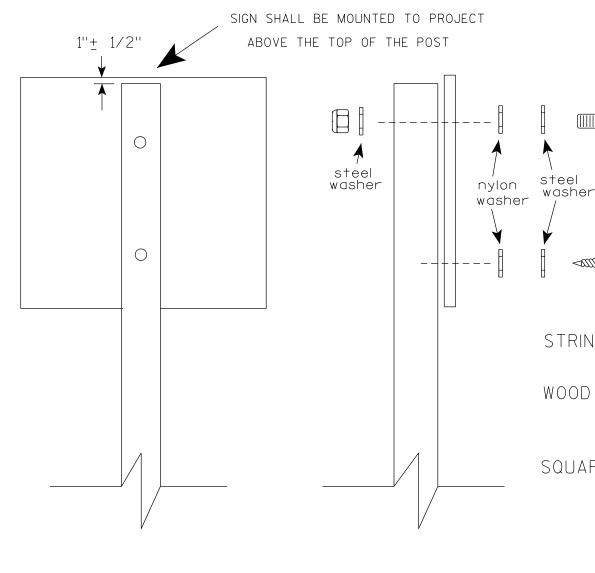

Nuts, bolts and lags used for mounting signs shall have hexagonal heads and shall be either:

- a. Hot dip galvanized in accordance with ASTM Designation: A 153. Class D. or SC 3
- b. Electro-galvanized in accordance with ASTM Designation: B 633, TYPE III, SC 3.

Threads on bolts and nuts shall be manufactured with sufficient allowance for the cadmium plate or galvanized coating to permit the nuts to run freely on the bolts.

STRINGER BOLTING TO ALUMINUM SIGNS (SEE SIGN PLATE A4-18)

MACHINE BOLTS - $\frac{5}{16}$ " X 1-3/4" Length w/ lock nuts

WOOD POSTS $(4'' \times 6'')$

LAG SCREWS - 3/8" X 3" (NO STRINGERS ON BACK OF SIGN) 3/8" X 4" (STRINGERS ON BACK OF SIGN)

SQUARE STEEL POSTS (2" x 2")

MACHINE BOLTS - 3/8" X 3-1/4" Length w/ nuts (NO STRINGER ON BACK OF SIGN) 3/8" X 5" Length w/ nuts (STRINGERS ON BACK OF SIGN)

RIVETS - 3/32 " (6605-9-6) BULB-TITE. TRI-FOLD. ALUMINUM BODY/MANDREL O.D. FLANGE .720-.765 INCH, GRIP RANGE .042-.375 INCH

WASHERS (ALL POSTS) -

1-1/4" O.D. X $\frac{3}{8}$ " I.D. X $\frac{1}{16}$ " STEEL 1-1/4" O.D. X $\frac{3}{8}$ " I.D. X .080 NYLON

Two different fastening systems are shown for illustration purposes. On any individual sign, either one or the other system shall be used. Actual number of fasteners per sign varies with the sign area, but normally there are two. For a single post installation, all signs greater than 9 sq.ft. require the use of 3 fasteners.

ATTACHMENT OF SIGNS TO POSTS

APPROVED

DATE 4/1/2020

PLATE NO. <u>A4-8.9</u>

FILE NAME : C:\CAEFiles\Projects\tr_stdplate\A48.DGN

PROJECT NO:

PLOT DATE: 01-APRIL-2020

PLOT BY : dotc4c


WISDOT/CADDS SHEET 42

Ε

WISCONSIN DEPT OF TRANSPORTATION

Matther ≠or State Traffic Engineer

SHEET NO:

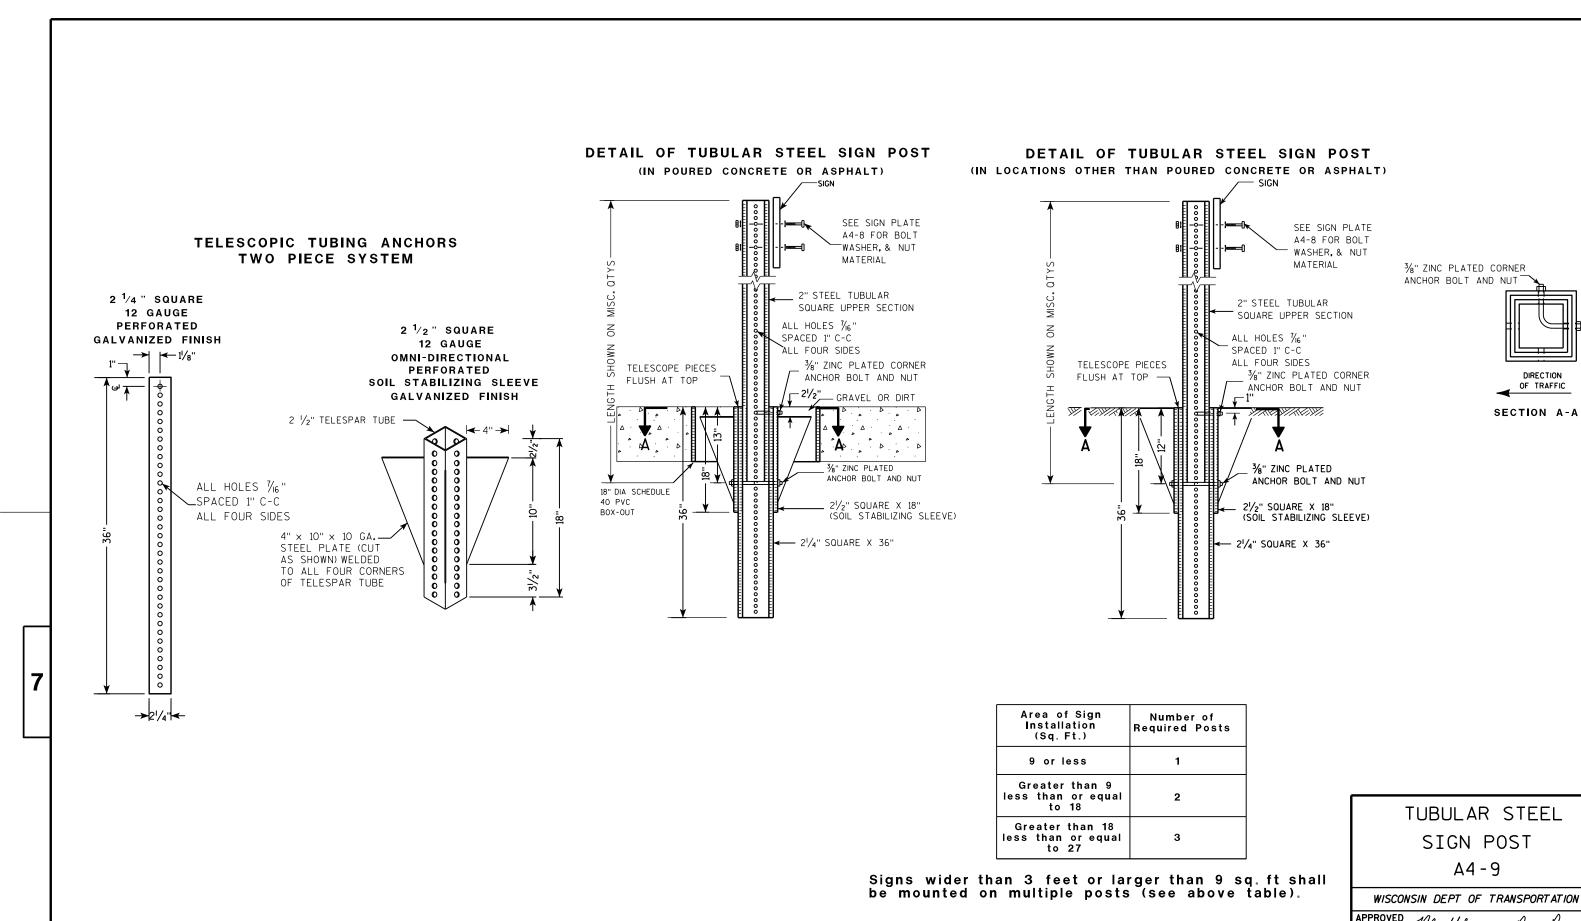

PROJECT NO: SHEET NO: E

FILE NAME: C:\CAEFiles\Projects\tr_stdplate\A49.DGN

PLOT DATE: 05-FEB-2015 17:09

PLOT DATE: 05-FEB-2015 17:09

PLOT NAME: PLOT NAME: PLOT SCALE: 13.659812:1.000000


WISDOT/CADDS SHEET 42

For State Traffic Engineer

PLATE NO. <u>A4-9.9</u>

DATE 2/05/15




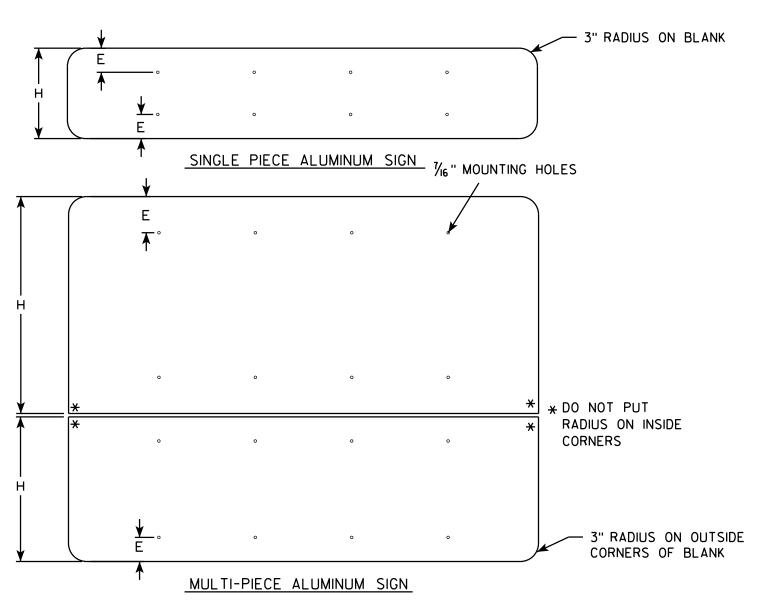

GENERAL NOTES

- ALL SIGNS OVER 60" IN WIDTH SHALL HAVE A 3" RADIUS ON THE OUTSIDE CORNERS OF THE ALUMINUM BLANK.
- MOUNTING HOLES SHALL BE $\frac{7}{16}$ " DIAMETER.
- SEE CHART FOR HOLE SPACING REQUIREMENTS
- FOR SIGN PANELS WITH DIMENSION (H) 36" AND OVER, DIMENSION E SHALL BE 6"
- FOR SIGN PANELS WITH DIMENSION (H) UNDER 36", DIMENSION E SHALL BE 4"
- SIGN STRINGER MATERIAL SHALL CONSIST OF STEEL CHANNEL POST SECTIONS, WEIGHING 1.12 LBS/FT IN ACCORDANCE WITH SECTION 633.2.1 OF THE STANDARD SPECIFICATIONS FOR HIGHWAY AND STRUCTURE CONSTRUCTION.
- SEE SIGN PLATE A4-8 FOR SIGN STRINGER BOLTING REQUIREMENTS.

SIGN WIDTH	STRINGER WIDTH	POSTS	HOLE SPACING				NTING OLES			
7 8''	7 2"	2	16''	15''	31''	47''	63''			
84''	72"	2	17''	161/2"	331/2"	501/2"	6 7 1/2	1		
90"	72"	2	18''	18''	36''	54''	72"			
96"	90''	2	19''	191/2"	381/2''	57½"	761/2			
102"	90''	2	20"	21''	41''	61''	81''			
108''	90"	2	21''	221/21	' 43 ^l / ₂ ''	641/2"	851/21			
114''	108''	3	15''	12''	2 7 ''	42''	57''	72"	87''	102''
120''	108''	3	16''	12''	28''	44''	60"	76"	92"	108''
126"	108''	3	17''	12''	29"	46''	63''	80"	97''	114''
132"	126''	3	18''	12''	30"	48''	66''	84"	102"	120''
138''	126''	3	19"	12''	31''	50"	69"	88"	107''	126"
144''	126"	3	20"	12''	32"	52"	72"	92"	112''	132"

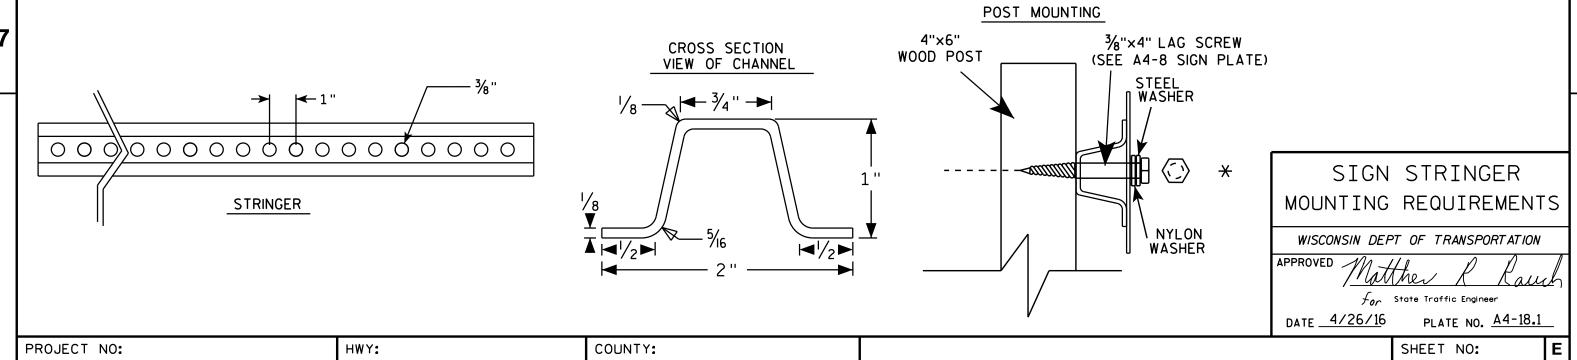

PLOT BY: mscj9h

BANDING



SINGLE SIGN





WASHER PLACEMENT



HWY:

WASHERS (ALL POSTS) -

1-1/4" O.D. X³/₈" I.D. X¹/₁₆" STEEL 1-1/4" O.D. $\times \frac{3}{8}$ " I.D. \times .080 NYLON FOR ALL TYPE H SIGNS

CHANNEL

GENERAL NOTES

- 1. Any sign over 3 feet in width shall use the V-Block banding method. See A5-10 standard plate.
- 2. Signs 3 feet or greater in height shall have three bracket bands installed. Signs less than 3 feet in height shall have two bracket bands installed.
- 3. Banding and assembly bracket shall be stainless steel. All bands shall be $\frac{3}{4}$ " in width and 0.025" thickness.
- 4. ALL SIGN MOUNTING BOLTS AND WASHERS SHALL BE EITHER:
 - a. Hot dip or mechanically galvanized in accordance with ASTM Designation: A 153, Class D
 - b. Electro-galvanized in accordance with ASTM designation: B 633, Type III, SC 3

"J" ASSEMBLY



STANDARD SIGN SIGN BANDING DETAILS

WISCONSIN DEPT OF TRANSPORTATION

SHEET NO:

APPROVED

DATE 6/10/19

PLATE NO. A5-9.4

Ε

State Traffic Engineer

COUNTY:

PLOT NAME :

PLOT SCALE: \$\$.....plotscale.....\$\$ WISDOT/CADDS SHEET 42

PROJECT NO:

31/2"

VIEW FROM TOP

GENERAL NOTES

- 1. WOOD 4"X6" POST MATERIAL SHALL CONFORM TO 507.2.2 OF THE WISDOT STANDARD SPECIFICATIONS
- 2. BLOCK BANDING AND CLIPS SHALL BE STAINLESS STEEL, $\frac{3}{4}$ " WIDTH AND 0.025" THICKNESS
- 3. SIGNS 3' OR GREATER IN HEIGHT SHALL UTILIZE 3 BLOCK BANDS. SIGNS UNDER 3' IN HEIGHT SHALL UTILIZE 2 BLOCK BANDS
- 4. ACTUAL NUMBER OF FASTENERS PER SIGN VARIES WITH THE SIGN AREA. BUT NORNALLY THERE ARE TWO. FOR SIGNS GREATER THAN 9 S.F. 3 FASTENERS SHALL BE USED.
- 5. ALL SIGN MOUNTING BOLTS AND WASHERS SHALL BE EITHER:
 - a. Hot dip or mechanically galvanized in accordance with ASTM Designation: A 153, Class D
 - b. Electro-galvanized in accordance with ASTM Designation: B 633, TYPE III, SC 3
- 6. ALL BOLTS SHALL HAVE HEXAGONAL HEADS.
- 7. STEEL WASHERS SHALL BE $1^{1}/_{4}$ " O.D. X $3/_{16}$ " I.D. X $1/_{16}$ "
- 8. NYLON WASHERS SHALL BE $1^{1}/_{4}$ " O.D. X $3/_{8}$ " I.D. X .080 FOR TYPE H OR TYPE F FACE SIGN

 \times LAG BOLTS SHALL BE $\frac{3}{8}$ " X $\frac{2}{2}$ "

BLOCK BANDING DETAIL (V-BLOCK OPTION)

WISCONSIN DEPT OF TRANSPORTATION

DATE 4/19/2022 PLATE NO. A5-10.3

SHEET NO:

APPROVED

PROJECT NO:

FILE NAME : C:\CAEfiles\Projects\tr_stdplate\A510.dgr

PLOT DATE: 19-APRIL 2022 11:55

PLOT BY : dotc4c

WISDOT/CADDS SHEET 42

Ε


SIGN



- 1. Sign is Type II Type H Reflective
- 2. Color:

Background - GREEN Message - WHITE

3. Message Series - C

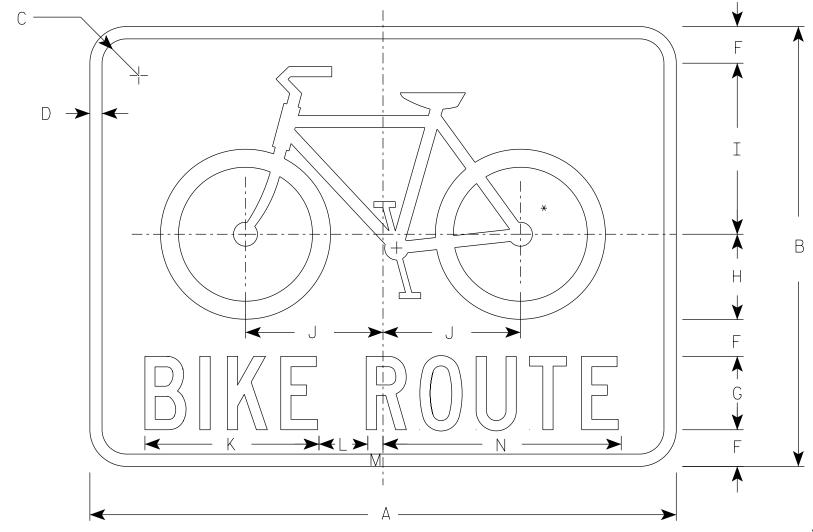

D11-1

* See W11-1 for symbol design

А	В	С	D	Е	F	G	Н	I	J	K	L	М	N	0	Р	Q	R	S	Т	U	V	W	X	Υ	Z	Area sq. ft.	
24	18	1 1/2	1/2		1 1/2	3	3 1/2	7	5 %	7 1/8	2	5/8	9 3/4													3.0	ΙL
24	18	1 1/2	1/2		1 1/2	3	3 1/2	7	5 %	7 1/8	2	5/8	9 3/4													3.0	ΙL
30	24	1 1/2	5/8		2	4	4 3/4	9 1/4	7 1/2	9 1/2	2 %	7∕8	13													5.0	
																											1
																											1
	24 24 30	A B 24 18 24 18 30 24	A B C 24 18 1 ½ 24 18 1 ½ 30 24 1 ½	24 18 1 1/2 1/2	24 18 1 1/2 1/2	24 18 1 1/2 1/2 1 1/2	24 18 1 1/2 1/2 1 1/2 3	24 18 1 ½ ½ 1½ 3 3 ½ 24 18 1 ½ ½ 1½ 3 3 ½ 24 18 1 ½ ½ 1½ 3 3 ½	24 18 1 ½ ½ 1½ 3 3½ 7 24 18 1½ ½ 1½ 3 3½ 7	24 18 1 ½ ½ 1½ 3 3 ½ 7 5 ½ 24 18 1 ½ ½ 1½ 3 3 ½ 7 5 ½	24 18 1 ½ ½ 1½ 3 3 ½ 7 5 5/8 7 ⅓ 24 18 1 ½ ½ 1½ 3 3 ½ 7 5 5/8 7 ⅓ 24 18 1 ½ ½ 1½ 3 3 ½ 7 5 5/8 7 ⅓	24 18 1 ½ ½ 1 ½ 3 3 ½ 7 5 5/8 7 ⅓ 2 24 18 1 ½ ½ 1 ½ 3 3 ½ 7 5 5/8 7 ⅓ 2 24 18 1 ½ ½ 1 ½ 3 3 ½ 7 5 5/8 7 ⅓ 2	24 18 1 ½ ½ 1 ½ 3 3 ½ 7 5 5/8 7 ⅓ 2 5/8 24 18 1 ½ ½ 1 ½ 3 3 ½ 7 5 5/8 7 ⅓ 2 5/8 24 18 1 ½ ½ 1 ½ 3 3 ½ 7 5 5/8 7 ⅓ 2 5/8	24 18 1 ½ ½ 1 ½ 3 3 ½ 7 5 5/8 7 ⅓ 2 5/8 9 ¾ 24 18 1 ½ ½ 1 ½ 3 3 ½ 7 5 5/8 7 ⅓ 2 5/8 9 ¾ 24 18 1 ½ ½ 1 ½ 3 3 ½ 7 5 5/8 7 ⅓ 2 5/8 9 ¾	24 18 1 ½ ½ 1 ½ 3 3 ½ 7 5 5/8 7 ⅓ 2 5/8 9 ¾ 24 18 1 ½ ½ 1 ½ 3 3 ½ 7 5 5/8 7 ⅓ 2 5/8 9 ¾ 24 18 1 ½ ½ 1 ½ 3 3 ½ 7 5 5/8 7 ⅓ 2 5/8 9 ¾	24 18 1 ½ ½ 1 ½ 3 3 ½ 7 5 5/8 7 ⅓ 2 5/8 9 ¾ 24 18 1 ½ ½ 1 ½ 3 3 ½ 7 5 5/8 7 ⅓ 2 5/8 9 ¾ 24 18 1 ½ ½ 1 ½ 3 3 ½ 7 5 5/8 7 ⅓ 2 5/8 9 ¾	24 18 1 ½ ½ 1 ½ 3 3 ½ 7 5 5/8 7 ⅓ 2 5/8 9 ¾ 24 18 1 ½ ½ 1 ½ 3 3 ½ 7 5 5/8 7 ⅓ 2 5/8 9 ¾ 24 18 1 ½ ½ 1 ½ 3 3 ½ 7 5 5/8 7 ⅓ 2 5/8 9 ¾	24 18 1 ½ ½ 1 ½ 3 3 ½ 7 5 5/8 7 ⅓ 2 5/8 9 ¾ 24 18 1 ½ ½ 1 ½ 3 3 ½ 7 5 5/8 7 ⅓ 2 5/8 9 ¾ 24 18 1 ½ ½ 1 ½ 3 3 ½ 7 5 5/8 7 ⅓ 2 5/8 9 ¾	24 18 1 ½ ½ 1 ½ 3 3 ½ 7 5 5/8 7 ⅓ 2 5/8 9 ¾ 24 18 1 ½ ½ 1 ½ 3 3 ½ 7 5 5/8 7 ⅓ 2 5/8 9 ¾ 24 18 1 ½ ½ 1 ½ 3 3 ½ 7 5 5/8 7 ⅓ 2 5/8 9 ¾	24 18 1 ½ ½ 1 ½ 3 3 ½ 7 5 5/8 7 ½ 2 5/8 9 ¾ 24 18 1 ½ ½ 1 ½ 3 3 ½ 7 5 5/8 7 ½ 2 5/8 9 ¾ 24 18 1 ½ ½ 1 ½ 3 3 ½ 7 5 5/8 7 ½ 2 5/8 9 ¾	24 18 1 ½ ½ 1 ½ 3 3 ½ 7 5 % 7 ½ 2 5% 9 ¾ 24 18 1 ½ ½ 1 ½ 3 3 ½ 7 5 % 7 ½ 2 5% 9 ¾ 24 18 1 ½ ½ 1 ½ 3 3 ½ 7 5 % 7 ½ 2 5% 9 ¾	24 18 1 ½ ½ 1 ½ 3 3 ½ 7 5 5/8 7 ⅓ 2 5/8 9 ¾ 24 18 1 ½ ½ 1 ½ 3 3 ½ 7 5 5/8 7 ⅓ 2 5/8 9 ¾ 24 18 1 ½ ½ 1 ½ 3 3 ½ 7 5 5/8 7 ⅓ 2 5/8 9 ¾	24 18 1 ½ ½ 1 ½ 3 3 ½ 7 5 % 7 ½ 2 5% 9 ¾ 24 18 1 ½ ½ 1 ½ 3 3 ½ 7 5 % 7 ½ 9 ¾ 24 18 1 ½ ½ 1 ½ 3 3 ½ 7 5 % 7 ½ 2 % 9 ¾	24 18 1 ½ ½ 1 ½ 3 3 ½ 7 5 % 7 ½ 2 5% 9 ¾ 24 18 1 ½ ½ 1 ½ 3 3 ½ 7 5 % 7 ½ 2 5% 9 ¾ 24 18 1 ½ ½ 1 ½ 3 3 ½ 7 5 % 7 ½ 2 5% 9 ¾	24 18 1 ½ ½ 1 ½ 3 3 ½ 7 5 5/8 7 ½ 2 5/8 9 ¾ 24 18 1 ½ ½ 1 ½ 3 3 ½ 7 5 5/8 7 ½ 2 5/8 9 ¾ 24 18 1 ½ ½ 1 ½ 3 3 ½ 7 5 5/8 7 ½ 2 5/8 9 ¾	24 18 1 ½ ½ 1 ½ 3 3 ½ 7 5 % 7 ½ 2 5 % 9 ¾ 24 18 1 ½ ½ 1 ½ 3 3 ½ 7 5 % 7 ½ 9 ¾ 24 18 1 ½ ½ 1 ½ 3 3 ½ 7 5 % 7 ½ 9 ¾	24 18 1 ½ ½ 1 ½ 3 3 ½ 7 5 5% 7 ½ 2 5 % 7 ½ 9 ¾

STANDARD SIGN D11-1

WISCONSIN DEPT OF TRANSPORTATION

APPROVED Matthew

For State Traffic Engineer

DATE 1/25/2023 PLATE NO. D11-1.3

SHEET NO:

FILE NAME : C:\Users\PROJECTS\tr_stdplate\D111.dgn

PROJECT NO:

PLOT DATE: 25-MAR 2023 2:15

PLOT BY : dotc4c

WISDOT/CADDS SHEET 42

E



- 1. Sign is Type II Type H Reflective
- 2. Color:


Background - White Message – Black

3. Message Series - D except 3 number signs Series C

	F A
	BLACK V
← A	————

M1-6

HWY:

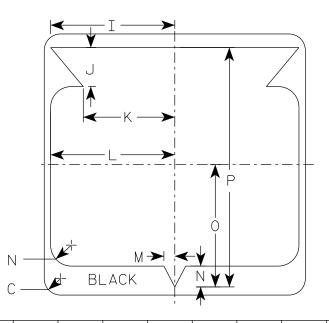

SIZ	E A	4	ВС	D E		F	G	Н	I	J	K	L	М	N	0	Р	Q	R	S	T	U	٧	W	X	Υ	Z	Area sq. ft.
1																											
2	24	4	1 1/2		1	12	5 1/2	6 1/2	10 1/4	2 1/2	8 1/8	11 1/2	1	1 1/8	11 1/4	21 1/8											4.0
21	1 24	4	1 1/2		1	12	5 1/2	6 1/2	10 1/4	2 1/2	8 1/8	11 1/2	1	1 1/8	11 1/4	21 1/8											4.0
3	36	6	2 1/4		1	18	8 3/4	9 1/4	15 3/8	5 3/8	12 5/8	17 1/8	1 1/2	2 1/8	16 1/8	33											9.0
4	36	6	2 1/4		1	18	8 3/4	9 1/4	15 3/8	5 3/8	12 5/8	17 1/8	1 1/2	2 1/8	16 1/8	33											9.0
5	36	6	2 1/4		1	18	8 3/4	9 1/4	15 3/8	5 3/8	12 5/8	17 1/8	1 1/2	2 1/8	16 7/8	33											9.0

COUNTY:

STATE ROUTE MARKER M1-6 FOR ASSEMBLIES

WISCONSIN DEPT OF TRANSPORTATION

SHEET NO:

APPROVED

₹or State Traffic Engineer

DATE 11/8/2022 PLATE NO. M1-6.11

Ε

FILE NAME : C:\CAEfiles\Projects\tr_stdplate\M16.dgn

PROJECT NO:

PLOT DATE: 8-NOV 2022 8:40


PLOT BY : dotc4c

PLOT NAME :

- 1. Sign is Type II Type H Reflective
- 2. Color:

Background - White Message - Black

3. Message Series - C

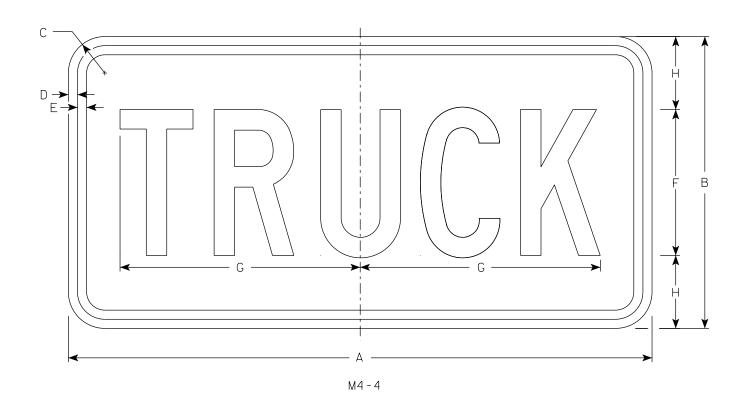

SIZE	А	В	С	D	E	F	G	Н	I	J	K	L	М	N	0	Р	Q	R	S	Т	U	٧	W	X	Y	Z	Area sq. ft.
1																											
2	24	12	1 1/2	3/8	3/8	6	9 7/8	3																			2.0
2M	24	12	1 1/2	3/8	3/8	6	9 1/8	3																			2.0
3	36	18	1 1/2	3/8	1/2	9	15 %	4 1/2																			4.5
4	36	18	1 1/2	3/8	1/2	9	15 %	4 1/2																			4.5
5	36	18	1 1/2	3/8	1/2	9	15 5/8	4 1/2																			4.5

COUNTY:

STANDARD SIGN M4 - 4

WISCONSIN DEPT OF TRANSPORTATION

DATE 11/21/2022 PLATE NO. M4-4.4

SHEET NO:

HWY:

PROJECT NO:

PLOT DATE: 28-MARCH 2023 8:44

PLOT BY : dotc4c

PLOT NAME :

PLOT SCALE: \$\$.....plotscale.....\$\$ WISDOT/CADDS SHEET 42

FILE NAME : C:\CAEfiles\Projects\tr_stdplate\M44.dgn

- 1. Sign is Type II Type H Reflective
- 2. Color:

Background - See note 5 Message - See note 5

- 3. Message Series E
- 4. Corners may be square or rounded when base material is plywood but borders shall be rounded as shown. When base material is metal, the corners and borders shall be rounded.
- 5. M4-5 Background White

Message – Black

MB4-5 Background - Blue

Message - White

MK4-5 Background - Green

Message - White

MM4-5 Background - White

Message – Green

MN4-5 Background - Brown

Message - White

MP4-5 Background - White

Message - Blue

M04-5 Background - Orange Type F Reflective

Message - Black

~	Å	—
	M4-5	·
	MM4-5	
	MP4-5	
	MO4-5	
C — ¥	į	
	MB4-5 MK4-5 MN4-5	GYA B AGY F AGY AGY

HWY:

SIZE Χ Α Ε Q U 3/8 3/8 5 3/8 5 1/4 24 12 $1 \frac{1}{2}$ 1/26 2.00 2M 2.00 24 3/8 3/8 5 3/8 | 5 1/4 12 $1 \frac{1}{2}$ 6 1/2 4.5 36 18 $1 \frac{1}{2}$ 3/8 1/2 9 4 1/2 8 1/4 8 3/8 1/2 4 4.5 36 3/8 4 1/2 | 8 1/4 | 8 3/8 18 $1 \frac{1}{2}$ 1/2 9 1/2 5 4 1/2 8 1/4 8 3/8 4.5 36 18 $1 \frac{1}{2}$ 3/8 1/2 1/2

COUNTY:

STANDARD SIGN M4-5

WISCONSIN DEPT OF TRANSPORTATION

APPROVED

For State Traffic Engineer

DATE 2/8/2023 PLATE NO. M4-5.11

SHEET NO:

FILE NAME : C:\CAEFiles\Projects\tr_stdplate\M45.DGN

PROJECT NO:

PLOT DATE: 8-FEB 2023 3:48

PLOT BY : dotc4c

PLOT NAME :

PLOT SCALE: \$\$.....plotscale.....\$\$ WISDOT/CADDS SHEET 42

I

Ε

- 1. Sign is Type II Type F Reflective
- 2. Color:

Background - Orange Message - Black

- 3. Message Series B
- 4. Corners may be square or rounded when base material is plywood but borders shall be rounded as shown. When base material is metal, the corners and borders shall be rounded.

SIZE	Α	В	С	D	E	F	G	Н	I	J	K	L	М	N	0	Р	Q	R	S	Т	U	٧	W	X	Y	Z	Area sq. ft.
1																											
2	24	12	1 1/2	3/8	3/8	6	3	10	10 1/4																		2.0
2M	24	12	1 1/2	3/8	3/8	6	3	10	10 1/4																		2.0
3	36	18	1 1/2	3/8	1/2	9	4 1/2	14 5/8	14 1/2																		4.5
4	36	18	1 1/2	3/8	1/2	9	4 1/2	14 5/8	14 1/2																		4.5
5	36	18	1 1/2	3/8	1/2	9	4 1/2	14 5/8	14 1/2																		4.5
			- / 2	/ 0	/ 2		, , ,	, , ,	- / 2																		<u> </u>

COUNTY:

STANDARD SIGN M4-8

WISCONSIN DEPT OF TRANSPORTATION

APPROVED Matthe R Rauch

DATE 2/9/2023 PLATE NO. M4-8.4

SHEET NO:

PROJECT NO:

FILE NAME: C:\CAEfiles\Projects\tr_stdplate\M48.dgn

HWY:

PLOT DATE : 9-FEB 2023 7:38

PLOT BY : dotc4c

PLOT NAME :

1. Sign is Type II - Type F Reflective

2. Color:

Background - Orange Message - Black

- 3. Message Series B
- 4. Corners may be square or rounded when base material is plywood but borders shall be rounded as shown. When base material is metal, the corners and borders shall be rounded.

C		
		G F F
		H B F G G
	А	
·	M4 - 8 A	

SIZE	А	В	С	D	E	F	G	Н	I	J	K	L	М	N	0	Р	Q	R	S	T	U	٧	W	Х	Y	Z	Area sq. ft.
1																											
2	24	18	1 1/2	3/8	1/2	6	2	2	4 3/4	9 3/4																	3.0
2M	24	18	1 1/2	3/8	1/2	6	2	2	4 3/4	9 3/4																	3.0
3	30	24	1 1/2	3/8	1/2	8	2 1/2	3	6 3/4	13																	5.0
4	30	24	1 1/2	3/8	1/2	8	2 1/2	3	6 3/4	13																	5.0
5	30	24	1 1/2	3/8	1/2	8	2 1/2	3	6 3/4	13																	5.0

COUNTY:

STANDARD SIGN M4-8A

WISCONSIN DEPT OF TRANSPORTATION

for State Traffic Engineer

DATE 2/9/2023 PLATE NO. M4-8A.4 SHEET NO:

HWY:

PROJECT NO:

PLOT DATE: 9-FEB 2023 8:03

PLOT BY : dotc4c

PLOT NAME :

PLOT SCALE: \$\$.....plotscale.....\$\$ WISDOT/CADDS SHEET 42

FILE NAME : C:\CAEfiles\Projects\tr_stdplate\M48A.dgn

2. Color:


Background - Orange

Message - Black

NOTES

1. Sign is Type II-Type F Reflective

- 3. Message Series D
- 4. Corners may be square or rounded when base material is plywood but borders shall be rounded as shown. When base material is metal, the corners and borders shall be rounded.
- 5. M4-9CL is the same as M4-9CR except the arrow is reversed.

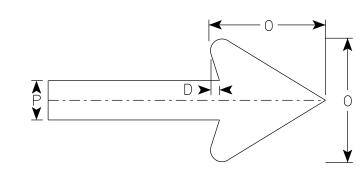

Arrow Detail

SIZE	А	В	С	D	E	F	G	Н	I	J	К	L	М	N	0	Р	Q	R	S	Т	U	٧	W	Х	Y	Z	Area sq. ft.
1																											
25	30	24	1 1/8	3/8	1/2	5	5 1/4	6	3 3/4	2	2	3 1/4	11 3/4	7	6	2											5.00
2M	30	24	1 1/8	3/8	1/2	5	5 1/4	6	3 3/4	2	2	3 1/4	11 3/4	7	6	2											5.00
3																											
4																											
5																											

M4-9CR

STANDARD SIGN M4-9C L&R

WISCONSIN DEPT OF TRANSPORTATION

APPROVED Matthew R Rawl Forstate Traffic Engineer

DATE 1/18/2023 PLATE NO. M4-9C.2

PROJECT NO: HWY: COUNTY: SHEET NO:

FILE NAME: C:\CAEfiles\Projects\tr_stdplate\M49C.dgn

PLOT DATE: 18-JAN 2023 2:32

PLOT BY : dotc4c

PLOT NAME :

PLOT SCALE: \$\$.....plotscale.....\$\$ WISDOT/CADDS SHEET 42

7

Background - Orange Message - Black

- 3. Message Series D
- 4. Corners may be square or rounded when base material is plywood but borders shall be rounded as shown. When base material is metal, the corners and borders shall be rounded.

C	\
D → E	H
	→ B B I
	G J I
4	

M4-9CA

HWY:

SIZE	А	В	С	D	Е	F	G	Н	I	J	K	L	М	N	0	Р	Q	R	S	Т	U	٧	W	Χ	Y	Z	Area sq. ft.
1																											
25	30	24	1 1/2	3/8	1/2	5	4	6	2 1/2	2	2	3 1/4	11 3/4	9 1/8													5.0
2M	30	24	1 1/2	3/8	1/2	5	4	6	2 1/2	2	2	3 1/4	11 3/4	9 1/8													5.0
3																											
4																											
5	·																										
		1		Į.	ı		1	ļ								ı	ı		ı								

COUNTY:

STANDARD SIGN M4-9CA

WISCONSIN DEPT OF TRANSPORTATION

APPROVE

For State Traffic Engineer

Ε

DATE <u>2/9/2023</u> PLATE NO. <u>M4-9CA.3</u>

SHEET NO:


FILE NAME : C:\CAEfiles\Projects\tr_stdplate\M49CA.dgn

PROJECT NO:

PLOT DATE : 9-FEB 2023 1:11

PLOT BY : dotc4c


PLOT NAME :

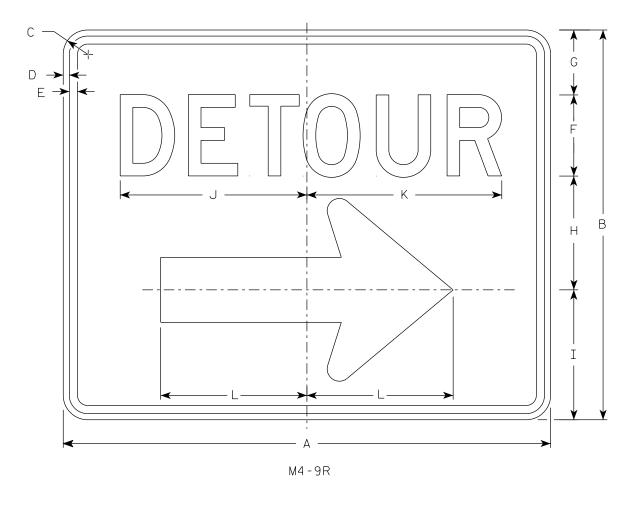

- 1. Sign is Type II Type F Reflective
- 2. Color:

Background - Orange Message - Black

- 3. Message Series D
- 4. Corners may be square or rounded when base material is plywood but borders shall be rounded as shown. When base material is metal, the corners and borders shall be rounded.
- 4. M4-9L is the same as M4-9R except the arrow is reversed.

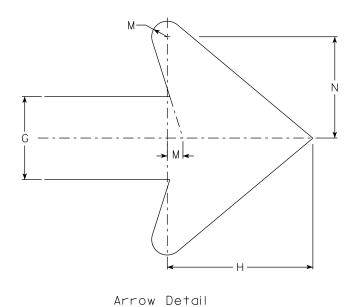

SIZE	Α	В	С	D	E	F	G	Н	I	J	K	L	М	N	0	Р	Q	R	S	Т	U	V	W	X	Y	Z	Area sq. ft.
1																											
2	30	24	1 1/2	3/8	1/2	5	4	7	8	11 1/2	12	9	3/4	4 1/8													5.00
2M	30	24	1 1/2	3/8	1/2	5	4	7	8	11 1/2	12	9	3/4	4 1/8													5.00
3	30	24	1 1/2	3/8	1/2	5	4	7	8	11 1/2	12	9	3/4	4 1//8													5.00
4	48	36	1 1/8	1/2	5/8	8	6	10 1/2	11 5/8	20 5/8 2	0 1/2	13 1/4	1 1/8	6 1/8													12.0
5	48	36	1 1/8	1/2	5/8	8	6	10 1/2	11 5/8	20 5/8 21	0 1/2	13 1/4	1 1/8	6 1/8													12.0

COUNTY:

STANDARD SIGN M4-9 R & L

WISCONSIN DEPT OF TRANSPORTATION

APPROVED Matthew

forState Traffic Engineer PLATE NO. M4-9R.6

DATE <u>2/9/2023</u>

SHEET NO:

Ε

FILE NAME: C:\CAEfiles\Projects\tr_stdplate\M49R.dgn

HWY:

PROJECT NO:


PLOT BY : dotc4c


PLOT NAME :

- 1. Sign is Type II-Type F Reflective
- 2. Color:

Background - Orange Message - Black

3. Message Series - D

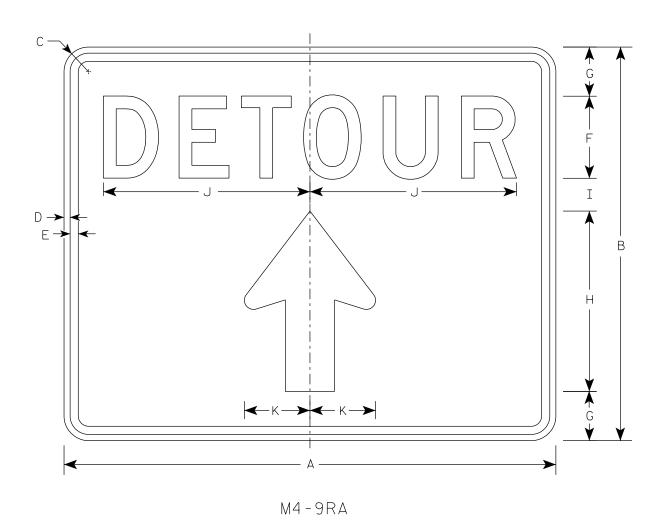

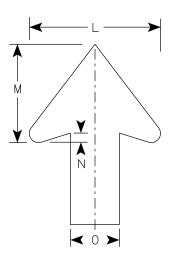

Arrow Detail

SIZE	А	В	С	D	E	F	G	Н	I	J	K	L	М	N	0	Р	Q	R	S	Т	U	٧	W	Х	Y	Z	Area sq. ft.
1																											
25	30	24	1 1/2	3/8	1/2	5	3	11	2	12 5/8	4	8	6	1/2	3												5.00
2M	30	24	1 1/2	3/8	1/2	5	3	11	2	12 5/8	4	8	6	1/2	3												5.00
3																											
4																											
5																											

STANDARD SIGN M4-9RA

WISCONSIN DEPT OF TRANSPORTATION

APPROVED Matthe

For State Traffic Engineer

DATE 2/9/2023 PLATE NO. M4-9RA.3

PROJECT NO: HWY: COUNTY: SHEET NO:

FILE NAME : C:\CAEfiles\Projects\tr_stdplate\M49RA.dgn

PLOT DATE : 9-FEB 2023 4:19

PLOT DATE : 9-FEB 2023 4:19


PLOT NAME : PLOT NAME : PLOT SCALE : \$\$.....plotscale.....\$\$ WISDOT/CADDS SHEET 42

| 1

- 1. Sign is Type II Type F Reflective
- 2. Color:

Background - Orange Message - Black

- 3. Message Series D
- 4. Corners may be square or rounded when base material is plywood but borders shall be rounded as shown when base material is metal.
- 5. M4-59L is the same as M4-59R except the arrow is reversed.

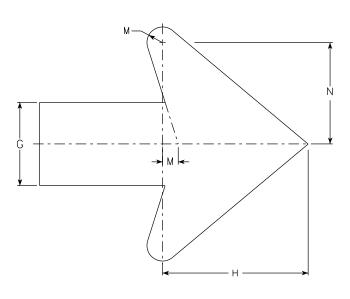

Arrow Detail

	K	
		1
		H
		Y
•		A

M4-59R

HWY:

SIZE	Α	В	C	D	E	F	G	Н	I	J	K	L	М	N	0	Ρ	Q	R	S	Т	U	٧	W	X	Y	Z	Area sq. ft.
1																											
25	30	30	1 1/8	3/8	1/2	5	3 1/2	2 3/4	16	11 ½	12	10 1/2	3/4	4 1/8	2 1/8												6.25
2M	30	30	1 1/8	3/8	1/2	5	3 1/2	2 3/4	16 %	11 1/2	12	10 1/2	3/4	4 1/8	2 1/8												6.25
3	30	30	1 1/8	3/8	1/2	5	3 1/2	2 3/4	16 5/8	11 1/2	12	10 1/2	3/4	4 1/8	2 1/8												6.25
4	48	48	2 1/4	1/2	5/8	8		4 3/8					1 1/8	6 1/8	3 3/8												16.0
5	48	48	2 1/4	1/2	5/8	8	5 %	4 3/8	26 %	20 %	20 1/2	17	1 1/8	6 1/8	3 3/8												16.0

COUNTY:

STANDARD SIGN M4-59 L&R

WISCONSIN DEPT OF TRANSPORTATION

APPROVED

DATE <u>2/13/2023</u> PLATE NO. M4-59.2

SHEET NO:

FILE NAME : C:\CAEfiles\Projects\tr_stdplate\M459.dgn

PROJECT NO:

PLOT DATE: 21-MARCH 2023 1:57


PLOT BY : dotc4c

PLOT NAME :

- 1. Sign is Type II Type F Reflective
- 2. Color:

Background - Orange Message - Black

- 3. Corners may be square or rounded when base material is plywood but borders shall be rounded as shown. When base material is metal, the corners and borders shall be rounded.
- 4. M4-60L is the same as M4-60R except the arrow is reversed.

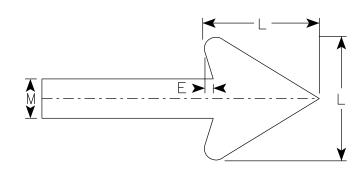

Arrow Detail

D → E	F
	G
	H H
K K	F Y
M4-60R	→

SIZE	А	В	С	D	Е	F	G	Н	I	J	K	L	М	N	0	Р	Q	R	S	Т	U	٧	W	Χ	Y	Z	Area sq. ft.
1																											
25	30	24	1 1/2	3/8	1/2	2 1/2	11	6	2	3 1/4	7	6	2														5.00
2M	30	24	1 1/2	3/8	1/2	2 1/2	11	6	2	3 1/4	7	6	2														5.00
3																											
4																											
5																											

STANDARD SIGN M4-60 L&R

WISCONSIN DEPT OF TRANSPORTATION

APPROVED Matthew For_{State} Traffic Engineer

SHEET NO:

DATE 2/14/2023 PLATE NO. M4-60.2

COUNTY: PROJECT NO:

HWY:

PLOT DATE: 14-FEB 2023 8:12 PLOT BY : dotc4c PLOT NAME :

PLOT SCALE: \$\$.....plotscale.....\$\$ WISDOT/CADDS SHEET 42

FILE NAME: C:\CAEfiles\Projects\tr_stdplate\M460.dgn

- 1. Signs are Type II Type H Reflective except as Shown
- 2. Color:

Background - See note 4 Message - See note 4

- 3. Corners may be square or rounded when base material is plywood but borders shall be rounded as shown. When base material is metal, the corners and borders shall be rounded.
- 4. M6-1 and M6-2 Background White Message - Black

MB6-1 and MB6-2 Background - Blue

Message - White

MK6-1 and MK6-2 Background - Green

Message - White

MM6-1 and MM6-2 Background - White

Message - Green

MN6-1 and MN6-2 Background - Brown

Message - White

M06-1 and M06-2 Background - Orange - Type F Reflective


Message - Black

MP6-1 and MP6-2 Background - White

Message - Blue

MR6-1 and MR6-2 Background - Brown

Message - Yellow

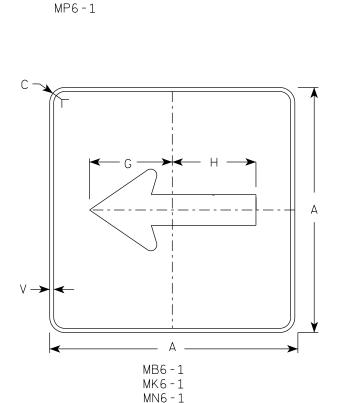


MR6-1

HWY:

M6 - 1

MM6 - 1

M06-1

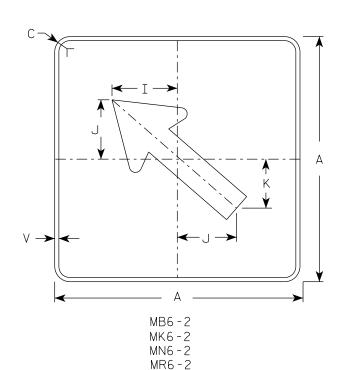


M6-2

MM6 - 2

MO6-2

MP6-2

ARROW DETAIL

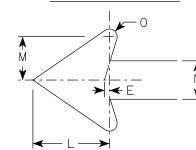

SIZE	. Α	В	С	D	E	F	G	Н	I	J	K	L	М	N	0	Р	Q	R	S	Т	U	V	W	Х	Y	Z	Area sq. ft.
1																											
25	1 21		1 1/2	3/8	3/8		7 1/2	7 1/8	5 %	5	4 1/4	5 1/4	3	2 5/8	1/2							1/2					3.06
2M	21		1 1/2	3/8	3/8		7 1/2	7 1/8	5 %	5	4 1/4	5 1/4	3	2 5/8	1/2							1/2					3.06
3	30)	1 1/8	1/2	5/8		10 3/4	10 1/4	8	7 1/4	6	7 1/2	4 1/4	3 3/4	3/4							1/2					6.25
4	30)	1 1/8	1/2	5/8		10 3/4	10 1/4	8	7 1/4	6	7 1/2	4 1/4	3 3/4	3/4							1/2					6.25
5	30)	1 1/8	1/2	5/8		10 ¾	10 1/4	8	7 1/4	6	7 1/2	4 1/4	3 3/4	3/4							1/2					6.25

COUNTY:

STANDARD SIGN M6-1 & M6-2 SERIES

WISCONSIN DEPT OF TRANSPORTATION

APPROVED For State Traffic Engineer

DATE 2/13/2023 PLATE NO. M6-1.16 SHEET NO:

Ε

PLOT BY : dotc4c PLOT NAME :

PLOT SCALE: \$\$.....plo†scale.....\$\$ WISDOT/CADDS SHEET 42

FILE NAME: C:\CAEfiles\Projects\tr_stdplate_M61.dgn

PROJECT NO:

PLOT DATE: 13-FEB 2023 1:30



- 1. Sign is Type II Type H Reflective reference WIS DOT Standard Specification for HIGHWAY and STRUCTURE CONSTRUCTION latest edition.
- 2. Color:

Background - Red Message - White

3. Message Series - C

*								— А — ;											A	
									H			- G -							F	A
		E						 	-1			_//								*
D	E	F	G	н	I	J	К	L	М	N	0	Р	0	R	S	Т	U	V	W	Х

SIZE	Α	В	С	D	E	F	G	Н	I	J	K	L	М	N	0	Р	0	R	S	T	U	٧	W	Х	Y	Z	Area sq. ft.
1	30				5/8	10	12 1/2	45°		12 3/4																	5.18
2S	30				5/8	10	12 1/2	45°		12 3/4																	5.18
2M	36				3/4	12	15	45°		15 3/8																	7.46
3	36				3/4	12	15	45°		15 3/8																	7.46
4	48				1	16	20	45°		20 1/2																	13.25
5	48				1	16	20	45°		20 1/2																	13.25
6	18				3/8	6	7 3/4	45°		7 3/4																	1.86
7	12				1/4	4	5	45°		5 1/8																	0.78

COUNTY:

STANDARD SIGN R1-1

WISCONSIN DEPT OF TRANSPORTATION

APPROVED

For State Traffic Engineer

DATE <u>11/12/15</u>

PLATE NO. ____R1-1.13

SHEET NO:

FILE NAME : C:\CAEfiles\Projects\tr_stdplate\R11.DGN

HWY:


PROJECT NO:

PLOT DATE: 22-AUG-2017 07:19

PLOT BY: \$\$...plotuser...\$\$ PLOT NAME:

PLOT SCALE: 4.427909:1.000000


WISDOT/CADDS SHEET 42

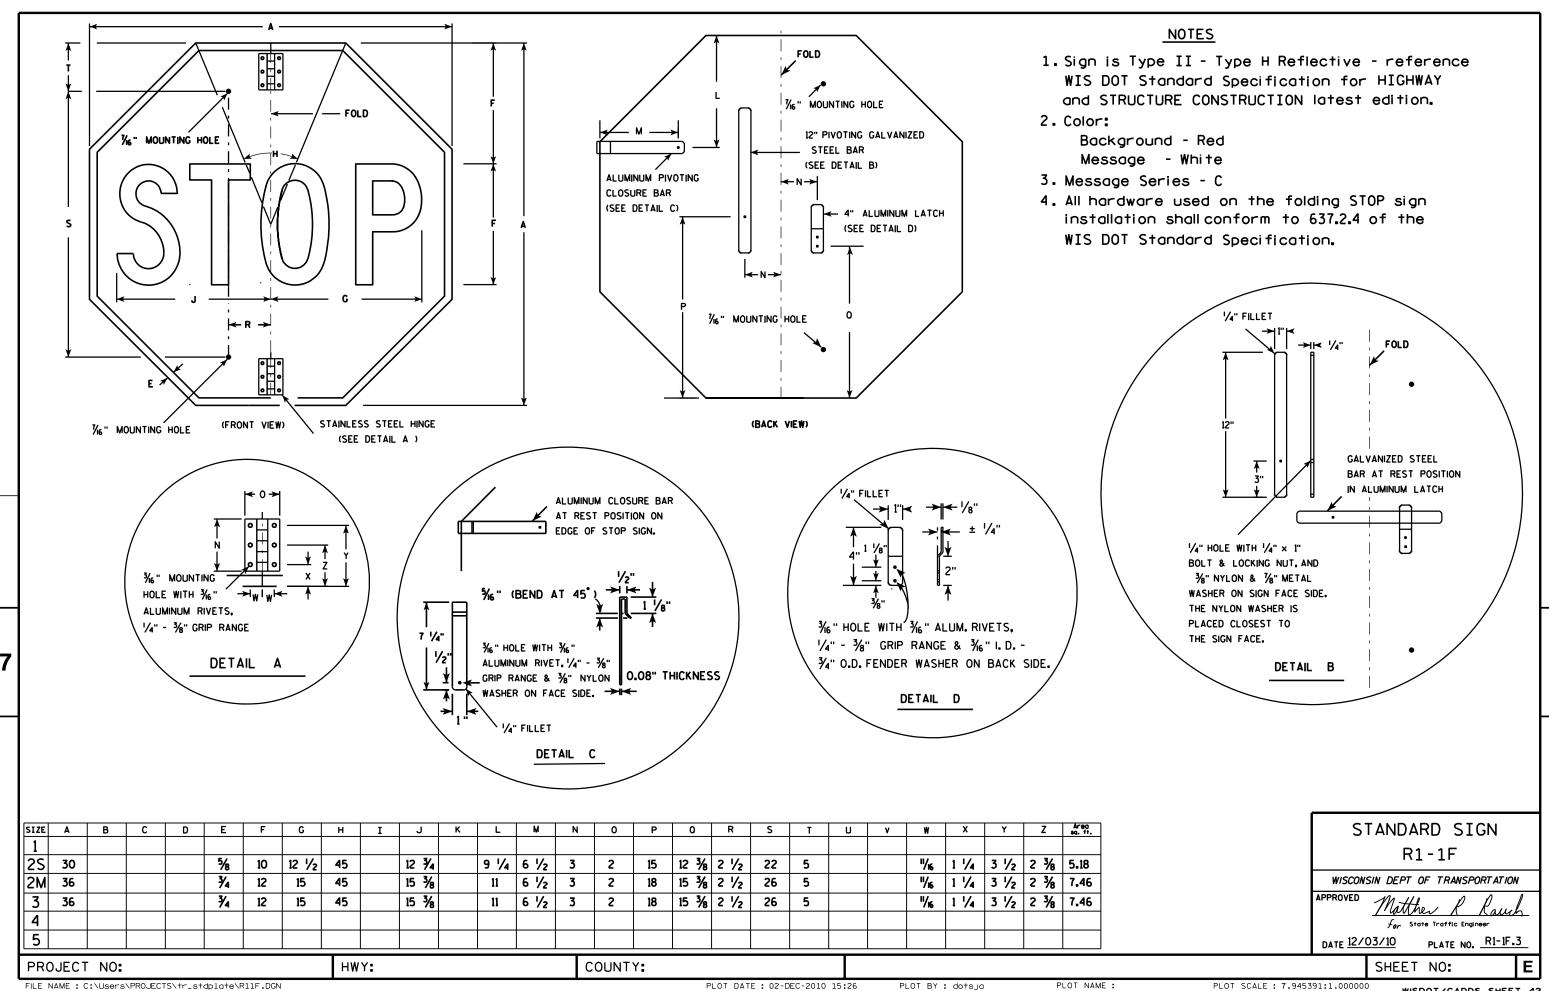

- 1. Sign is Type II Type H Reflective
- 2. Color:

Background - White Message – Black

- 3. Message Series E
- 4. Substitute appropriate numerals and optically adjust spacing to achieve proper balance.

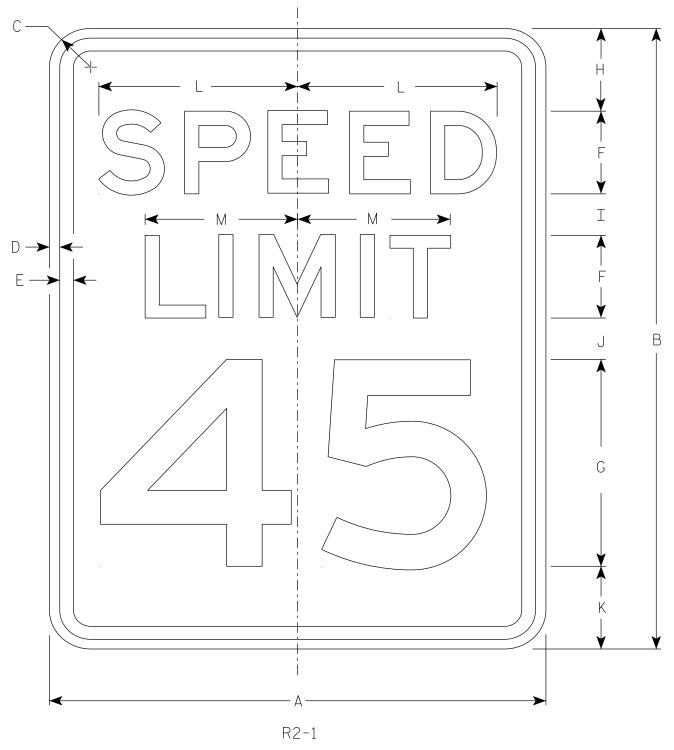

SIZE	А	В	С	D	E	F	G	Н	I	J	K	L	М	N	0	Р	Q	R	S	Т	U	٧	W	X	Y	Z	Area sq. ft.
1	18	24	1 1/2	3/8	1/2	3	8	3	2	2	3	7 1/4	5 1/2														3.0
25	24	30	1 1/2	3/8	1/2	4	10	3	2 1/4	3 3/8	3 3/8	9 5/8	7 3/8														5.0
2M	30	36	1 1/8	1/2	5/8	5	12	5	2 1/2	2 1/2	4	12	9 1/4														7.5
3	36	48	1 1/8	1/2	5/8	6	14	6	5	5	6	14 3/8	11														12.0
4	36	48	1 1/8	1/2	5/8	6	14	6	5	5	6	14 3/8	11														12.0
5	48	60	3	3/4	1	8	20	6	4 1/2	6 3/4	6 3/4	19 1/4	14 5/8														20.0

COUNTY:

STANDARD SIGN R2-1

WISCONSIN DEPT OF TRANSPORTATION

SHEET NO:

APPROVED

DATE 2/1/23

For State Traffic Engineer PLATE NO. R2-1.14


HWY:

PROJECT NO:

PLOT DATE: 9-JULY 2024 1:47

PLOT BY : mscj9h


PLOT NAME :

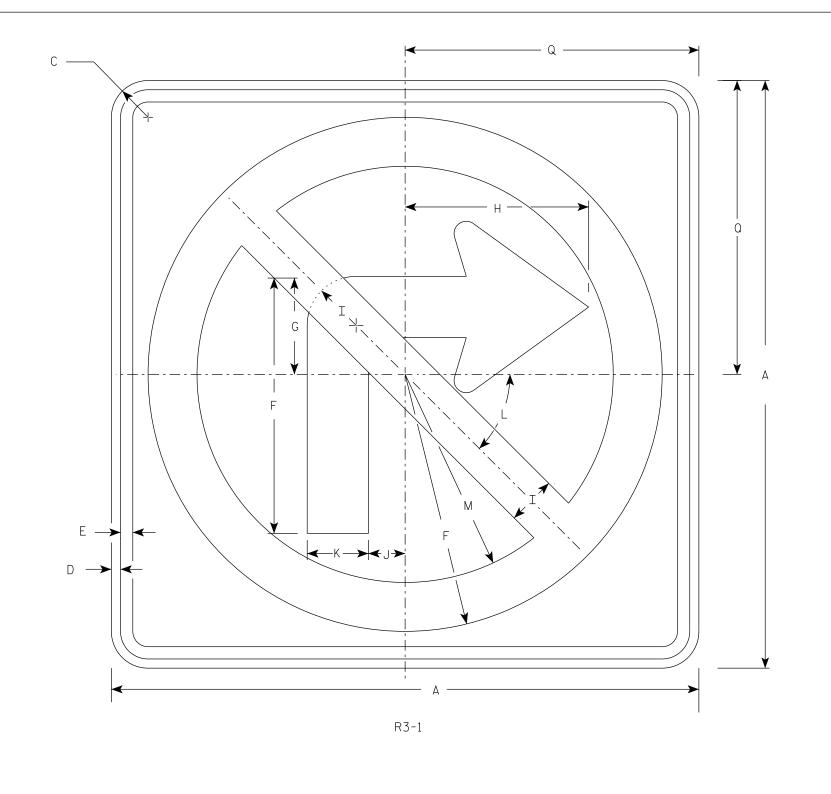

- 1. Sign is Type II Type H Reflective
- 2. Color:

Background - White Message - See note 3

3. Border & Arrow are non reflective black, the circle with diagonal bar is reflective red.

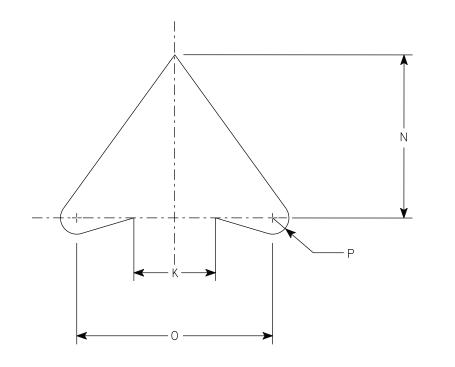

ARROW DETAIL

SIZE	Α	В	С	D	E	F	G	Н	I	J	K	L	M N	0	Р	Q	R	S	Т	U	٧	W	X	Υ	Z	Area sq. ft.
1	24		1 1/2	3/8	1/2	10 1/2	4	7 1/2	2	1 1/2	2 1/2	45	8 1/2 5	6	1/2	12										4.0
25	24		1 1/2	3/8	1/2	10 1/2	4	7 1/2	2	1 1/2	2 1/2	45 °	8 1/2 5	6	1/2	12										4.0
2M	36		2 1/4	5/8	3/4	15 3/4	6	11 1/4	3	2 1/4	3 3/4	45	12 3/4 7 1/2	9	3/4	18										9.0
3	36		2 1/4	5/8	3/4	15 3/4	6	11 1/4	3	2 1/4	3 3/4	45	12 3/4 7 1/2	9	3/4	18										9.0
4	36		2 1/4	5/8	3/4	15 3/4	6	11 1/4	3	2 1/4	3 3/4	45°	12 3/4 7 1/2	9	3/4	18										9.0
5	48		2 1/4	3/4	1	21	8	15	4	3	5	45°	17 10	12	1	24										16.0

COUNTY:

STANDARD SIGN R3-1

WISCONSIN DEPT OF TRANSPORTATION

SHEET NO:

PPROVED

Matthew R Laure

For State Traffic Engineer

DATE 2/2/23 PLATE NO. R3-1.6

FILE NAME : C:\CAEfiles\Projects\tr-stdplate\R31.dgn

HWY:

PROJECT NO:

PLOT DATE: 9-JULY 2024 1:51

PLOT BY : mscj9h

PLOT NAME :




- 1. Sign is Type II Type H Reflective
- 2. Color:

Background - White

Message - See note 3

3. Border & Arrow are non reflective black, the circle with diagonal bar is reflective red.

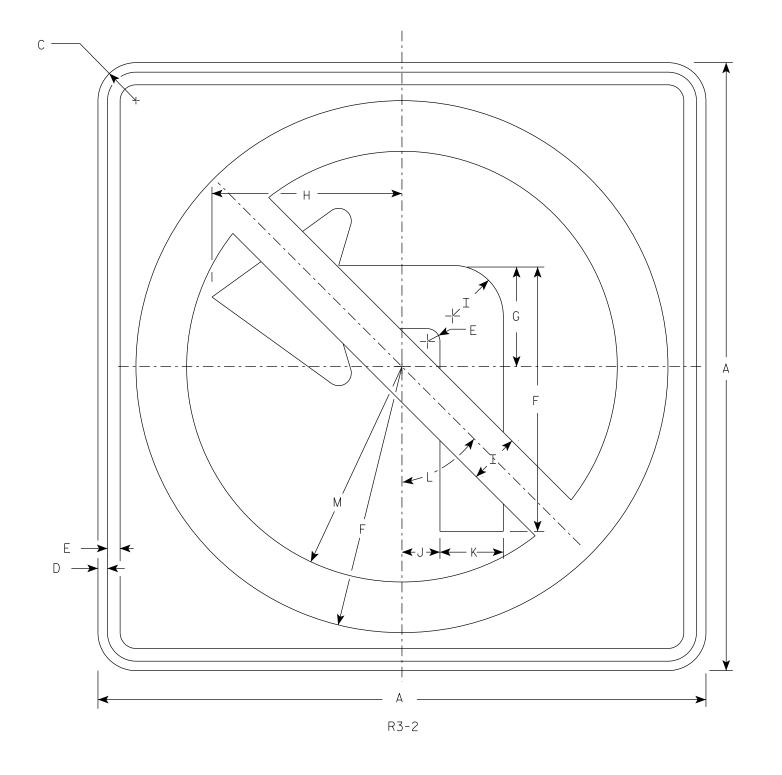

N N N N

ARROW DETAIL

SIZE	Α	В	С	D	E	F	G	Н	I	J	K	L	М	N	0	Р	Q	R	S	Т	U	٧	W	Х	Y	Z	Area sq. ft.
1	24		1 1/2	3/8	1/2	10 1/2	4	7 1/2	2	1 1/2	2 1/2	45°	8 1/2	5	6	1/2											4.0
25	24		1 1/2	3/8	1/2	10 1/2	4	7 1/2	2	1 1/2	2 1/2	45°	8 1/2	5	6	1/2											4.0
2M	36		2 1/4	5/8	3/4	15 ¾	6	11 1/4	3	2 1/4	3 3/4	45°	12 3/4	7 1/2	9	3/4											9.0
3	36		2 1/4	5/8	3/4	15 3/4	6	11 1/4	3	2 1/4	3 3/4	45°	12 3/4	7 1/2	9	3/4											9.0
4	36		2 1/4	5/8	3/4	15 3/4	6	11 1/4	3	2 1/4	3 3/4	45°	12 3/4	7 1/2	9	3/4											9.0
5	48		2 1/4	3/4	1	21	8	15	4	3	5	45°	17	10	12	1											16.0

COUNTY:

STANDARD SIGN R3-2

WISCONSIN DEPT OF TRANSPORTATION

SHEET NO:

APPROVED Matthew & & Forstate Traffic Engineer

DATE <u>2/2/23</u>

PLATE NO. <u>R3-2.11</u>

Ε

FILE NAME : C::CAEfiles\Projects\tr_stdpldate\R32.dgn

PROJECT NO:

HWY:

PLOT DATE: 9-JULY 2024 2:11

PLOT BY: mscj9h

PLOT NAME :

- 1. Sigs are Type II Type H Reflective
- 2. Color:

Background - White Message - Black

- 3. Message Series D
- 4. Use appropriate Letter for Sign Code Each letter added makes sign wider. Example R3-8EAR
- 5. Square footage of sign varies by letters

2 Letters = 7.5 sq ft for Size 2

12.0 sq ft for Size 3

20.0 sq ft for Size 4 or 5

3 Letters = 11.25 sq ft for Size 2

18.0 sq ft for Size 3

30.0 sq ft for Size 4 or 5

4 Letters = 15.0 sq ft for Size 2

24.0 sa ft for Size 3

40.0 sq ft for Size 4 or 5

5 Letters = 18.75 sq ft for Size 2

30.0 sa ft for Size 3

50.0 sq ft for Size 4 or 5

6 Letters = 22.5 sq ft for Size 2

36.0 sq ft for Size 3

60.0 sq ft for Size 4 or 5

6. When letters C,D,G,J are used on the Left or Right end of the sign the Sq. Ft. changes.

Add the amounts when these letters are used:

1.25 sq ft for Size 2 1.5 sa ft for Size 3

2.0 sq ft for Size 4 or 5

STANDARD SIGN R3-8 Series

WISCONSIN DEPT OF TRANSPORTATION

APPROVED Matther State Traffic Engineer


DATE 2/14/23 PLATE NO. R3-8.2


SHEET NO:










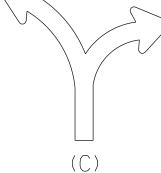


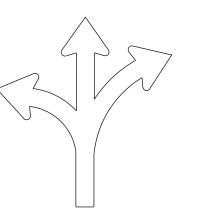

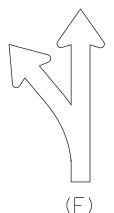

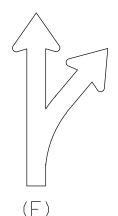


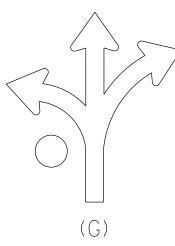


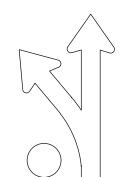

(H)


FILE NAME : C:\CAEfiles\Projects\stdplate_R38.dgn

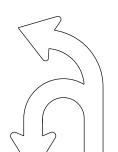


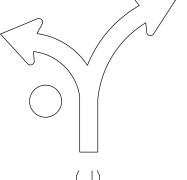





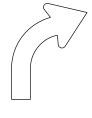

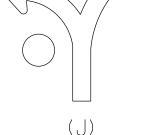


PROJECT NO:

Ε


- 1. Sign is Type II Type H Reflective
- 2. Color:


Background - White Message - Black


3. Message Series - D

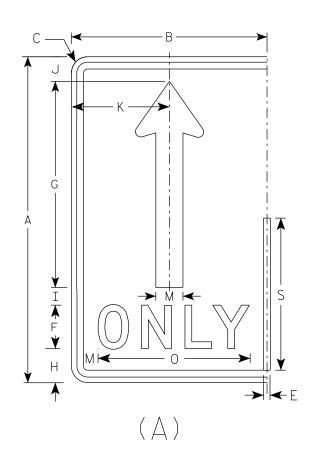

HWY:

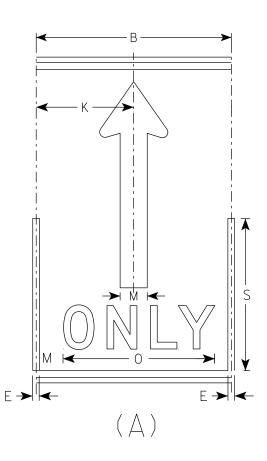

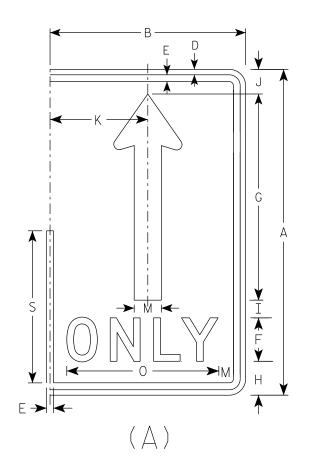

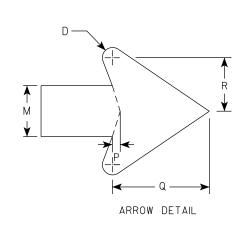

SIZE	А	В	С	D	E	F	G	П	I	J	K	L M	Ν	0	Р	Q	R	S	Т	U	٧	W	X	Y	Z	Area sq. ft.
1																										
25	30	18	1 1/2	1/2	5/8	4	19	3 1/8	1	2 1/4	9	2 1/2		14	3/8	4 3/4	2 5/8	14								3.75
2M	30	18	1 1/2	1/2	5/8	4	19	3 1/8	1 5/8	2 1/4	9	2 1/2		14	3/8	4 3/4	2 5/8	14								3.75
3	36	24	1 1/2	1/2	5/8	5	22 ¾	3 3/4	1 3/4	2 3/4	12	3		17 5/8	1/2	5 3/4	3 1/8	16 3/4								6.0
4	48	30	2 1/4	3/4	1	6	30 3/8	5 1/8	2 1/8	3 %	15	4		21 3/4	5/8	7 %	4 1/4	22 3/8								10.0
5	48	30	2 1/4	3/4	1	6	30 3/8	5 1/8	2 1/8	3 %	15	4		21 3/4	5/8	7 %	4 1/4	22 3/8								10.0

STANDARD SIGN R3-8 (A) Arrow

WISCONSIN DEPT OF TRANSPORTATION

SHEET NO:

DATE <u>2/14/23</u>

PLATE NO. <u>R3-8.2</u>

Ε

PROJECT NO:

COUNTY:

PLOT DATE: 14-FEB 2023 3:04

PLOT BY : mscj9h


PLOT NAME :


PLOT SCALE: \$\$.....plotscale.....\$\$ WISDOT/CADDS SHEET 42

FILE NAME: C:\CAEfiles\Projects\stdplate_R38.dgn

- 1. Sign is Type II Type H Reflective
- 2. Color:

Background - White Message – Black Message Series - D

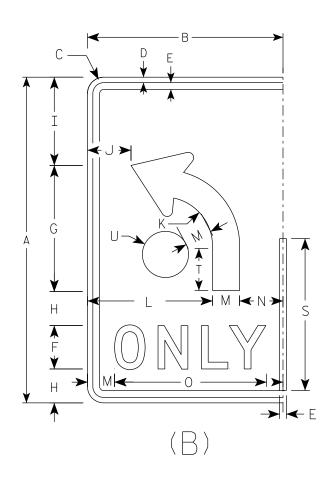

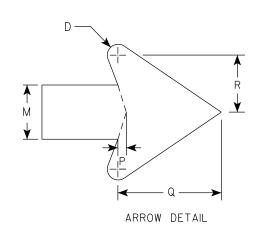

SIZ	E A	А	В	С	D	E	F	G	Н	I	J	K	L	М	Ν	0	Р	Q	R	S	Т	U	٧	W	X	Υ	Z	Area sq. ft.
1																												
25	3	30	18	1 1/2	1/2	5/8	4	11 5/8	3 1/8	8 1/8	4	4 1/2	11 1/2	2 1/2	4	14	3/8	4 3/4	2	14	3 1/8	2 1/8						3.75
21	1 3	30	18	1 1/2	1/2	5/8	4	11 5/8	3 1/8	8 1/8	4	4 1/2	11 1/2	2 1/2	4	14	3/8	4 3/4	2	14	3 1/8	2 1/8						3.75
3	3	36	24	1 1/2	1/2	5/8	5	14	3 1/2	9 3/4	6	5 3/8	15	3	6	17 5/8	1/2	5 3/4	3 1/8	16 3/4	4 5/8	2 1/2						6.0
4	4	48	30	2 1/4	3/4	1	6	18 5/8	5 1/8	13 1/8	6 1/8	7 1/4	18	4	8	21 3/4	5/8	7 5/8	4 1/4	22 3/8	6 1/4	3 3/8						10.0
5	4	48	30	2 1/4	3/4	1	6	18	5 1/8	13 1/8	6 1/8	7 1/4	18	4	8	21 3/4	5/8	7 5/8	4 1/4	22 3/8	6 1/4	3 3/8						10.0

R3-8 (B) Arrow WISCONSIN DEPT OF TRANSPORTATION

STANDARD SIGN

APPROVED Matther f_{or} State Traffic Engineer

DATE <u>2/14/23</u> PLATE NO. <u>R3-8.2</u>

SHEET NO: Ε PLOT BY: mscj9h

FILE NAME : C:\CAEfiles\Projects\stdplate_R38.dgn

PROJECT NO:


PLOT DATE: 14-FEB 2023 3:19


- 1. Sign is Type II Type H Reflective
- 2. Color:


Background - White Message - Black


3. Message Series - None

ENDS MIDDLE

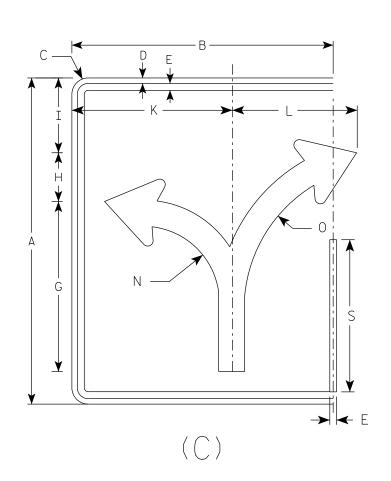

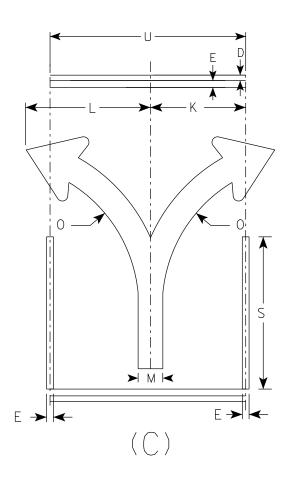

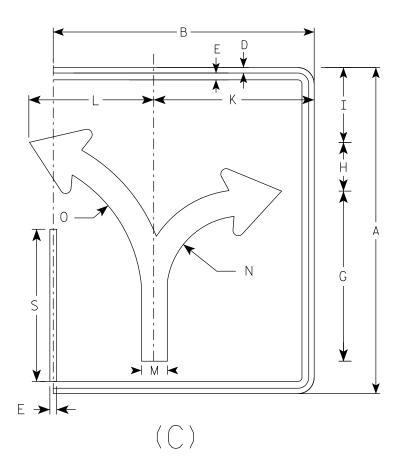

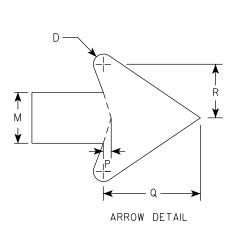

1																										I		
SIZE	А	В	С	D	Е	F	G	Н	I	J	K	L	М	N	0	Р	Q	R	S	Т	U	V	W	X	Y	Z	Area sq. ft.	Area sq. ft.
1																												
25	30	24	1 1/2	1/2	5/8		15 5/8	4 1/2	6 1/8	1	4 3/4	11 1/2	2 3/8	7	13 1/4	3/8	4 1/2	2 1/2	14		18						5.0	3.75
2M	30	24	1 1/2	1/2	5/8		15 5/8	4 1/2	6 1/8	1	14 3/4	11 1/2	2 3/8	7	13 1/4	3/8	4 1/2	2 1/2	14		18						5.0	3.75
3	36	30	1 1/2	1/2	5/8		18 3/4	5 1/2	8 1/4	1	17 1/4	17 1/4	2 1/8	8 3/8	16	1/2	5 1/2	3	16 3/4		24						7 . 5	6.0
4	48	36	2 1/4	3/4	1		24 1/8	7 1/4	11	2	23 1/8	18	3 3/4	11 1/8	21 1/4	5/8	7 1/8	4	22 3/8		30						12.0	10.0
5	48	36	2 1/4	3/4	1		24 1/8	7 1/4	11	2	23 1/8	18	3 3/4	11 1/8	21 1/4	5/8	7 1/8	4	22 3/8		30						12.0	10.0

COUNTY:

STANDARD SIGN R3-8 (C) Arrow

WISCONSIN DEPT OF TRANSPORTATION

 \mathcal{F}_{or} State Traffic Engineer

DATE 2/14/23 PLATE NO. R3-8.2

SHEET NO:

HWY:


PROJECT NO:


- 1. Sign is Type II Type H Reflective
- 2. Color:


Background - White Message - Black


3. Message Series - None

ENDS MIDDLE

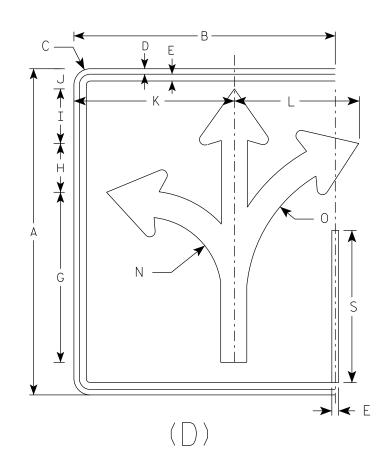

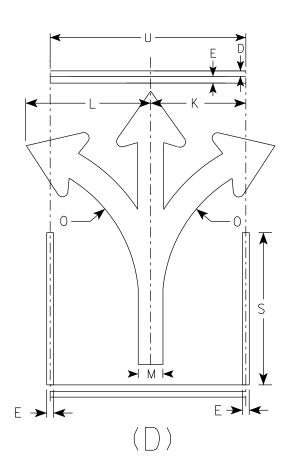

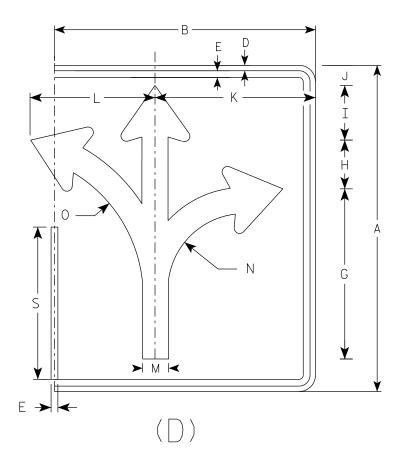

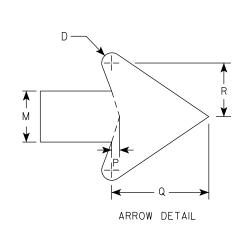

SIZE	Α	В	С	D	Е	F	G	Н	I	J	K	L	М	N	0	Р	Q	R	S	Т	U	٧	W	X	Υ	Z	Area sq. ft.	Area sq. ft.
1																												
25	30	24	1 1/2	1/2	5/8		15 5/8	4 1/2	5	1 1/8	14 3/4	11 1/2	2 3/8	7	13 1/4	3/8	4 1/2	2 1/2	14		18						5.0	3.75
2M	30	24	1 1/2	1/2	5/8		15 %	4 1/2	5	1 1/8	14 ¾	11 1/2	2 3/8	7	13 1/4	3/8	4 1/2	2 1/2	14		18						5.0	3.75
3	36	30	1 1/2	1/2	5/8		18 3/4	5 1/2	6	2 1/4	17 1/4	17 1/4	2 1/8	8 3/8	16	1/2	5 1/2	3	16 3/4		24						7.5	6.0
4	48	36	2 1/4	3/4	1		24 1/8	7 1/4	7 1/8	3 1/8	23 1/8	18	3 3/4	11 1/8	21 1/4	5/8	7 1/8	4	22 3/8		30						12.0	10.0
5	48	36	2 1/4	3/4	1		24 1/8	7 1/4	7 1/8	3 1/8	23 1/8	18	3 3/4	11 1/8	21 1/4	5/8	7 1/8	4	22 3/8		30						12.0	10.0

STANDARD SIGN R3-8 (D) Arrow

WISCONSIN DEPT OF TRANSPORTATION

APPROVED Matthew R Rauch
For State Traffic Engineer

DATE <u>2/14/23</u> PLATE NO. R3-8.2 SHEET NO:

Ε

PROJECT NO:

FILE NAME: C:\CAEfiles\Projects\stdplate_R38.dgn

HWY:

COUNTY: PLOT DATE: 14-FEB 2023 3:20


PLOT BY: mscj9h

PLOT NAME :


- 1. Sign is Type II Type H Reflective
- 2. Color:


Background - White Message – Black

3. Message Series - None

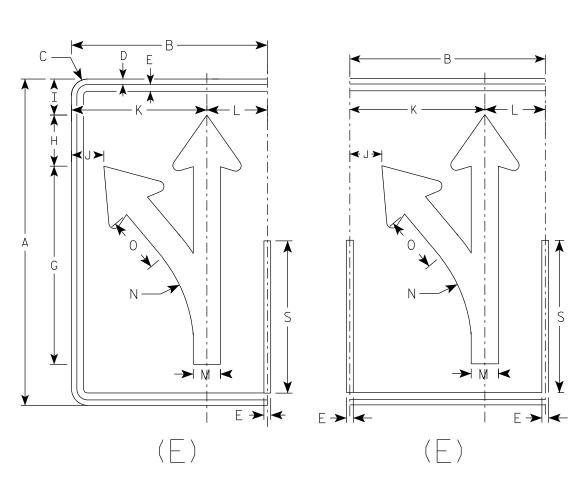

HWY:

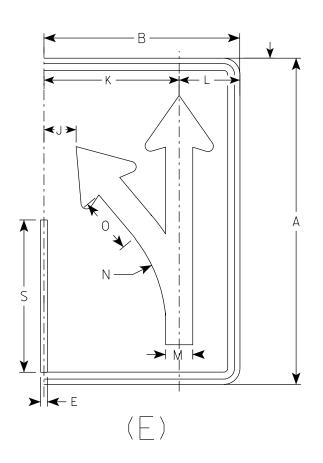

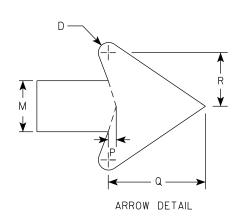

SIZE	Α	В	С	D	E	F	G	Н	I	J	К	L	М	N	0	Р	Q	R	S	Т	U	٧	W	X	Y Z	Area sq. ft.
1																										
25	30	18	1 1/2	1/2	5/8		18 1/4	4 3/4	3 1/4	3	12 1/2	5 1/2	2 1/2	13 1/4	5 1/8	3/8	4 3/4	2 5/8	14							3.75
2M	30	18	1 1/2	1/2	5/8		18 1/4	4 3/4	3 1/4	3	12 1/2	5 1/2	2 1/2	13 1/4	5 1/8	3/8	4 3/4	2 5/8	14							3.75
3	36	24	1 1/2	1/2	5/8		21 7/8	5 %	4	4 1/8	16 1/8	7 3/4	3	15 1/8	6 1/8	1/2	5 3/4	3 1/8	16 3/4							6.0
4	48	30	2 1/4	3/4	1		29 1/8	7 1/2	5 1/4	5 3/8	20 1/2	9 1/2	4	21 1/4	8 1/4	5/8	7 5/8	4 1/4	22 3/8							10.0
5	48	30	2 1/4	3/4	1		29 1/8	7 1/2	5 1/4	5 3/8	20 1/2	9 1/2	4	21 1/4	8 1/4	5/8	7 5/8	4 1/4	22 3/8							10.0

COUNTY:

STANDARD SIGN R3-8 (E) Arrow

WISCONSIN DEPT OF TRANSPORTATION

DATE 2/14/23 PLATE NO. R3-8.2

SHEET NO:

FILE NAME: C:\CAEfiles\Projects\stdplate_R38.dgn

PROJECT NO:


PLOT DATE: 14-FEB 2023 3:07

PLOT BY: mscj9h


- 1. Sign is Type II Type H Reflective
- 2. Color:


Background - White Message - Black


3. Message Series - None

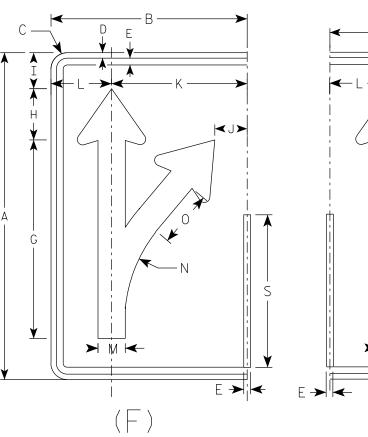

HWY:

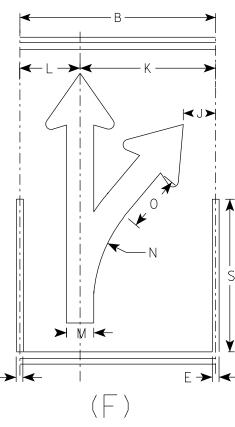

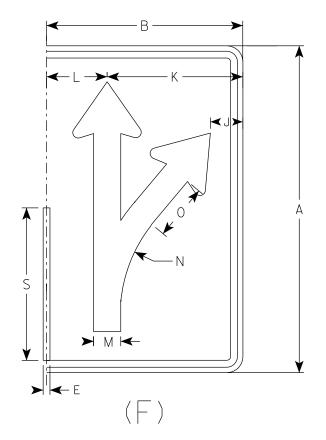

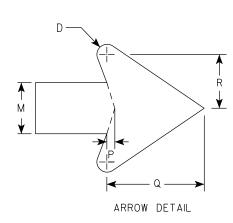

SIZE	А	В	С	D	Е	F	G	Н	I	J	К	L	М	N	0	Р	Q	R	S	Т	U	٧	W	Χ	Y	Z	Area sq. ft.
1																											
25	30	18	1 1/2	1/2	5/8		18 1/4	4 3/4	3 1/4	3	12 1/2	5 1/2	2 1/2	13 1/4	5 1/8	3/8	4 3/4	2 5/8	14								3.75
2M	30	18	1 1/2	1/2	5/8		18 1/4	4 3/4	3 1/4	3	12 1/2	5 1/2	2 1/2	13 1/4	5 1/8	3/8	4 3/4	2 5/8	14								3.75
3	36	24	1 1/2	1/2	5/8		21 1/8				16 1/8			15 1/8	6 1/8	1/2	5 3/4	3 1/8	16 3/4								6.0
4	48	30	2 1/4	3/4	1		29 1/8	7 1/2	5 1/4	5 3/8	20 1/2	9 1/2	4	21 1/4					22 3/8								10.0
5	48	30	2 1/4	3/4	1		29 1/8	7 1/2	5 1/4	5 3/8	20 1/2	9 1/2	4	21 1/4	8 1/4	5/8	7 %	4 1/4	22 3/8								10.0

COUNTY:

STANDARD SIGN R3-8 (F) Arrow

WISCONSIN DEPT OF TRANSPORTATION

APPROVED Matthew R Raw

For State Traffic Engineer

DATE 2/14/23 PLATE NO. R3-8.2

SHEET NO: **E**

FILE NAME : C:\CAEfiles\Projects\stdplate_R38.dgn

PROJECT NO:

PLOT DATE: 14-FEB 2023 3:15


PLOT BY: mscj9h


PLOT NAME :

- 1. Sign is Type II Type H Reflective
- 2. Color:

Background - White Message - Black

3. Message Series - None

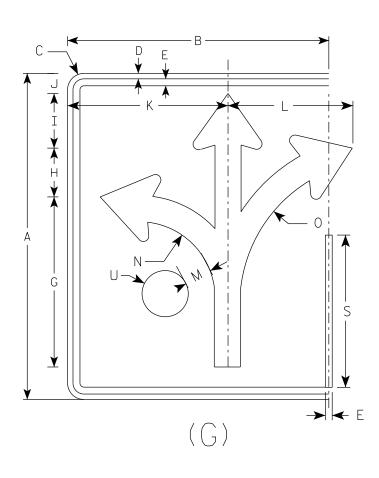

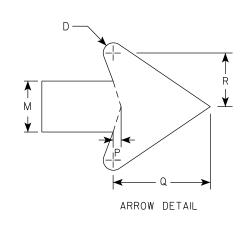

SIZE	Α	В	С	D	E	F	G	Н	I	J	K	L	М	N	0	Р	Q	R	S	T U	V	W	X	Y	Z	Area sq. ft.
1																										
25	30	24	1 1/2	1/2	5/8		15 5/8	4 1/2	5	1 1/8	14 3/4	11 1/2	2 3/8	7	13 1/4	3/8	4 1/2	2 1/2	14	2 !	8					5.0
2M	30	24	1 1/2	1/2	5/8		15 %	4 1/2	5	1 1/8	14 3/4	11 1/2	2 3/8	7	13 1/4	3/8	4 1/2	2 1/2	14	2 !	, 8					5.0
3	36	30	1 1/2	1/2	5/8		18 3/4	5 1/2	6	3 1/8	17 1/4	17 1/4	2 1/8	8 3/8	16	1/2	5 1/2	3	16 3/4	2 1/	2					7.5
4	48	36	2 1/4	3/4	1		24 1/8	7 1/4	7 1/8	3 1/8	23 1/8	18	3 3/4	11 1/8	21 1/4	5/8	7 1/8	4	22 3/8	3 3	8					12.0
5	48	36	2 1/4	3/4	1		24 1/8	7 1/4	7 1/8	3 1/8	23 1/8	18	3 3/4	11 1/8	21 1/4	5/8	7 1/8	4	22 3/8	3 3	8					12.0

STANDARD SIGN R3-8 (G) Arrow

WISCONSIN DEPT OF TRANSPORTATION

APPROVED Matther For State Traffic Engineer

DATE 2/14/23 PLATE NO. R3-8.2 SHEET NO:

PROJECT NO: FILE NAME : C:\CAEfiles\Projects\stdplate_R38.dgn HWY:

COUNTY:

PLOT DATE: 14-FEB 2023 3:21


PLOT NAME :


PLOT BY: mscj9h

- 1. Sign is Type II Type H Reflective
- 2. Color:

Background - White Message – Black

3. Message Series - None

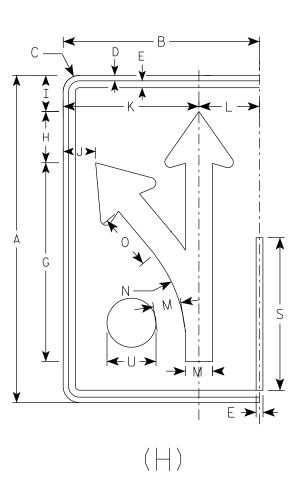

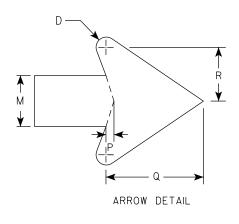

SIZE	Α	В	С	D	E	F	G	Н	I	J	K	L	М	N	0	Р	Q	R	S	Т	U	V	W	Χ	Y	Z	Area sq. ft.
1																											
25	30	18	1 1/2	1/2	5/8		18 1/4	4 3/4	3 1/4	3	12 1/2	5 1/2	2 1/2	13 1/4	5 1/8	3/8	4 3/4	2 5/8	14		2 1/8						3.75
2M	30	18	1 1/2	1/2	5/8		18 1/4	4 3/4	3 1/4	3	12 1/2	5 1/2	2 1/2	13 1/4	5 1/8	3/8	4 3/4	2 5/8	14		2 1/8						3.75
3	36	24	1 1/2	1/2	5/8		21 1/8	5 %	4	4 1/8	16 1/8	7 3/4	3	15 1/8	6 1/8	1/2	5 3/4	3 1/8	16 3/4		2 1/2						6.0
4	48	30	2 1/4	3/4	1		29 1/8	7 1/2	5 1/4	5 3/8	20 1/2	9 1/2	4	21 1/4	8 1/4	5/8	7 5/8		22 3/8		3 3/8						10.0
5	48	30	2 1/4	3/4	1		29 1/8	7 1/2	5 1/4	5 3/8	20 1/2	9 1/2	4	21 1/4	8 1/4	5/8	7 5/8	4 1/4	22 3/8		3 3/8						10.0

STANDARD SIGN R3-8 (H) Arrow WISCONSIN DEPT OF TRANSPORTATION

 f_{or} State Traffic Engineer


DATE 2/14/23 PLATE NO. R3-8.2


PROJECT NO: HWY: COUNTY: SHEET NO:

- 1. Sign is Type II Type H Reflective
- 2. Color:

Background - White Message - Black

3. Message Series - None

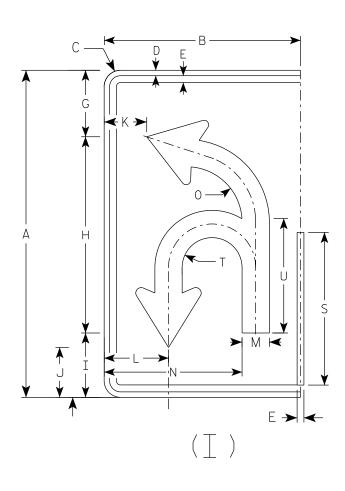

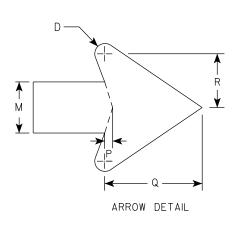

SIZE	А	В	С	D	E	F	G	Н	I	J	К	L	М	N	0	Р	Q	R	S	Т	U	V	W	X	Y	Z	Area sq. ft.
1																											
25	30	18	1 1/2	1/2	5/8		6 1/8	18	5 %	4 5/8	3 1/8	5 %	2 1/2	12 5/8	5 1/8	3/8	4 3/4	2	14	2 3/4	10 1/2						3.75
2M	30	18	1 1/2	1/2	5/8		6 1/8	18	5 1/8	4 5/8	3 1/8	5 %	2 1/2	12 5/8	5 1/8	3/8	4 3/4	2 5/8	14	2 3/4	10 1/2						3.75
3	36	24	1 1/2	1/2	5/8		21 1/8	21 5/8	7 1/8	5 1/2	5 %	8 1/4	3	16 3/8	6 1/8	1/2	5 3/4	3 1/8	16 3/4	3 1/4	12 5/8						6.0
4	48	30	2 1/4	3/4	1		29 1/8	28 ¾	9 3/8	7 1/4	6 1/8	10	4	20 1/8	8 1/8	5/8	7 5/8	4 1/4	22 3/8	4 3/8	16 3/4						10.0
5	48	30	2 1/4	3/4	1		29 1/8	28 3/4	9 3/8	7 1/4	6 1/8	10	4	20 1/8	8 1/8	5/8	7 5/8	4 1/4	22 3/8	4 3/8	16 3/4				·	·	10.0

STANDARD SIGN R3-8 (I) Arrow

WISCONSIN DEPT OF TRANSPORTATION

APPROVED Matther f_{or} State Traffic Engineer

DATE 2/14/23 PLATE NO. R3-8.2

SHEET NO:

Ε

FILE NAME : C:\CAEfiles\Projects\stdplate_R38.dgn

PROJECT NO:

HWY:

COUNTY: PLOT DATE: 14-FEB 2023 3:16


PLOT BY: mscj9h


PLOT NAME :

- 1. Sign is Type II Type H Reflective
- 2. Color:

Background - White Message - Black

3. Message Series - None

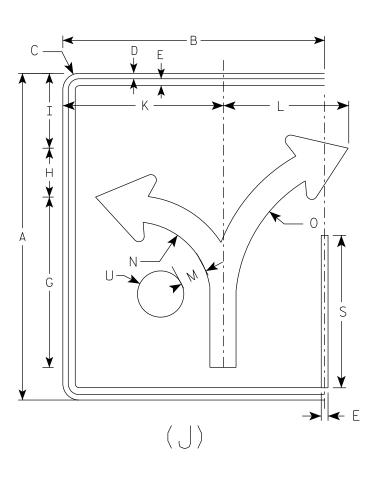

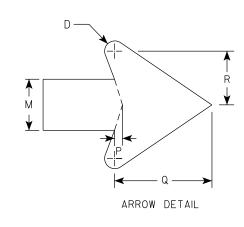

SIZ	E ,	Α	В	С	D	E	F	G	Н	I	J	K	L	М	N	0	Р	Q	R	S	Т	U	٧	W	X	Y	Z	area sq. ft.
1																												
25	5	30	24	1 1/2	1/2	5/8		15 %	4 1/2	6 %		14 3/4	11 1/2	2 3/8	7	13 1/4	3/8	4 1/2	2 1/2	14		2 1/8						5.0
21	1 3	30	24	1 1/2	1/2	5/8		15 %	4 1/2	6 %		14 3/4	11 1/2	2 3/8	7	13 1/4	3/8	4 1/2	2 1/2	14		2 1/8						5.0
3	100	36	30	1 1/2	1/2	5/8		18 3/4	5 1/2	8 1/4		17 1/4	17 1/4	2 1/8	8 3/8	16	1/2	5 1/2	3	16 3/4		2 1/2						7.5
4		48	36	2 1/4	3/4	1		24 1/8	7 1/4	11		23 1/8	18	3 3/4	11 1/8	21 1/4	5/8	7 1/8	4	22 3/8		3 3/8						12.0
5		48	36	2 1/4	3/4	1		24 1/8	7 1/4	11		23 1/8	18	3 3/4	11 1/8	21 1/4	5/8	7 1/8	4	22 3/8	·	3 3/8					·	12.0

COUNTY:

STANDARD SIGN R3-8 (J) Arrow

WISCONSIN DEPT OF TRANSPORTATION

APPROVED Matther f_{or} State Traffic Engineer

DATE 2/14/23 PLATE NO. R3-8.2

SHEET NO:

FILE NAME : C:\CAEfiles\Projects\stdplate_R38.dgn

HWY:

PROJECT NO:

PLOT DATE: 14-FEB 2023 3:18


PLOT BY : mscj9h


PLOT NAME :

- 1. Sign is Type II Type H Reflective
- 2. Color:

Background - White Message - Black

3. Message Series - D

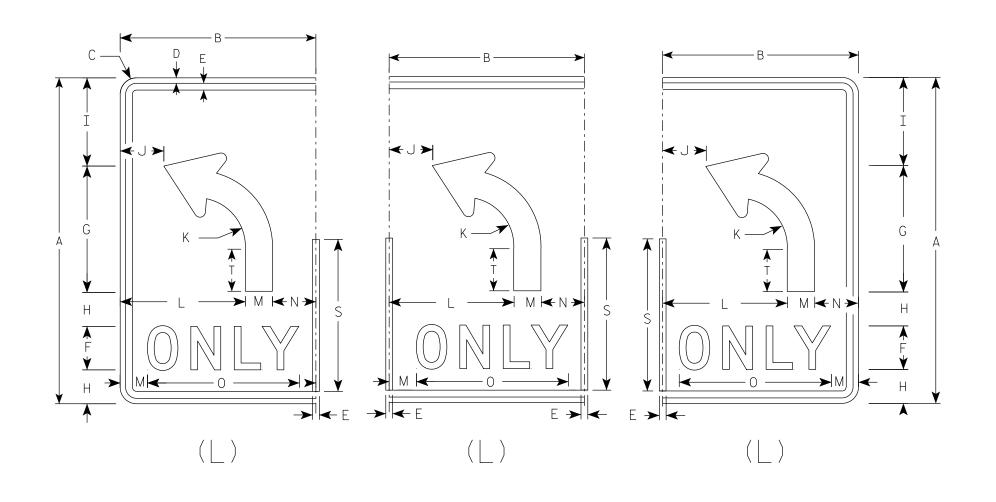

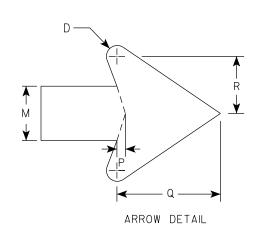

SIZE	Α	В	С	D	E	F	G	Н	I	J	K	L	М	Ν	0	Р	0	R	S	Т	C	٧	W	X	Υ	Z	Area sq. ft.
1																											
25	30	18	1 1/2	1/2	5/8	4	11 5/8	3 1/8	8 1/8	4	4 1/2	11 1/2	2 1/2	4	14	3/8	4 3/4	2 5/8	14	3 1/8							3.75
2M	30	18	1 1/2	1/2	5/8	4	11 5/8	3 1/8	8 1/8	4	4 1/2	11 1/2	2 1/2	4	14	3/8	4 3/4	2	14	3 1/8							3.75
3	36	24	1 1/2	1/2	5/8	5	14	3 1/2	9 3/4	6	5 3/8	15	3	6	17 5/8	1/2	5 3/4	3 1/8	16 ¾	4 5/8							6.0
4	48	30	2 1/4	3/4	1	6	18	5 1/8	13 1/8	6 1/8	7 1/4	18	4	8	21 3/4	5/8	7 5/8	4 1/4	22 3/8	6 1/4							10.0
5	48	30	2 1/4	3/4	1	6	18 5/8	5 1/8	13 1/8	6 1/8	7 1/4	18	4	8	21 3/4	5/8	7 5/8	4 1/4	22 3/8	6 1/4							10.0

STANDARD SIGN R3-8 (L) Arrow

WISCONSIN DEPT OF TRANSPORTATION

PPROVED Matthew & Rauch
For State Traffic Engineer

DATE 2/14/23 PLATE NO. R3-8.2

SHEET NO:

WISDOT/CADDS SHEET 42


PLOT DATE: 14-FEB 2023 3:02 PLOT BY: mscj9h PLOT NAME:


PROJECT NO:


- 1. Sign is Type II Type H Reflective
- 2. Color:

Background - White Message - Black

3. Message Series - D

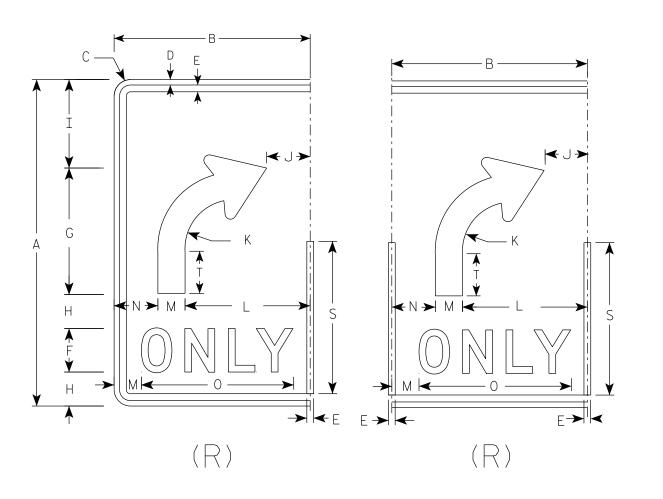

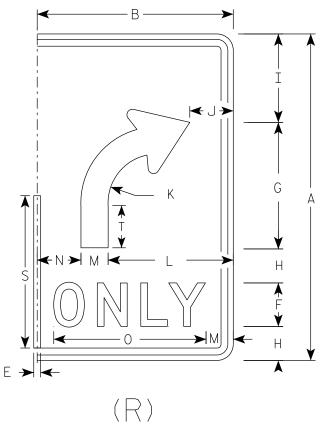

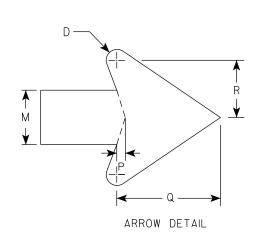

SIZE	А	В	С	D	E	F	G	Н	I	J	К	L	М	N	0	Р	Q	R	S	Т	U	٧	W	X	Y	Z	Area sq. ft.
1																											
25	30	18	1 1/2	1/2	5/8	4	11 5/8	3 1/8	8 1/8	4	4 1/2	11 1/2	2 1/2	4	14	3/8	4 3/4	2	14	3 1/8							3.75
2M	30	18	1 1/2	1/2	5/8	4	11 5/8	3 1/8	8 1/8	4	4 1/2	11 1/2	2 1/2	4	14	3/8	4 3/4	2	14	3 1/8							3.75
3	36	24	1 1/2	1/2	5/8	5	14	3 1/2	9 3/4	6	5 3/8	15	3	6	17 5/8	1/2	5 3/4	3 1/8	16 3/4	4 5/8							6.0
4	48	30	2 1/4	3/4	1	6	18 5/8	5 1/8	13 1/8	6 1/8	7 1/4	18	4	8	21 3/4	5/8	7 5/8	4 1/4	22 3/8	6 1/4							10.0
5	48	30	2 1/4	3/4	1	6	18 5/8	5 1/8	13 1/8	6 1/8	7 1/4	18	4	8	21 3/4	5/8	7 5/8	4 1/4	22 3/8	6 1/4							10.0

STANDARD SIGN R3-8 (R) Arrow

WISCONSIN DEPT OF TRANSPORTATION

APPROVED Matthew R Ra

For State Traffic Engineer

DATE 2/14/23 PLATE NO. R3-8.2


SHEET NO: E

PROJECT NO:
FILE NAME: C:\CAEfiles\Projects\stdplate_R38.dgn

PLOT DATE: 14-FEB 2023 3:03

PLOT BY: mscj9h

PLOT NAME :

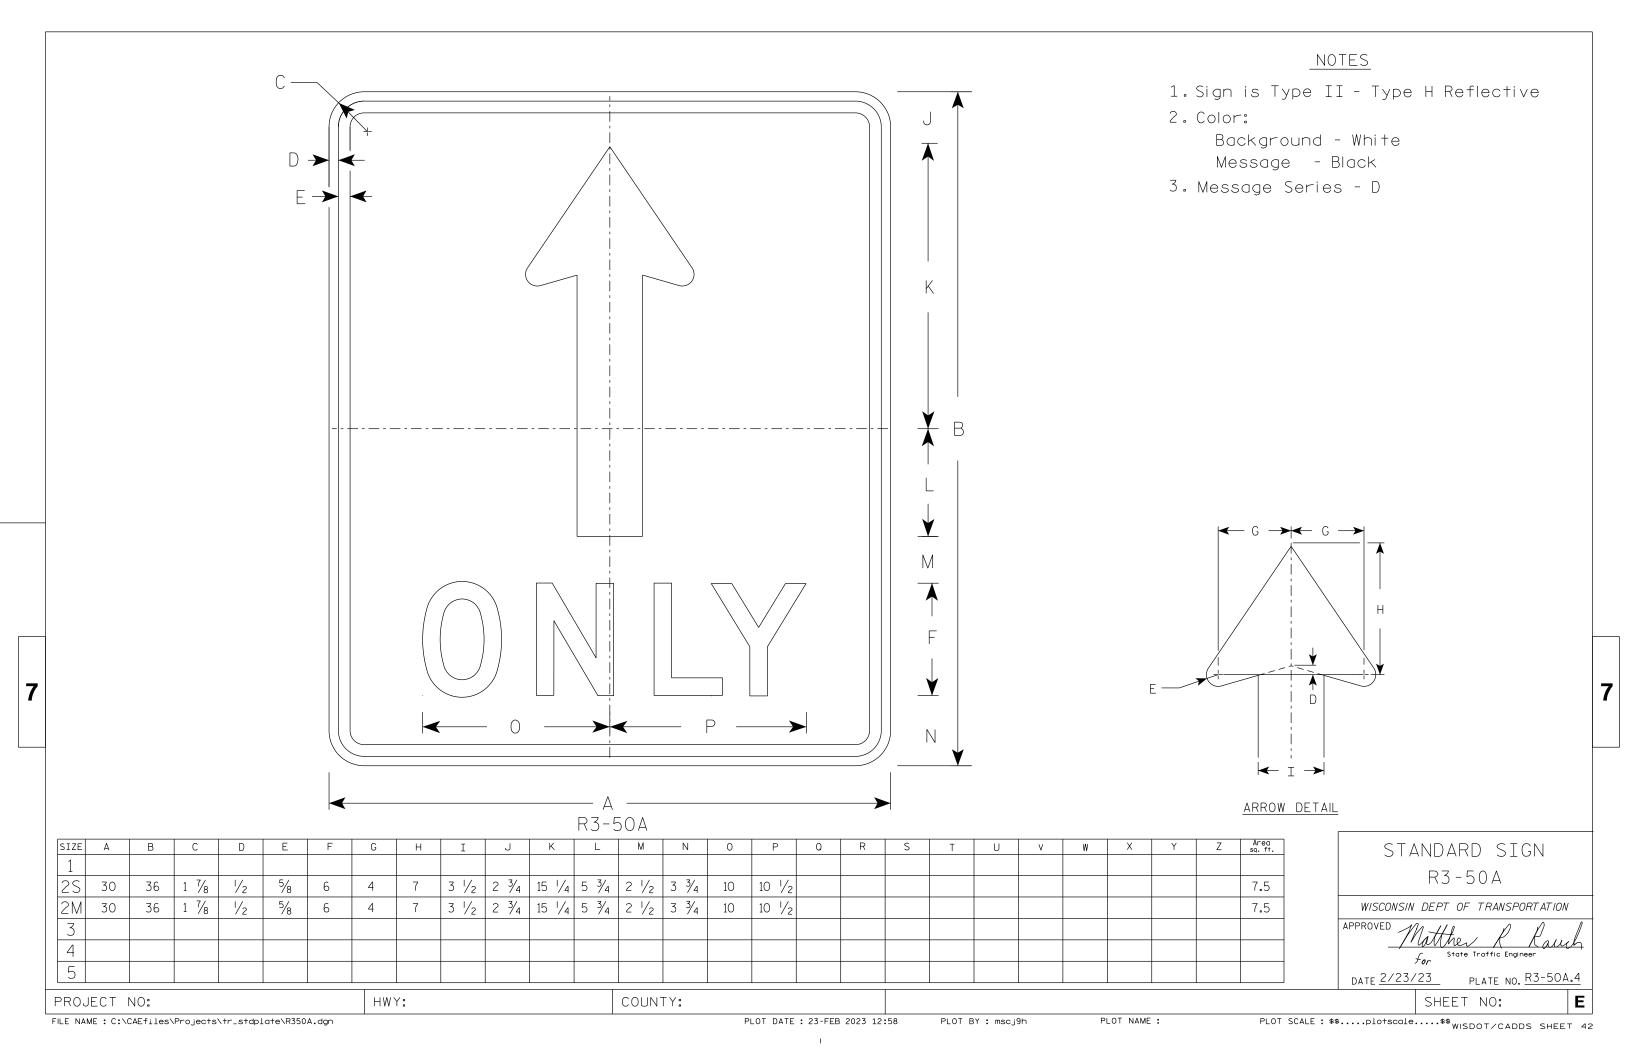



- 1. Sign is Type II Type H Reflective
- 2. Color:

Background - White Message – Black


3. R4-8 is the same as R4-7 except Legend is reversed.

DIVIDER DETAIL

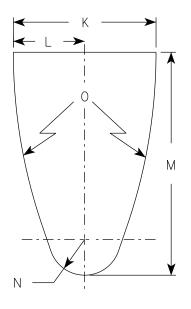

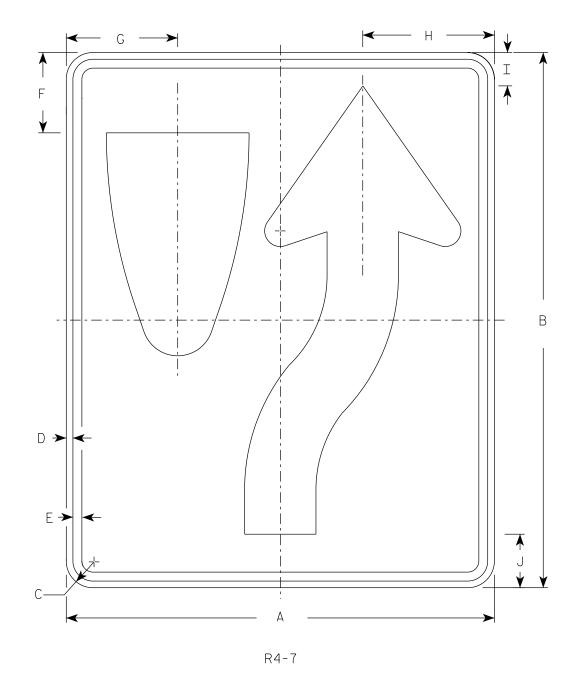

ARROW DETAIL

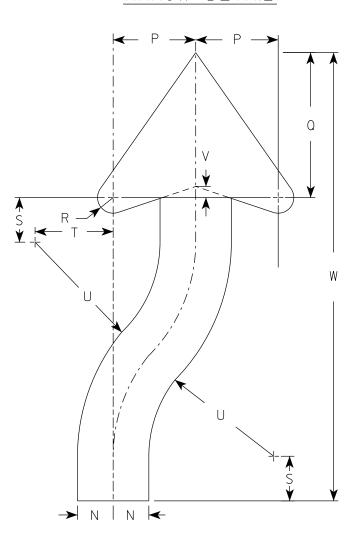

SIZE	Α	В	С	D	Е	F	G	Н	I	J	K	L	М	N	0	Р	Q	R	S	Т	U	٧	W	Х	Y	Z	Area sq. ft.
1	18	24	1 1/2	3/8	1/2	3 3/8	4 3/4	5 1/2	1 3/8	2 1/4	6	3	9 3/8	1 1/2	22 1/2	3 1/2	6 1/8	5/8	1 1/8	3 1/4	6 3/4	1/2	20 3/8				3.0
25	24	30	1 1/2	3/8	1/2	4 1/2	6 1/4	7 3/8	1 1/8	3	8	4	12 1/2	2	30	4 5/8	8 1/8	7∕8	2 1/2	4 3/8	9	5/8	25 1/8				5.0
2M	24	30	1 1/2	3/8	1/2	4 1/2	6 1/4	7 3/8	1 1/8	3	8	4	12 1/2	2	30	4 5/8	8 1/8	7∕ ₈	2 1/2	4 3/8	9	5/8	25 1/8				5.0
3	36	48	1 1/8	1/2	5/8	6 3/4	9 3/8	11 1/8	2 1/8	4 1/2	12	6	18 3/4	3	45	6 1/8	12 1/4	1 1/4	3 3/4	6	13 1/2	1	40 3/4				12.0
4	36	48	1 1/8	1/2	5/8	6 3/4	9 3/8	11 1/8	2 1/8	4 1/2	12	6	18 3/4	3	45	6 1/8	12 1/4	1 1/4	3 3/4	6	13 1/2	1	40 3/4				12.0
5	48	60	3	3/4	1	9	12 1/2	14 3/4	3 3/4	6	16	8	25	4	60	9 1/4	16 1/4	1	5	8 3/4	18	1 1/4	50 1/4				20.0

STANDARD SIGN R4-7 & R4-8

WISCONSIN DEPT OF TRANSPORTATION

APPROVED

For State Traffic Engineer DATE 8/17/23 PLATE NO. R4-7.9

SHEET NO:

FILE NAME : C:\CAEfiles\Projects\tr_stdplate\R47.dgn

HWY:

PROJECT NO:

COUNTY:

PLOT DATE: 17-AUG 2023 12:39


PLOT BY : mscj9h

PLOT NAME :

- 1. Sign is Type II Type H Reflective
- 2. Color:

Background - See detail Message - White

3. Message Series - D

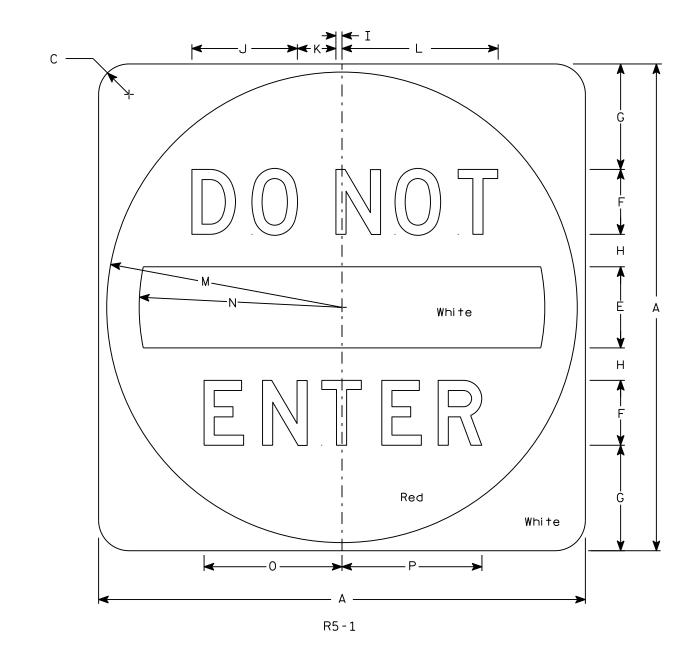

SIZE	Α	В	С	D	E	F	G	Н	I	J	К	L	М	N	0	Р	Q	R	S	Т	U	٧	W	Х	Υ	Z	Area sq. ft.
1																											
25	30		1 1/8		5	4	6 1/2	2	3/8	6 1/2	2 3/8	9 %	14 1/2	12 1/2	8 1/2	8 %											6.25
2M	36		2 1/4		6	5	7 1/2	2 1/2	1/2	8 1/8	3	12 1/8	17 1/2	15	10 %	10 3/4											9.0
3	36		2 1/4		6	5	7 1/2	2 1/2	1/2	8 1/8	3	12 1/8	17 1/2	15	10 %	10 3/4											9.0
4	36		2 1/4		6	5	7 1/2	2 1/2	1/2	8 1/8	3	12 1/8	17 1/2	15	10 %	10 ¾											9.0
5	48		3		8	6	11	3	5/8	9 3/4	3 5/8	14 1/2	23 1/2	20	12 3/4	12 1/8											16.0

COUNTY:

STANDARD SIGN R5-1

WISCONSIN DEPT OF TRANSPORTATION

APPROVED

Matther & Rauch


DATE <u>3/15/18</u>

8 PLATE NO. R5-1.16
SHEET NO:

PLOT SCALE : 5.914594:1.000000

HWY:

PROJECT NO:

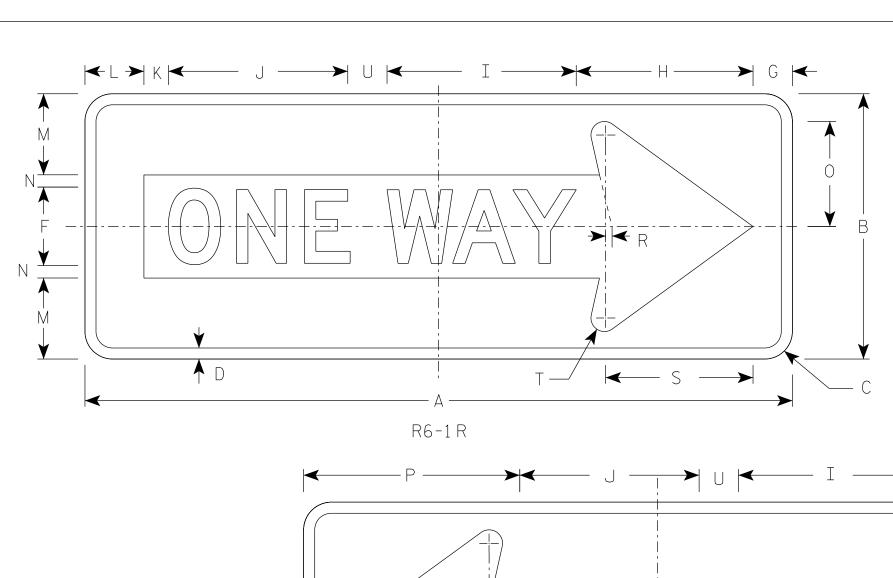


- 1. Sign is Type II Type H Reflective
- 2. Color:

Background - Black

Message - Black Legend & White Arrow & Border

3. Message Series - D

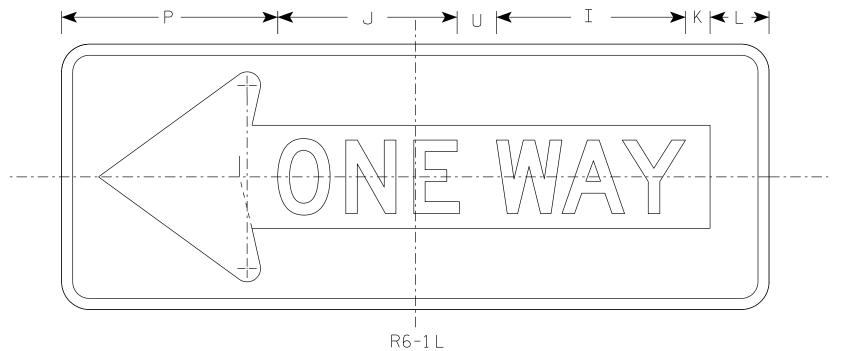

SIZE	Α .	В	С	D	E	F	G	Н	I	J	К	L	М	N	0	Р	Q	R	S	Т	U	٧	W	X	Y	Z	Area sq. ft.
1																											
25	36	12	1 1/2	1/2		4	2	7 1/2	9 5/8	9 1/8	1 1/4	3	3 3/8	5/8	4 3/8	11		3/8	7 1/2	3/4	2						3.0
2M	48	18	1 1/8	3/4		5	2 1/2	11	13	12 1/4	2 3/4	3 1/2	5 1/2	1	7 1/8	13 1/2		1/2	10 1/8	7/8	3						6.0
3	48	18	1 1/8	3/4		5	2 1/2	11	13	12 1/4	2 3/4	3 1/2	5 1/2	1	7 1/8	13 1/2		1/2	10 1/8	7/8	3						6.0
4	48	18	1 1/8	3/4		5	2 1/2	11	13	12 1/4	2 3/4	3 1/2	5 1/2	1	7 1/8	13 1/2		1/2	10 1/8	7/8	3						6.0
5																											

STANDARD SIGN R6-1 L&R

WISCONSIN DEPT OF TRANSPORTATION

APPROVED

Matther R Rawh

For State Traffic Engineer

DATE 4/7/2025 PLATE NO. R6-1.5

SHEET NO:

FILE NAME : C:\CAEfiles\Projects\tr_stdplate\R61.dgn

PROJECT NO:

PLOT DATE : 7-APR 2025 1:18

PLOT BY : dotc4c


WISDOT/CADDS SHEET 42


Ε

- 1. Sign is Type II Type H Reflective
- 2. Color:

Background - White Message – Black

- 3. Message Series D
- 4. R6-2L same as R6-2R except arrow points to the left.

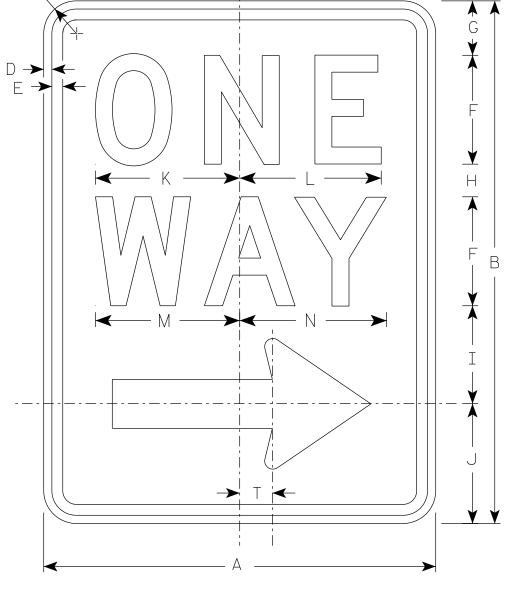

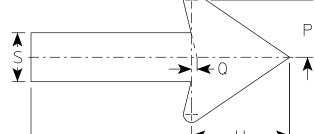

Arrow Detail

R6-2R

SIZE	А	В	С	D	Е	F	G	Н	I	J	K	L	М	N	0	Р	Q	R	S	Т	U	٧	W	Х	Υ	Z
1	18	24	1 1/2	3/8	1/2	5	2 1/2	1 1/2	4 1/2	5 1/2	6 %	6 1/2	6 %	6 3/4	11 1/8	2 5/8	1/4	3/8	2 1/4	1 1/2	4 1/2					
25	24	1 1/2	1 1/2	3/8	1/2	6	3	2 1/2	5 1/2	7	8 1/8	8 1/8	8 1/2	8 5/8	16	3 1/2	3/8	1/2	3	2	6					
2M	30	36	1 1/8	1/2	5/8	8	2 1/2	2 5/8	6 1/8	8	10 1/2	10 1/2	11 1/4	11 1/4	20	4 3/8	1/2	5/8	3 3/4	2 1/2	7 1/2					
3	36	48	1 1/8	1/2	5/8	10	5 1/4	3 1/4	9	10 1/2	12 3/4	12 3/4	13 1/4	13 1/2	24	5 %	1/2	3/4	4 3/4	3	9					
4	36	48	1 1/8	1/2	5/8	10	5 1/4	3 1/4	9	10 1/2	12 3/4	12 3/4	13 1/4	13 1/2	24	5 5/8	1/2	3/4	4 3/4	3	9					
5																										

STANDARD SIGN R6-2 R&L

WISCONSIN DEPT OF TRANSPORTATION

APPROVED

 \mathcal{F}_{or} State Traffic Engineer

SHEET NO:

DATE 11/2/10

PLATE NO. R6-2.8

FILE NAME : C:\CAEfiles\Projects\tr_stdplate\R62.dgn

HWY:

PROJECT NO:


COUNTY:

PLOT DATE: 30-AUG 2023 3:56 PLOT BY: mscj9h PLOT NAME :

- 1. Sign is Type II Type H Reflective
- 2. Color:

Background - White Message - Black

- 3. Message Series C
- 4. Use Size 2 for Sidewalks. Use Size 3 for Paths and Trails.

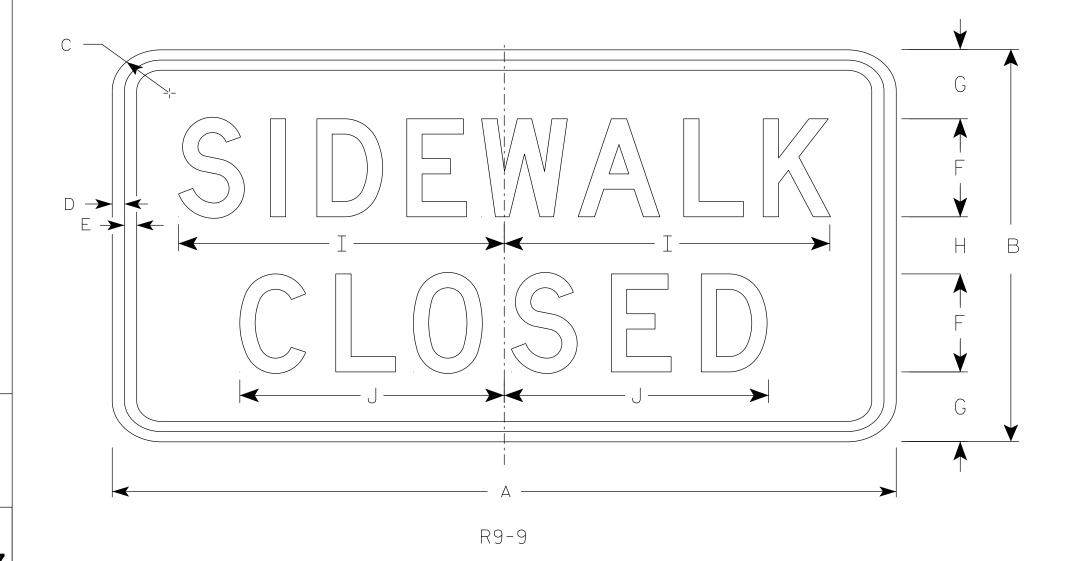

SIZE	А	В	С	D	E	F	G	Н	I	J	K	L	М	Ν	0	Р	Q	R	S	Т	U	V	W	X	Y	Z	Area sq. ft.
1																											
25	24	12	1 1/2	1/2	1/2	3	2 1/8	1 3/4	10	8 1/8																	2.0
2M	24	12	1 1/2	1/2	1/2	3	2 1/8	1 3/4	10	8 1/8																	2.0
3	30	18	1 1/2	1/2	1/2	4	3 1/2	3	12 1/2	10 1/4																	3.75
4																											
5																											

COUNTY:

STANDARD SIGN R9-9

WISCONSIN DEPT OF TRANSPORTATION

APPROVED

For State Traffic Engineer

SHEET NO:

DATE <u>1/24/24</u>

PLATE NO. <u>R9-9.7</u>

FILE NAME : C:\CAEfiles\Projects\tr_stdplate\R99.dgn

HWY:

PROJECT NO:


PLOT DATE: 24-JAN 2024 11:55

PLOT BY: mscj9h

PLOT NAME :

PLOT SCALE: \$\$.....plotscale.....\$\$WISDOT/CADDS SHEET 42


1

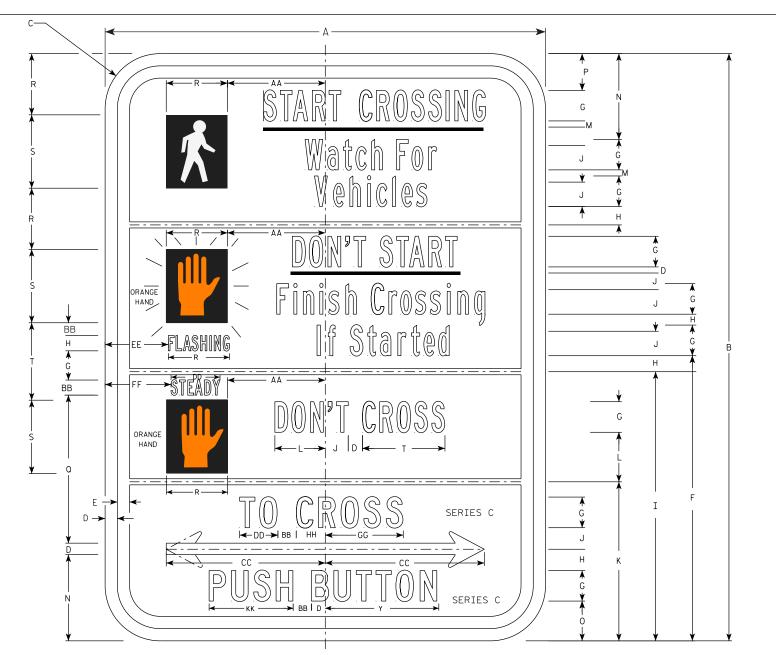

- 1. All Signs Type II Type H Reflective
- 2. Color:

Background - WHITE Message - BLACK except Hand Symbol which is Orange with black background.

- 3. Message Series B or as noted on the sign.
- 4. R10-3BR (right arrow) R10-3BL (left arrow) R10-3BD (double arrow)

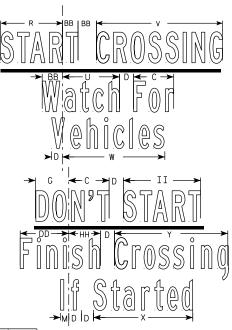

											R10-3	3B															
SIZE	А	В	С	D	E	F	G	Н	I	J	K	┙	М	Ν	0	Р	Q	R	S	T	U	٧	W	X	Υ	Z	Area sq. ft.
1	6	9	1 1/2	1/8	1/8	4 1/4	1/2	1/8	4 1/8	3/8	2 3/8	7/8	1/8	$1\frac{3}{8}$	5/8	5/8	2 1/4	7/8	1 1/8	1 1/4	3/4	1 3/4	1 5/8	1 3/8	1 1/2	5/8	0.38
25	9	12	1 1/2	1/4	1/4	5 1/8	5/8	3/8	5 1/2	1/2	3 1/4	1	1/8	1 3/4	7/8	3/4	3	1 1/4	1 1/2	1	1 1/8	2 5/8	2 1/8	2	2 3/8	1 3/8	0.75
2M	9	12	1 1/2	1/4	1/4	5 1/8	5/8	3/8	5 1/2	1/2	3 1/4	1	1/8	1 3/4	7/8	3/4	3	1 1/4	1 1/2	1 5/8	1 1/8	2 5/8	2 1/8	2	2 3/8	1 3/8	0.75
3																											
4																											
5																											
SIZE	АА	ВВ	СС	DD	EE	FF	GG	НН	ΙΙ	JJ	KK	LL	ММ	NN	00	PP	00	RR	SS	TT	UU	٧٧	WW	XX	ΥY	ZZ	Area sq. ft.
1	1 1/2	1/4	2 1/4	5/8	5/8	5/8	1 1/8	3/8	1	1/2	1 1/8																
25	2	3/8	3 1/4	1	1 1/4	1 3/8	1 5/8	5/8	1	3/4	1 3/4																
2M	2	3/8	3 1/4	1	1 1/4	1 3/8	1 5/8	5/8	1 %	3/4	1 3/4																
3																											
4																											
5	·								·									·									

STANDARD SIGN R10-3B

WISCONSIN DEPT OF TRANSPORTATION

APPROVED

DATE 1/24/24


For State Traffic Engineer PLATE NO. <u>R10-3B.3</u>

SHEET NO:

PROJECT NO:

PLOT BY: mscj9h

Ε

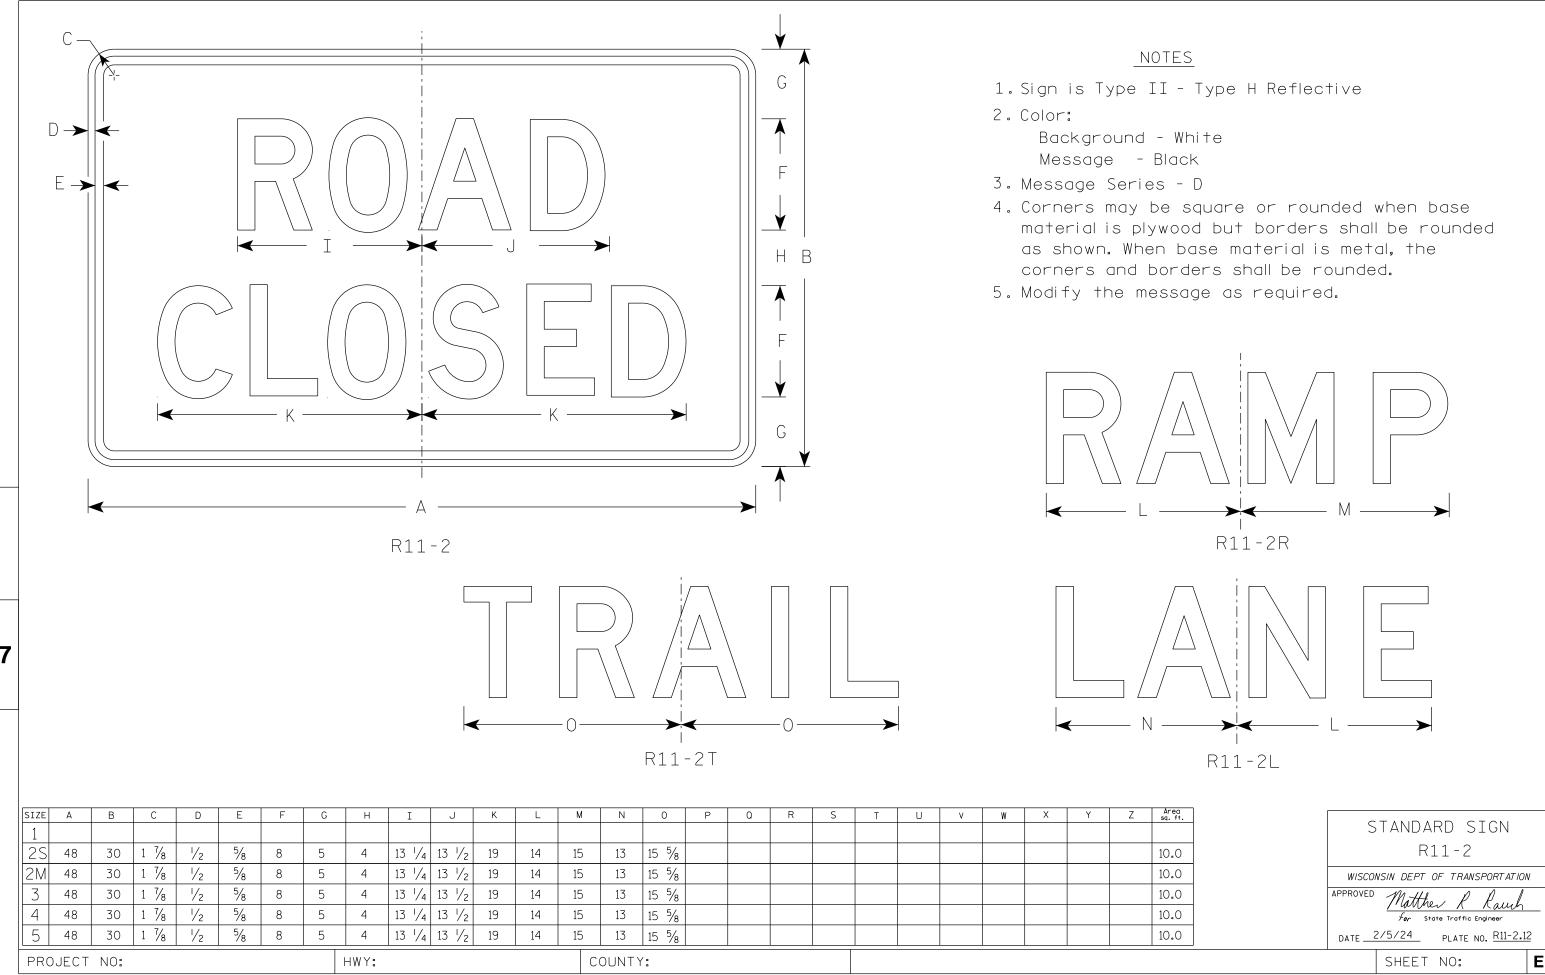

FILE NAME : C:\Users\PROJECTS\tr_stdplate\R112.dgn

PLOT DATE: 5-FEB 2024 2:10


PLOT BY: mscj9h

PLOT NAME :

- 1. Sign is Type II Type H Reflective
- 2. Color:

Background - White Message - Black

- 3. Message Series C
- 4. Corners may be square or rounded when base material is plywood but borders shall be rounded as shown. When base material is metal, the corners and borders shall be rounded.

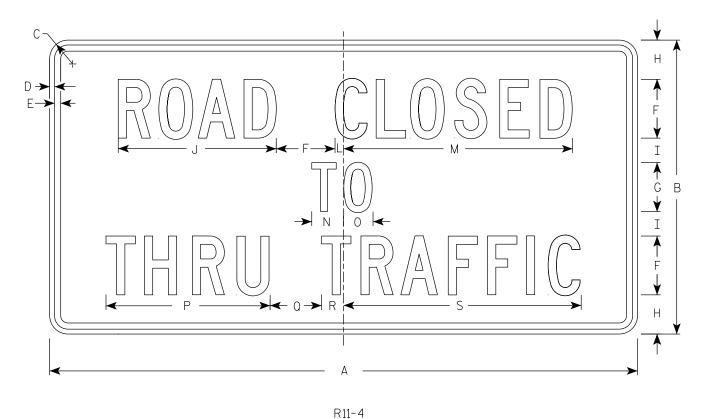

K11-2

SIZE	Α	В	С	D	E	F	G	Ι	I	J	K	L	М	N	0	Р	Q	R	S	Т	U	٧	W	X	Υ	Z	Area sq. ft.
1																											
25	60	30	1 1/8	1/2	5/8	6	5	4	2 1/2	16 1/8		7/8	23 3/8	3 1/4	3	16 3/4	5 1/4	2 1/4	24 1/4								12.5
2M	60	30	1 1/8	1/2	5/8	6	5	4	2 1/2	16 1/8		7/8	23 3/8	3 1/4	3	16 3/4	5 1/4	2 1/4	24 1/4								12.5
3																											
4																											
5																											

COUNTY:

STANDARD SIGN R11 - 4

WISCONSIN DEPT OF TRANSPORTATION

APPROVED

Matthew K Kaush For State Traffic Engineer

SHEET NO:

DATE 2/5/24

PLATE NO. R11-4.4

FILE NAME : C:\CAEfiles\Projects\tr_stdplate\R114.dgn

HWY:

PROJECT NO:

PLOT DATE : 5-FEB 2024 2:54

PLOT BY: mscj9h

PLOT NAME: PLOT SCALE: \$\$.

PLOT SCALE: \$\$.....plotscale.....\$\$ WISDOT/CADDS SHEET 42

7



- 1. Sign is Type II Type F Reflective
- 2. Color:

Background - Yellow Message - See Note 3

3. Symbol and border are non-reflective black. Top circle - Type H Reflectorized Red Center circle - Same as background Bottom circle - Type H Reflectorized Green

	DE
A //	RED H
	YELILOW G G G H GREEN
A	T T C W3-3

SIZE	A	В	С	D	E	F	G	Н	I	J	K	L	М	N	0	Р	Q	R	S	Т	U	V	W	X	Y	Z	Area sq. ft.
1	30		1 1/8	1/2	5/8		8 3/4	13 3/4	5	3 3/4																	6.25
25	36		2 1/4	5/8	3/4		10	15 3/4	5 3/4	4 1/4																	9.0
2M	36		2 1/4	5/8	3/4		10	15 3/4	5 3/4	4 1/4																	9.0
3	36		2 1/4	5/8	3/4		10	15 3/4	5 3/4	4 1/4																	9.0
4	48		3	3/4	1		12 1/2	20	7 1/2	5																	16.0
5	48		3	3/4	1		12 1/2	20	7 1/2	5																	16.0
PRC	JECT	NO:					HW	/ Y :					COUN	TY:													

STANDARD SIGN W3-3

WISCONSIN DEPT OF TRANSPORTATION

APPROVED Matther

SHEET NO:

DATE 8/21/2023 PLATE NO. W3-3.12

FILE NAME : C:\CAEfiles\Project\tr_stdplate\W33.dgn

PLOT DATE: 21-AUG 2023 3:13


PLOT BY : dotc4c

PLOT NAME :

- 1. Sign is Type II Type F Reflective
- 2. Color:

Background - Yellow Message - Black

3. W6-2 same as W6-1 but is rotated 180° when mounted.

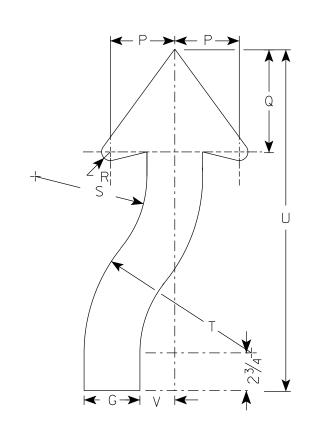

ARROW DETAIL

SIZE	А	В	С	D	Е	F	G	Н	I	J	K	L	М	Ν	0	Ρ	Q	R	S	Т	U	٧	W	X	Υ	Z	Area sq. ft.
1	30		1 1/8	1/2	5/8		3 1/4	8	8 1/4	4 1/8	7 1/8	25	1 3/4	11	4 1/8	3 1/8	6 3/4	5/8	6 5/8	9 %	21 5/8	2					6.25
25	36		2 1/4	5/8	3/4		4	8 3/4	10	4 3/4	9 1/2	30	2	14	5	4 5/8	7 3/8	7/8	8	12	24 1/2	2 1/2					9.0
2M	36		2 1/4	5/8	3/4		4	8 3/4	10	4 3/4	9 1/2	30	2	14	5	4 5/8	7 3/8	7/8	8	12	24 1/2	2 1/2					9.0
3	36		2 1/4	5/8	3/4		4	8 3/4	10	4 3/4	9 1/2	30	2	14	5	4 5/8	7 3/8	7/8	8	12	24 1/2	2 1/2					9.0
4	48		3	3/4	1		5 3/8	11 5/8	13 3/8	6 3/8	12 5/8	40	2 5/8	18	6 5/8	6 1/4	9 1/8	1 1/4	10 5/8	16	32 %	3 3/8					16.0
5	48		3	3/4	1		5 3/8	11 5/8	13 3/8	6 3/8	12 5/8	40	2 5/8	18	6 5/8	6 1/4	9 1/8	1 1/4	10 5/8	16	32 %	3 3/8					16.0

 $\leftarrow G \rightarrow \leftarrow G \rightarrow$

STANDARD SIGN W6-1 & W6-2

WISCONSIN DEPT OF TRANSPORTATION


APPROVED Matthew R &

DATE 9/6/2023 PLATE NO. W6-1.15

PROJECT NO: HWY: COUNTY: SHEET NO:

- 1. Sign is Type II Type F Reflective
- 2. Color:

Background - Yellow Message - Black

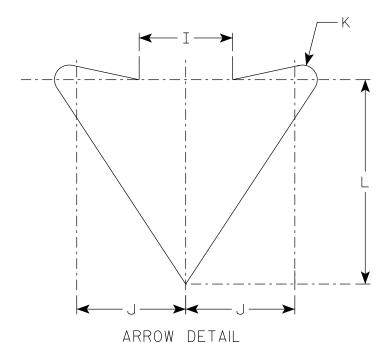

-	K K
i I → J → ARROW	/¥ ←── J ──> DETAIL

									110	J																	
SIZE	А	В	С	D	E	F	G	Н	I	J	K	L	М	N	0	Р	Q	R	S	Т	U	V	W	X	Y	Z	Area sq. ft.
1	30		1 1/8	1/2	5/8	11 1/8	10 1/4	2 1/2	3 3/4	4 3/8	5/8	8 1/4															6.25
25	36		2 1/4	5/8	3/4	13 3/8	12 1/4	3	4 1/2	5 1/4	3/4	9 7/8															9.0
2M	36		2 1/4	5/8	3/4	13 3/8	12 1/4	3	4 1/2	5 1/4	3/4	9 7/8															9.0
3	36		2 1/4	5/8	3/4	13 3/8	12 1/4	3	4 1/2	5 1/4	3/4	9 7/8															9.0
4	48		3	3/4	1	17 3/4	16 3/8	4	6	7	1	13 1/8															16.0
5	48		3	3/4	1	17 3/4	16 3/8	4	6	7	1	13 1/8															16.0

COUNTY:

STANDARD SIGN W6-3

WISCONSIN DEPT OF TRANSPORTATION

DATE <u>9/6/2023</u> PLATE NO. <u>W6-3.12</u>

Ε

SHEET NO:

FILE NAME : C:\CAEfiles\Projects\tr_stdplate\W63.dgn

HWY:

PROJECT NO:

PLOT DATE: 6-SEPT 2023 8:00

PLOT BY : dotc4c


PLOT NAME :



- 1. Sign is Type II Type F Reflective
- 2. Color:

Background - Orange Message - Black

- 3. Message Series See note 5
- 4. The top line is series E, the numerals are series C, and the bottom line is series D.
- 5. Substitute appropriate numerals and adjust spacing as required.

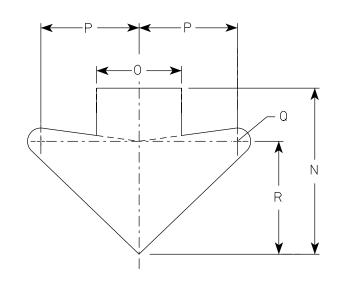

ARROW DETAIL

SIZE	А	В	С	D	E	F	G	Н	I	J	K	∟	М	N	0	Р	Q	R	S	Т	U	٧	W	X	Y	Z	Area sq. ft.
1 1																											
25	48		3	3/4	1	6	12	11 3/8	9 5/8	11 1/2	16	13	12	15 %	8	9 1/4	1 1/4	10 %									16.0
2M	48		3	3/4	1	6	12	11 3/8	9 5/8	11 1/2	16	13	12	15 %	8	9 1/4	1 1/4	10 5/8									16.0
3																											
4																											
5																											
PRO	JECT	NO:					HW	Υ:					COUNT	Y:													

W12-52

STANDARD SIGN W12-52

WISCONSIN DEPT OF TRANSPORTATION

APPROVED

For State Traffic Engineer

DATE 3/10/2024 PLATE NO. W12-52.8

SHEET NO:

FILE NAME : C:\CAEfiles\Projects\tr_stdplate_W1252.dgn

PLOT DATE: 10-MARCH 2024 3:20

PLOT BY : dotc4c

PLOT NAME :

1. Sign is Type II - Type F Reflective

2. Color:

Background - Yellow Message – Black

3. Message Series - D

A
F H
F F
A E
W14-2

SIZE	Α	В	C	D	Ł	F	G	Ι	I	J	K	L	M	N	0	Р	Q	R	S	T	U	٧	W	Х	Y	Ζ	sq. ft.
1	24		1 1/2	3/8	1/2	5	1	2 3/4	4 1/8	11 3/4	12 3/8																4.0
25	30		1 1/8	1/2	5/8	6	1 1/4	3 3/4	5 1/8	13 3/4	14 5/8																6.25
2M	30		1 1/8	1/2	5/8	6	1 1/4	3 3/4	5 1/8	13 3/4	14 5/8																6.25
3	36		2 1/4	5/8	3/4	7	1 3/8	4 5/8	6	16 1/8	17 1/8																9.0
4																											
5																											

STANDARD SIGN W14 - 2

WISCONSIN DEPT OF TRANSPORTATION

DATE 1/8/2024 PLATE NO. W14-2.4

SHEET NO:

FILE NAME : C:\CAEfiles\Projects\tr_stdplate\W142.dgn

PROJECT NO:

PLOT DATE: 8-Jan 2024 3:23

PLOT BY : dotc4c

For State Traffic Engineer




- 1. Sign is Type II Type F Reflective
- 2. Color:

Background - Yellow

Message – Black

3. Message Series - Lines 1 and 2 are Series D. Line 3 is series C.

4. Corners and borders shall be rounded on all base materials for this sign.

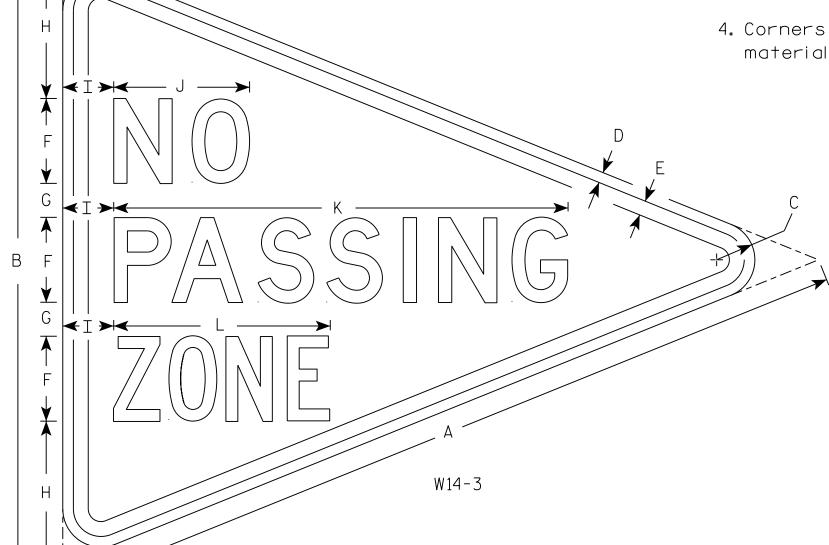

			,																								
SIZE	Α	В	С	D	E	F	G	Н	I	J	K	L	М	N	0	Р	0	R	S	Т	U	٧	W	Х	Y	Z	Area sq. ft.
1																											
2S	48	36	2 1/4	5/8	<i>7</i> ⁄8	5	2	8 ½	3	8	26 ¾	12 3/4															5 . 56
2M																											
3																											
4																											
5																											
PRC	JECT	NO:					Н	WY:					COL	INTY:													

STANDARD SIGN W14-3

WISCONSIN DEPT OF TRANSPORTATION

500 3/21/17

E 3/21/17 PLATE NO. W14-3

SHEET NO:

FILE NAME : C:\CAEfiles\Projects\tr_stdplate\W143.DGN

PLOT DATE: 21-MAR-2017 08:48

PLOT BY: \$\$...plotuser...\$\$ PLOT NAME:


PLOT SCALE : 5.650195:1.000000



- 1. Sign is Type II Type F Reflective
- 2. Color:

Background - Orange Message - Black

- 3. Message Series see note 5
- 4. Corners may be square or rounded when base material is plywood but borders shall be rounded as shown. When base material is metal, the corners and borders shall be rounded.
- 5. Lines 1 and 2 are Series D.
 Line 3 is Series D for AHEAD and
 Series C for all other distances.

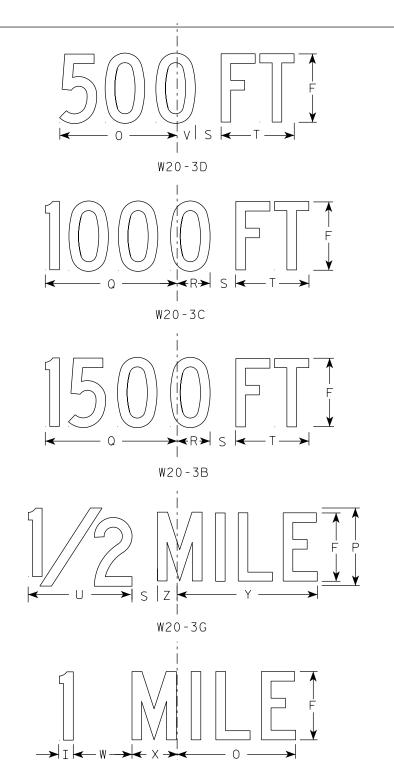

W20-3F

A N	
C	

HWY:

W20-3A

SIZE	Α	В	С	D	E	F	G	Н	I	J	К	L	М	Z	0	Р	Q	R	S	Т	U	V	W	X	Y	Z	Area sq. ft.
1	36		2 1/4	5/8	3/4	5	3 3/8	3 1/2	1 1/8	4	8 3/8	8 1/8	12 1/2	11	9	6	10 1/8	2 1/2	1 1/8	5 %	8	1 3/8	4 1/2	3 1/2	10 3/4	1 3/4	9.0
25	48		3	3/4	1	7	4 1/2	4 3/4	1 1/2	5 1/4	11 3/4	12 1/2	17 1/4	14	12	8	13 1/2	3 3/8	2 5/8	7 1/2	10 %	1 1/8	6	4 5/8	14 3/8	2 3/8	16.0
2M	48		3	3/4	1	7	4 1/2	4 3/4	1 1/2	5 1/4	11 3/4	12 1/2	17 1/4	14	12	8	13 1/2	3 3/8	2 5/8	7 1/2	10	1 1/8	6	4 5/8	14 3/8	2 3/8	16.0
3	48		3	3/4	1	7	4 1/2	4 3/4	1 1/2	5 1/4	11 3/4	12 1/2	17 1/4	14 5/8	12	8	13 1/2	3 3/8	2 5/8	7 1/2	10 5/8	1 1/8	6	4 5/8	14 3/8	2 3/8	16.0
4	48		3	3/4	1	7	4 1/2	4 3/4	1 1/2	5 1/4	11 3/4	12 1/2	17 1/4	14	12	8	13 1/2	3 3/8	2 5/8	7 1/2	10 5/8	1 1/8	6	4 5/8	14 3/8	2 3/8	16.0
5	48		3	3/4	1	7	4 1/2	4 3/4	1 1/2	5 1/4	11 3/4	12 1/2	17 1/4	14 5/8	12	8	13 1/2	3 3/8	2 5/8	7 1/2	10 5/8	1 1/8	6	4 5/8	14 3/8	2 3/8	16.0

COUNTY:

STANDARD SIGN W20-3A, B, C, D, F & G

WISCONSIN DEPT OF TRANSPORTATION

 $\frac{MMMeV}{F_{or}}$ State Traffic Engineer

SHEET NO:

DATE 1/10/2024 PLATE NO. W20-3.8

FILE NAME : C:\CAEfiles\Projects\tr_stdplate\W203.DGN

PROJECT NO:


PLOT DATE: 10-JAN 2024 12:02 PLOT BY: dotc4c


PLOT NAME :

- 1. Sign is Type II Type F Reflective
- 2. Color:

Background - Orange Message - Black

- 3. Message Series See Note 5
- 4. Corners may be square or rounded when base material is plywood but borders shall be rounded as shown. When base material is metal, the corners and borders shall be rounded.
- 5. " ____ LANE" is Series B. All other copy is Series C.

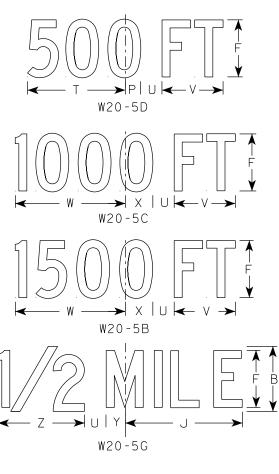

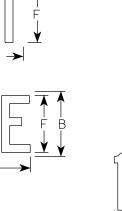

→ Q ← R → ← S → ← T →
W20-5E

W20-5F

SIZE	А	В	С	D	E	F	G	Н	I	J	K	L	М	N	0	Р	Q	R	S	Т	U	٧	W	X	Y	Z	Area sq. ft.
1	36	6	2 1/4	5/8	3/4	5	7/8	2 1/2	13 1/8	10 3/4	9 1/2	14 1/4	13 5/8	12	12	1 3/8	1 1/8	4 1/2	3 1/2	9	1 1/8	5 5/8	10 1/8	2 1/2	1 3/4	8	9.0
25	48	8	3	3/4	1	7	1 1/4	3 1/4	17 1/2	14 3/8	12 5/8	19	18 3/8	16	14 1/4	1 1/8	1 1/2	6	4 5/8	12	2 5/8	7 1/2	13 1/2	3 3/8	2 3/8	10 5/8	16.0
2M	48	8	3	3/4	1	7	1 1/4	3 1/4	17 1/2	14 3/8	12 5/8	19	18 3/8	16	14 1/4	1 1/8	1 1/2	6	4 5/8	12	2 5/8	7 1/2	13 1/2	3 3/8	2 3/8	10	16.0
3	48	8	3	3/4	1	7	1 1/4	3 1/4	17 1/2	14 3/8	12 5/8	19	18 3/8	16	14 1/4	1 1/8	1 1/2	6	4 5/8	12	2 5/8	7 1/2	13 1/2	3 3/8	2 3/8	10 5/8	16.0
4	48	8	3	3/4	1	7	1 1/4	3 1/4	17 1/2	14 3/8	12 5/8	19	18 3/8	16	14 1/4	1 1/8	1 1/2	6	4 5/8	12	2 5/8	7 1/2	13 1/2	3 3/8	2 3/8	10 5/8	16.0
5	48	8	3	3/4	1	7	1 1/4	3 1/4	17 1/2	14 3/8	12 5/8	19	18 3/8	16	14 1/4	1 1/8	1 1/2	6	4 5/8	12	2 5/8	7 1/2	13 ½	3 3/8	2 3/8	10	16.0

COUNTY:

W20-5A

HWY:

STANDARD SIGN W20-5A, B, C, D, F & G

WISCONSIN DEPT OF TRANSPORTATION

For State Traffic Engineer

DATE 3/27/24 PLATE NO. <u>W20-5.12</u>

> Ε SHEET NO:

FILE NAME: C:\CAEfiles\Projects\tr_stdplate\W205.dgn

PROJECT NO:


W20-56A

W20-55A

PLOT DATE: 27-MAR 2024 4:01

PLOT BY: mscj9h

PLOT NAME :

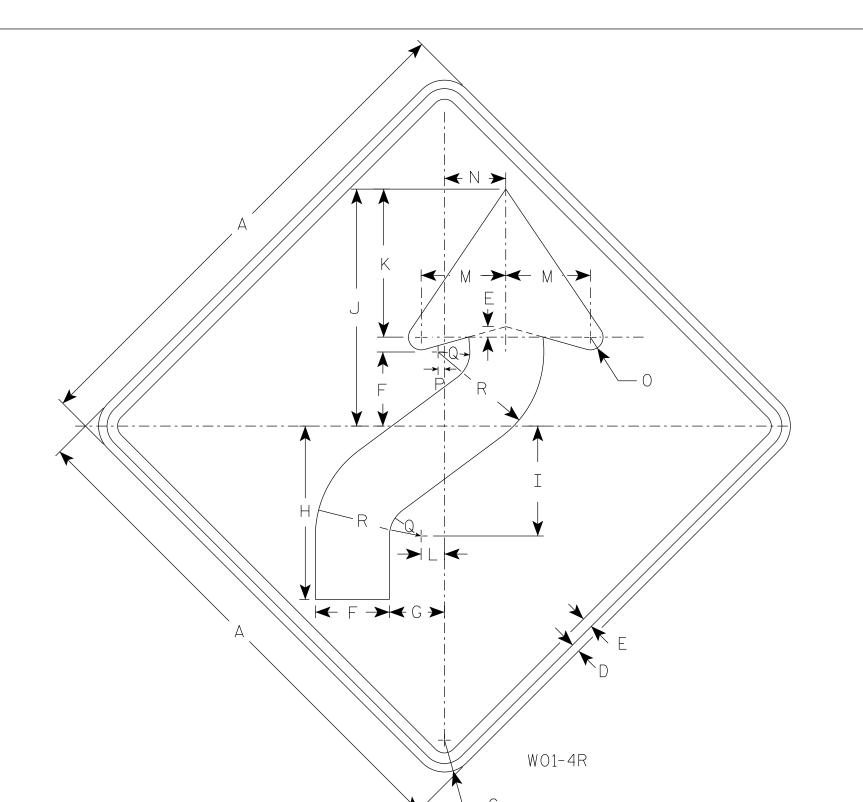

- 1. Sign is Type II Type F Reflective
- 2. Color:

Background - Orange Message - Black

- 3. Corners may be square or rounded when base material is plywood but borders shall be rounded as shown. When base material is metal, the corners and borders shall be rounded.
- 4. W01-4L is the same as W01-4R except the arrow is reversed along the vertical centerline.

SIZE A 5/8 3/4 5 1/4 4 12 3/8 7 7/8 16 7/8 10 1/2 1 5/8 $4 \frac{1}{2}$ 1/2 2 1/4 7 1/2 9.0 36 2 1/4 3/4 5 1/4 16 1/2 10 1/2 22 1/2 48 3 2 1/4 1 1/4 5/8 3 16.0 l2ML 5 1/4 16 1/2 10 1/2 22 1/2 48 3/4 2 1/4 1 1/4 5/8 3 3 10 16.0 5 1/4 16 1/2 10 1/2 22 1/2 3/4 1 1/4 5/8 48 14 2 1/4 3 10 16.0 3 5 1/4 16 1/2 10 1/2 22 1/2 4 48 3/4 14 2 1/4 6 1 1/4 5/8 3 10 16.0 5 3/4 5 1/4 16 1/2 10 1/2 22 1/2 6 1 1/4 5/8 3 48 3 2 1/4 10 16.0 STANDARD SIGN WO1-4

WISCONSIN DEPT OF TRANSPORTATION

APPROVED

For State Traffic Engineer

SHEET NO:

DATE 1/24/2024 PLATE NO. WO1-4.2

PROJECT NO: FILE NAME : C:\CAEfiles\Projects\tr_stdplate\W014.dgn HWY:

COUNTY: PLOT DATE: 24-JAN 2024 10:56

PLOT BY : dotc4c

PLOT NAME :

PLOT SCALE: \$\$.....plotscale.....\$\$ wisdot/cadds sheet 42

- 1. Sign is Type II Type F Reflective
- 2. Color:

Background - Orange Message - Black

3. Corners may be square or rounded when base material is plywood but borders shall be rounded as shown. When base material is metal, the corners and borders shall be rounded.

	B A A A B A A B B A A B B A B B
M N	1-6

SIZE	А	В	С	D	E	F	G	Н	I	J	К	L	М	N	0	Р	Q	R	S	Т	U	٧	W	X	Υ	Z	Area sq. ft.
1																											
25	48	24	1 1/8	1/2	5/8		12	13 1/4	1	7 1/2	6 1/2	3 1/4	19 1/2	39													8.0
2M	48	24	1 1/8	1/2	5/8		12	13 1/4	1	7 1/2	6 1/2	3 1/4	19 1/2	39													8.0
3	60	30	1 1/8	1/2	5/8		15	16 1/4	1 1/4	9 1/4	8	4	24 3/8	48 3/4													12.5
4	60	30	1 1/8	1/2	5/8		15	16 1/4	1 1/4	9 1/4	8	4	24 3/8	48 3/4													12.5
5	60	30	1 1/8	1/2	5/8		15	16 1/4	1 1/4	9 1/4	8	4	24 3/8	48 3/4													12.5

COUNTY:

STANDARD SIGN WO1-6

WISCONSIN DEPT OF TRANSPORTATION

SHEET NO:

APPROVED

Matthew R Rauch

DATE <u>1/24/2024</u>

PLATE NO. <u>W01-6.2</u>

Ε

FILE NAME : C:\Users\PROJECTS\tr_stdplate\W016.dgn

HWY:

PROJECT NO:

PLOT DATE: 24-JAN 2024 1:12

PLOT BY : dotc4c

PLOT SCALE: \$\$.....plotscale.....\$\$ WISDOT/CADDS SHEET 42

PLOT NAME :

- 1. Sign is Type II Type F Reflective
- 2. Color:

Background - Orange Message – Black

3. Corners may be square or rounded when base material is plywood but borders shall be rounded as shown. When base material is metal, the corners and borders shall be rounded.

K H H H H	+
₩C	1 1-7

SIZE	А	В	С	D	Е	F	G	Н	I	J	K	L	М	N	0	Р	ο	R	S	Т	V	W	Χ	Υ	Z	Area sq. ft.
1																										
25	48	24	1 1/8	1/2	5/8	6 1/2	3 1/4	7 1/2	1	20 1/2	13 1/4															8.0
2M	48	24	1 1/8	1/2	5/8	6 1/2	3 1/4	7 1/2	1	20 1/2	13 1/4															8.0
3	60	30	1 1/8	1/2	5/8	8	4	9 1/4	1 1/4	25 3/8	16 1/4															12.5
4	60	30	1 1/8	1/2	5/8	8	4	9 1/4	1 1/4	25 3/8	16 1/4															12.5
5	60	30	1 1/8	1/2	5/8	8	4	9 1/4	1 1/4	25 3/8	16 1/4															12.5

STANDARD SIGN WO1-7

WISCONSIN DEPT OF TRANSPORTATION

APPROVED

 \mathcal{F}_{or} State Traffic Engineer

DATE 1/24/2024 PLATE NO. WO1-7.2

SHEET NO:

Ε

HWY:

COUNTY:

PLOT BY : dotc4c


PLOT NAME :

PLOT SCALE: \$\$.....plotscale.....\$\$ WISDOT/CADDS SHEET 42

FILE NAME : C:\CAEFiles\Projects\tr_stdplate\W017.DGN


PROJECT NO:

PLOT DATE: 24-JAN 2024 1:20

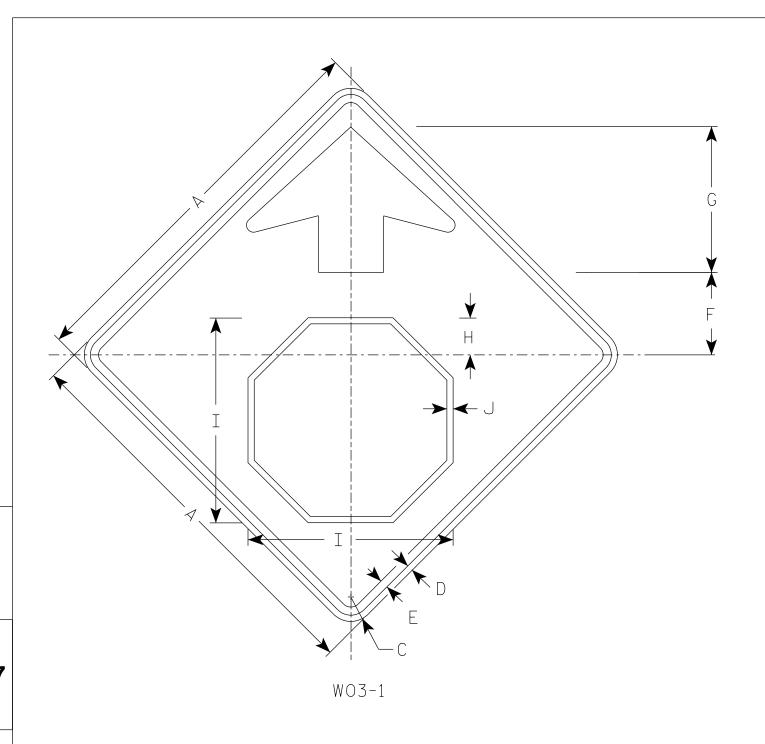

- 1. All Signs Type II Type F Reflective
- 2. Color:

Background - ORANGE Arrow & Border - BLACK Stop Symbol - WHITE BORDER ON RED BACKGROUND

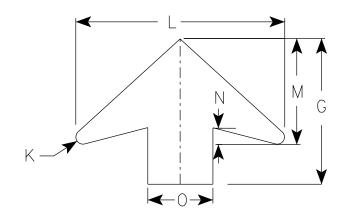

ARROW DETAIL

SIZE	А	В	С	D	E	F	G	Н	I	J	К	L	М	N	0	Р	Q	R	S	Т	U	V	W	X	Y	Z	Area sq. ft.
1	36		2 1/4	5/8	3/4	7 1/2	13 1/2	3 1/2	19	5/8	5/8	19 1/4	9 3/4	1 5/8	6												9.0
25	48		3	3/4	1	10	17 1/8	4 1/2	25 1/8	3/4	7/8	25 %	13	2	8												16.0
2M	48		3	3/4	1	10	17 1/8	4 1/2	25 1/8	3/4	7/8	25 %	13	2	8												16.0
3	48		3	3/4	1	10	17 1/8	4 1/2	25 1/8	3/4	7/8	25 %	13	2	8												16.0
4	48		3	3/4	1	10	17 1/8	4 1/2	25 1/8	3/4	7/8	25 %	13	2	8												16.0
5	48		3	3/4	1	10	17 1/8	4 1/2	25 1/8	3/4	7/8	25 %	13	2	8												16.0

STANDARD SIGN WO3-1

WISCONSIN DEPT OF TRANSPORTATION

APPROVED

DATE 1/24/2024 PLATE NO. W03-1.2

SHEET NO:

FILE NAME : C:\CAEFiles\Projects\tr_stdplate\W031.DGN

PROJECT NO:

PLOT DATE: 24-JAN 2024 1:46

PLOT BY : dotc4c

- 1. Sign is Type II Type F Reflective
- 2. Color:

Background - Orange Message - Black

- 3. Corners may be square or rounded when base material is plywood but borders shall be rounded as shown. When base material is metal, the corners and borders shall be rounded.
- 4. W04-2L is the same as W04-2R except the symbolis reversed along the vertical centerline.

D E	
← G →	
F F	
$A \longrightarrow K \longrightarrow $	
С	

W04-2R

SIZE	А	В	С	D	E	F	G	Н	I	J	К	L	М	Ν	0	Р	a	R	S	Т	U	V	W	X	Υ	Z	Area sq. ft.
1	36		2 1/4	5/8	3/4	12	4	45°	1	1 3/4	5	3	1 1/2														9.0
25	48		3	3/4	1	16	5 3/8	45°	1 1/4	2 3/8	6 3/4	4	2														16.0
2M	48		3	3/4	1	16	5 3/8	45°	1 1/4	2 3/8	6 3/4	4	2														16.0
3	48		3	3/4	1	16	5 3/8	45°	1 1/4	2 3/8	6 3/4	4	2														16.0
4	48		3	3/4	1	16	5 3/8	45°	1 1/4	2 3/8	6 3/4	4	2														16.0
5	48		3	3/4	1	16	5 3/8	45°	1 1/4	2 3/8	6 3/4	4	2														16.0

STANDARD SIGN WO4-2

WISCONSIN DEPT OF TRANSPORTATION

APPROVED

For State Traffic Engineer

DATE 1/25/2024 PLATE NO. W04-2.2


SHEET NO:

FILE NAME : C:\Users\PROJECTS\tr_stdplate\W042.dgn

PROJECT NO:

PLOT DATE: 25-JAN 2024 9:07

PLOT BY : dotc4c

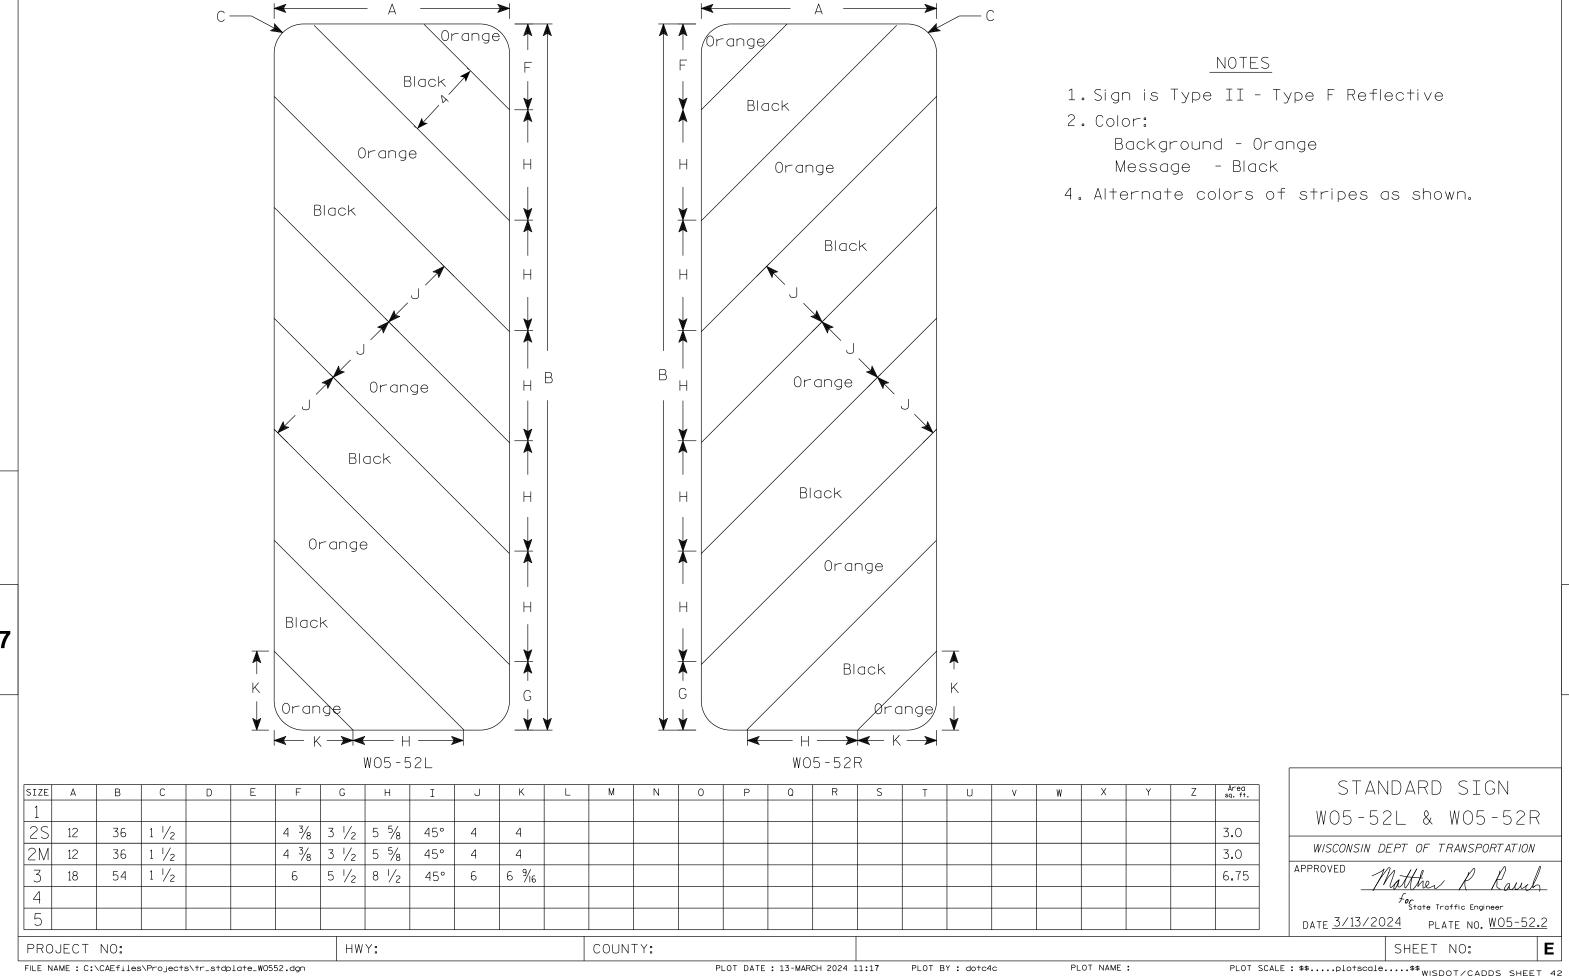


HWY:

NOTES

- 1. Sign is Type II Type F Reflective
- 2. Color:

Background - Orange Message - Black

3. Corners may be square or rounded when base material is plywood but borders shall be rounded as shown. When base material is metal, the corners and borders shall be rounded.

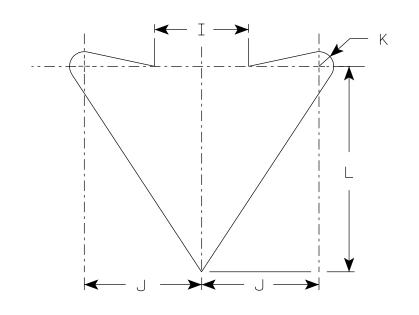

ARROW DETAIL

PLOT NAME :

SIZE	А	В	С	D	E	F	G	Н	I	J	K	L	М	Ν	0	Р	Q	R	S	Т	U	٧	W	X	Y	Z	Area sq. ft.
1	36		2 1/4	5/8	3/4	12	1	4 1/4	5	6	3/4	10 1/2	6 3/4														9.0
25	48		3	3/4	1	15 1/2	1	6	6	8	1	14	9														16.0
2M	48		3	3/4	1	15 1/2	1	6	6	8	1	14	9														16.0
3	48		3	3/4	1	15 1/2	1	6	6	8	1	14	9														16.0
4	48		3	3/4	1	15 1/2	1	6	6	8	1	14	9														16.0
5	48		3	3/4	1	15 1/2	1	6	6	8	1	14	9														16.0

COUNTY:

STANDARD SIGN W06-3

WISCONSIN DEPT OF TRANSPORTATION

APPROVED //

- - 1/30/2024 - - - WOC 3 2

DATE 1/30/2024 PLATE NO. W06-3.2

SHEET NO:

FILE NAME : C:\Users\PROJECTS\tr_stdplate\W063.dgn

PROJECT NO:


PLOT DATE: 30-JAN 2024 11:15

PLOT BY : dotc4c

- 1. Sign is Type II Type F Reflective
- 2. Color:

Background - Orange Message - Black

- 3. Message Series C
- 4. Corners may be square or rounded when base material is plywood but borders shall be rounded as shown. When base material is metal, the corners and borders shall be rounded.
- 5. Substitute appropriate numerals to the nearest quarter mile and optically adjust spacing to achieve proper balance.

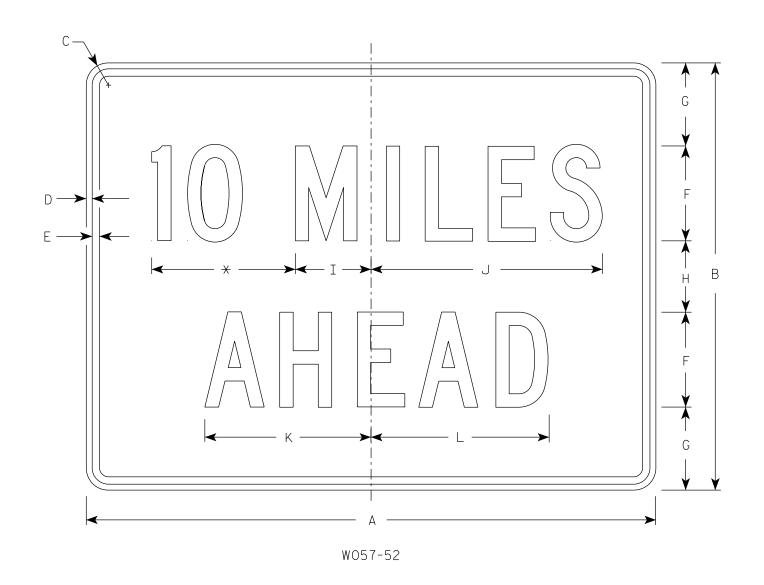

HWY:

* See note 5

SIZE	А	В	С	D	Е	F	G	Н	I	J	K	L	М	N	0	Р	Q	R	S	Т	U	٧	W	Х	Υ	Z	Area sq. ft.
1	36	24	1 1/2	3/8	1/2	6	4 1/2	3	4 3/4	14 5/8	10	11 3/8	2	12													6.0
25	48	36	2 1/4	1/2	5/8	8	7	6	6 3/8	19 ½	14	15	2 3/4	16 ³ / ₈													12.0
2M	48	36	2 1/4	1/2	5/8	8	7	6	6 3/8	19 ½	14	15	2 3/4	16 ³ / ₈													12.0
3	48	36	2 1/4	1/2	5/8	8	7	6	6 3/8	19 ½	14	15	2 3/4	16 3/8													12.0
4	48	36	2 1/4	1/2	5/8	8	7	6	6 3/8	19 ½	14	15	2 3/4	16 3/8													12.0
5	48	36	2 1/4	1/2	5/8	8	7	6	6 3/8	19 1/2	14	15	2 3/4	16 3/8													12.0

COUNTY:

STANDARD SIGN W057-52

WISCONSIN DEPT OF TRANSPORTATION

APPROVED

 f_{or} State Traffic Engineer

SHEET NO:

DATE 2/1/2024

PLATE NO. W057-52.3

Ε

PROJECT NO:

PLOT DATE: 1-FEB 2024 10:54

PLOT BY : dotc4c


PLOT NAME :

1. Signs are Type II - Type H Reflective


2. Color:

Background - White Message - Red

3. Message Series - As noted

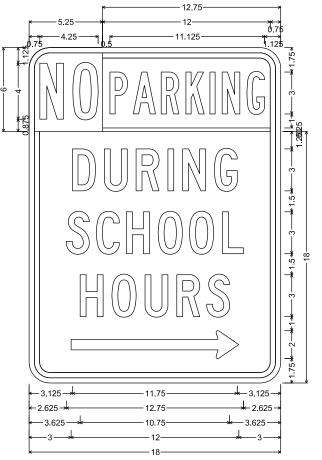

1.500" Radius, 0.375" Border,
"NO", B; "PARKING", B; "DURING", C; "SCHOOL", C; "HOURS", C

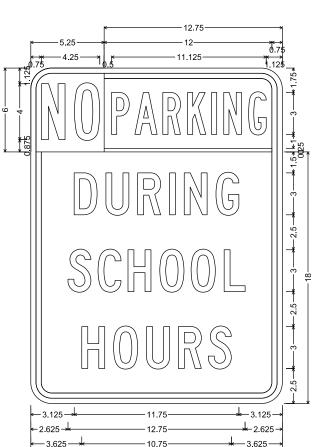

2.625-

1.500" Radius, 0.375" Border,

"NO", B; "PARKING", B; "DURING", C; "SCHOOL", C; "HOURS", C

2.625

-3.625 -

1.500" Radius, 0.375" Border,
"NO", B; "PARKING", B; "DURING", C; "SCHOOL", C; "HOURS", C

1.500" Radius, 0.375" Border,
"NO", B; "PARKING", B; "DURING", C; "SCHOOL", C; "HOURS", C

PROJECT NO:6999-00-76 HWY: WEST WAUSAU AVE COUNTY: MARATHON PERMANENT SIGNING SHEET NO: **E**

FILE NAME : C:\CAEfiles\Projects\tr_d4_43711a225.dgn

PLOT DATE : 17-FEB 2025 1:45

PLOT BY : mscj9h

PLOT NAME :

PLOT NA

			AREA	A (SF)		TAL VOL (CY) IUSTED)		CUMULATIVE VOL	(CY)
STATION	REAL STATION	DISTANCE	CUT	FILL	CUT	FILL	CUT	EXPANDED FILL	MASS ORDINAT
			601	1166	NOTE 1	NOTE 2	1.00 NOTE 1	1.25 NOTE 3	NOTE 4
6+50	650	0	59	1	0	0	0	0	0
6+73	673	23	64	0	52	0	52	0	52
7+00	700	27	51	1	58	1	110	1	109
7+22	722	22	56	1	44	1	154	3	152
7+50	750	28	44	3	51	2	205	5	200
7+61	761	11	60	0	20	1	225	6	219
7+67	767	6	54	0	13	0	238	6	232
8+00	800	33	43	3	60	2	298	9	289
8+22	822	22	53	2	38	2	336	11	325
8+50	850	28	58	1	58	2	394	14	380
8+52	852	2	57	1	3	0	397	14	383
9+00	900	48	27	8	76	8	473	24	449
9+13	913	13	49	3	18	2	491	26	465
9+50	950	37	71	0	83	2	574	29	545
9+60	960	10	76	0	26	0	600	29	571
9+75	975	16	77	0	44	0	644	29	615
9+90	990	14	68	0	39	Ö	683	29	654
10+00	1000	10	56	1	24	0	707	29	678
10+50	1050	50	58	0	105	1	812	30	782
10+30	1075	25	70	0	59	0	871	30	841
11+00	1100	25	60	1	60	0	931	30	901
11+50	1150	50	69	1	120	1	1051	31	1020
11+63	1163	13	80	1	35	0	1051	31	1020
		37		1	98	1		33	
12+00	1200	50	62 73	0		1	1184	33 34	1152
12+50	1250 1266	16	83	0	126 47	0	1310 1357	34	1276 1323
12+66				1		0			
13+00	1300	34	63	2	92		1449	34	1415
13+50	1350	50	61		115	3	1564	38	1527
14+00	1400	50	61	1	113	3	1677	41	1636
14+50	1450	50	61	2	112	3	1789	45	1744
15+00	1500	50	59	1	111	2	1900	48	1853
15+50	1550	50	76	0	125	1	2025	49	1976
15+76	1576	26	92	0	82	0	2107	49	2058
16+00	1600	24	75	0	73	0	2180	49	2131
16+50	1650	50	81	0	144	0	2324	49	2275
17+00	1700	50	84	0	153	0	2477	49	2428
17+50	1750	50	88	0	159	0	2636	49	2587
18+00	1800	50	91	0	165	0	2801	49	2752
18+50	1850	50	98	0	175	0	2976	49	2927
18+61	1861	11	106	0	41	0	3017	49	2968
19+00	1900	39	101	0	151	0	3168	49	3119
19+26	1926	26	115	0	105	0	3273	49	3224
19+50	1950	24	88	0	89	0	3362	49	3313
20+00	2000	50	61	0	138	0	3500	49	3451
20+12	2012	12	57	0	26	0	3526	49	3477
20+20	2020	8	53	0	16	0	3542	49	3493
20+50	2050	30	69	0	68	0	3610	49	3561
20+55	2055	5	68	0	12	0	3622	49	3573
21+00	2100	45	51	0	99	0	3721	49	3672
21+16	2116	16	54	0	31	0	3752	49	3703
21+24	2124	8	54	0	16	0	3768	49	3719
21+39.50	2139.50	16	47	0	29	0	3797	49	3748
					3,797	39			

NOTES:	
1 - CUT	CUT INCLUDES SALVAGED/UNUSABLE PAVEMENT MATERIAL. SALVAGED/UNUSABLE PAVEMENT MATERIAL IS CALCULATED ON THE SECTION 3 SUMMARY SHEET.
	FILL DOES NOT INCLUDE UNUSABLE PAVEMENT AREA/VOLUME. SALVAGED/UNUSABLE PAVEMENT MATERIAL IS CALCULATED ON THE SECTION 3 SUMMARY SHEET.
3 - EXPANDED FILL	(UNEXPANDED MATERIAL)*(EXPANSION FACTOR)
4 - MASS ORDINATE	CUT - (EXPANDED FILL); POSITIVE INDICATES AN EXCESS OF MATERIAL; NEGATIVE INDICATES A SHORTAGE OF MATERIAL

9

COUNTY: MARATHON SHEET HWY: WEST WAUSAU AVE Ε PROJECT NO: 6999-00-76 EARTHWORK DATA


FILE NAME : P:\56XX\5607.DP.23.WAUSAU-AVE.MAR\CADDS\69990076\SHEETS\090101-EW.DWG LAYOUT NAME - 01


PLOT DATE : 4/14/2025 3:54 PM


PLOT BY: PARKER TISCHAUSER


PLOT NAME :


PLOT SCALE : 1" = 1'

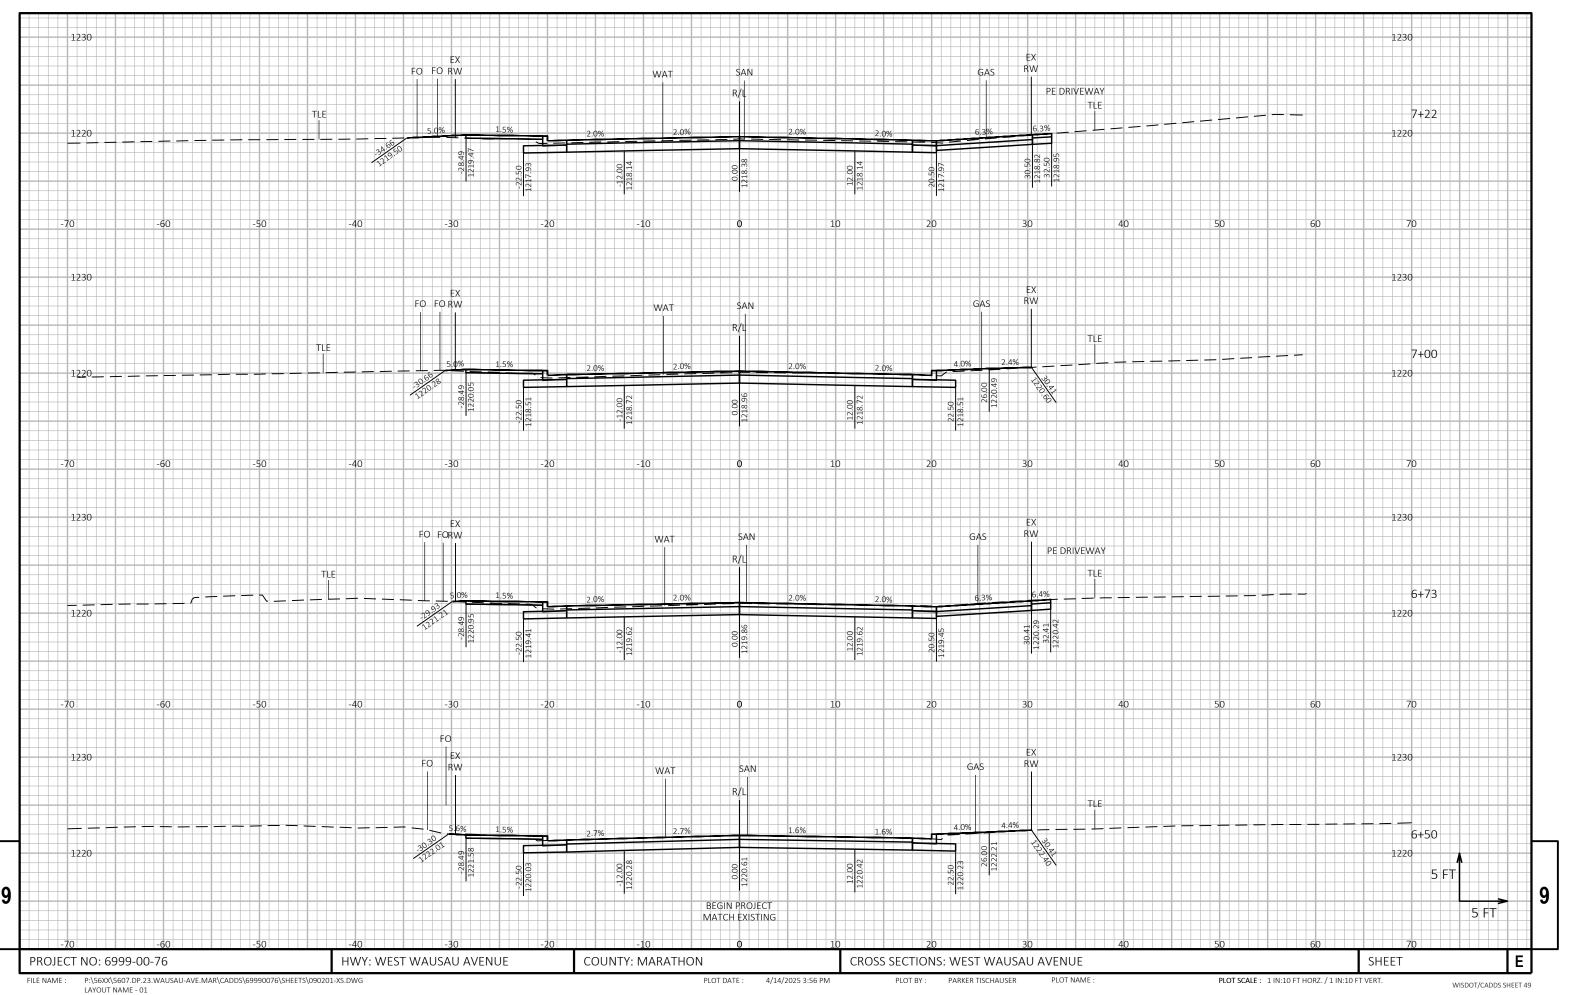


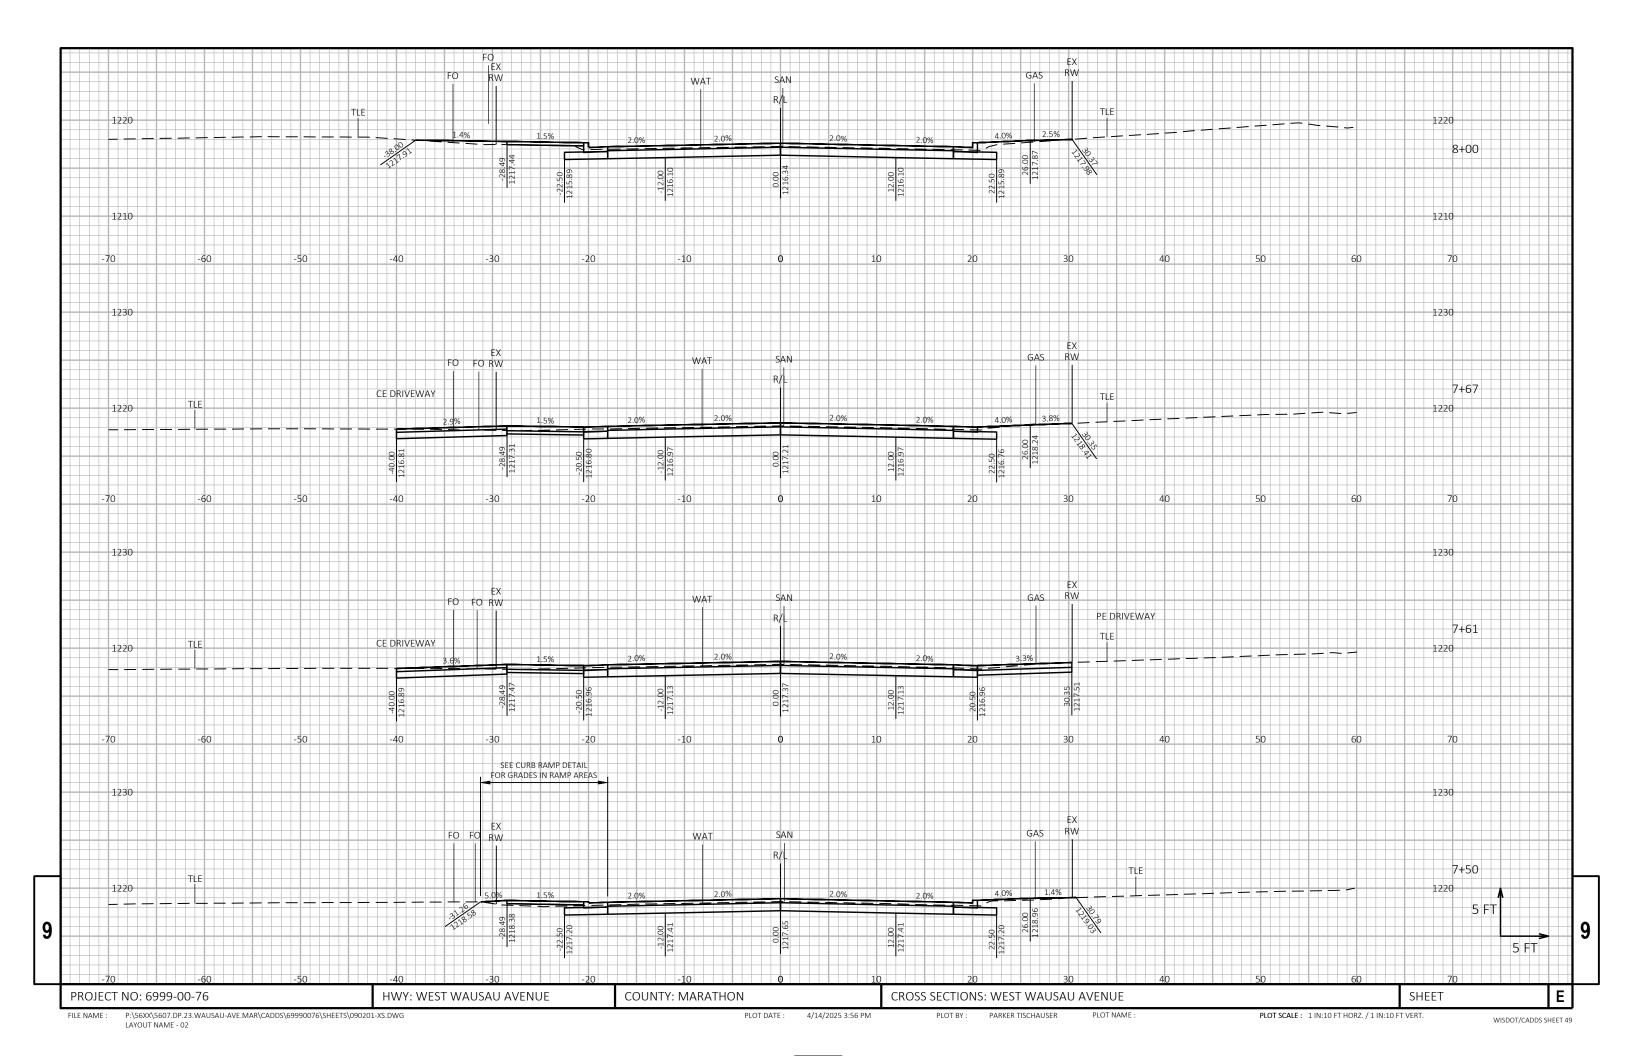


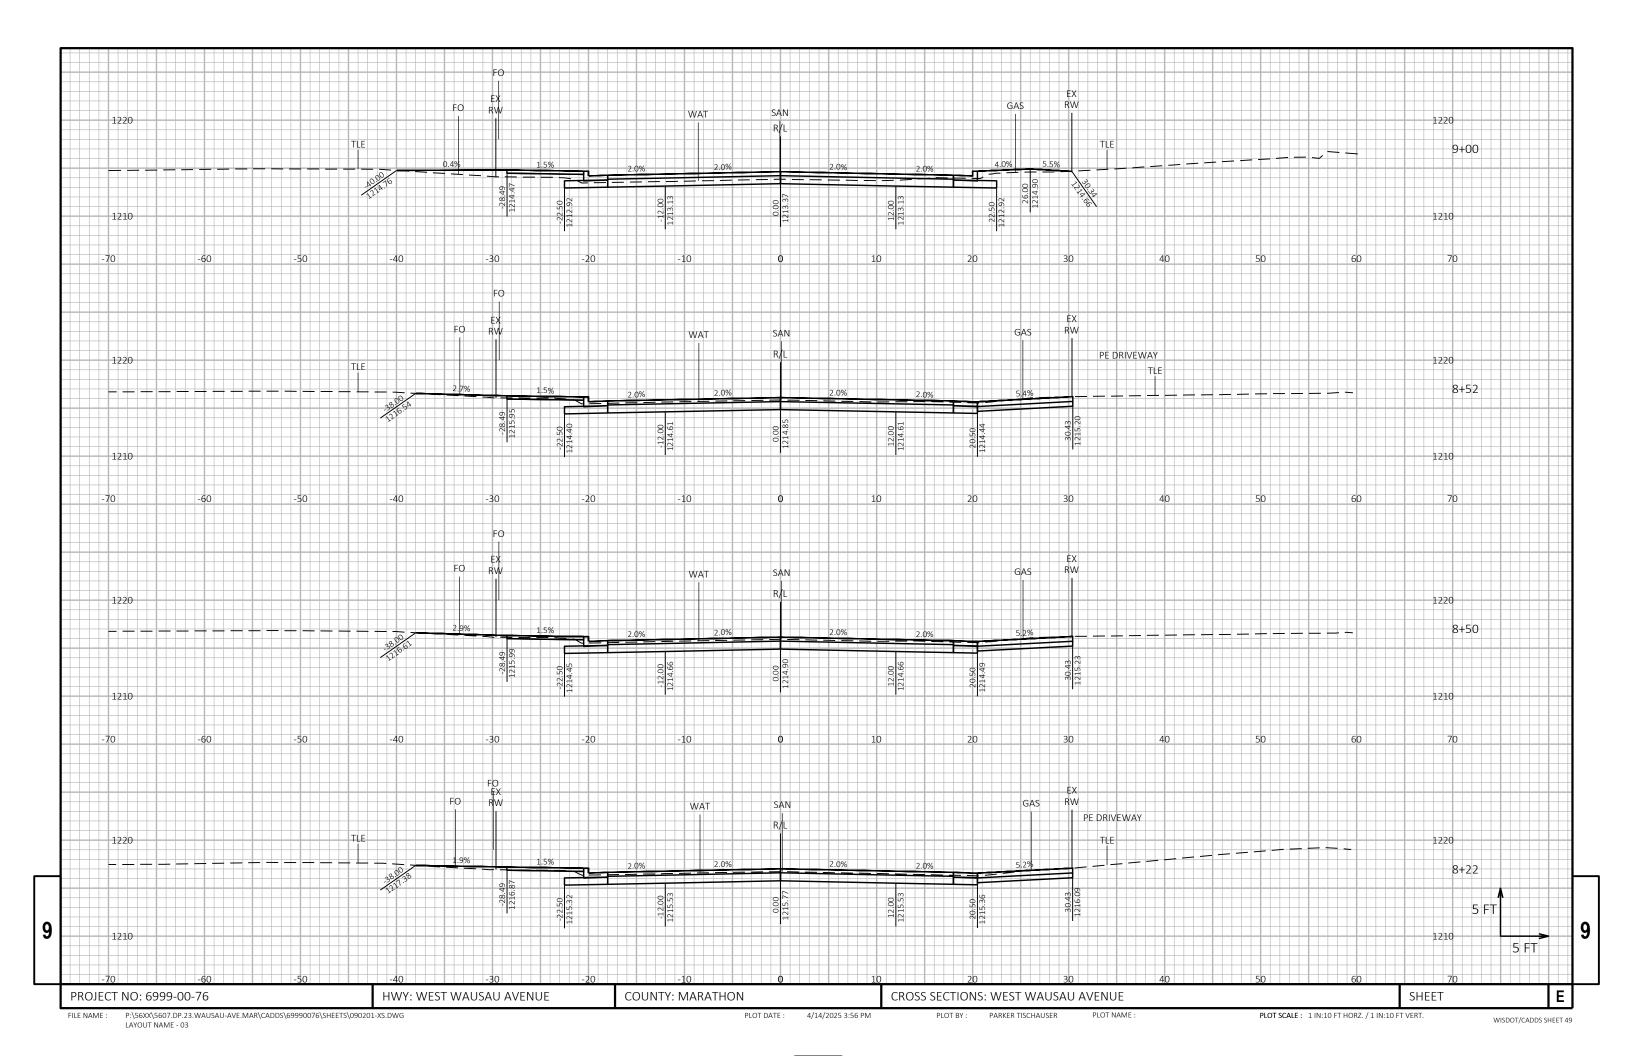


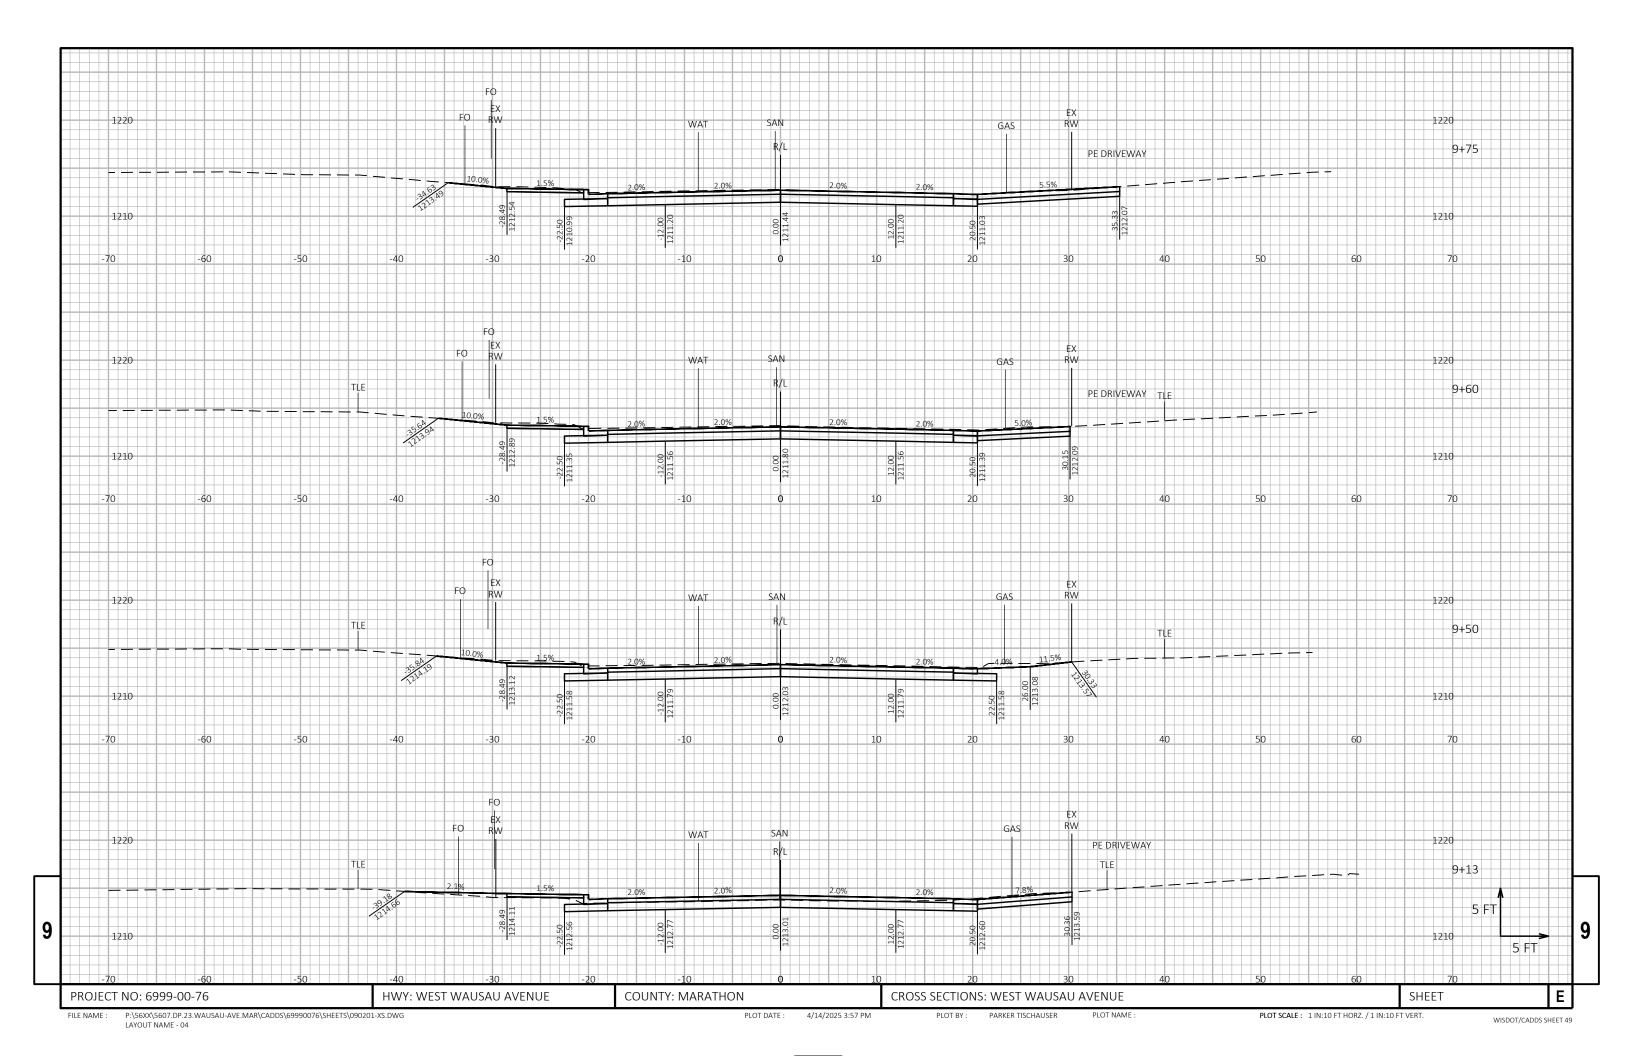


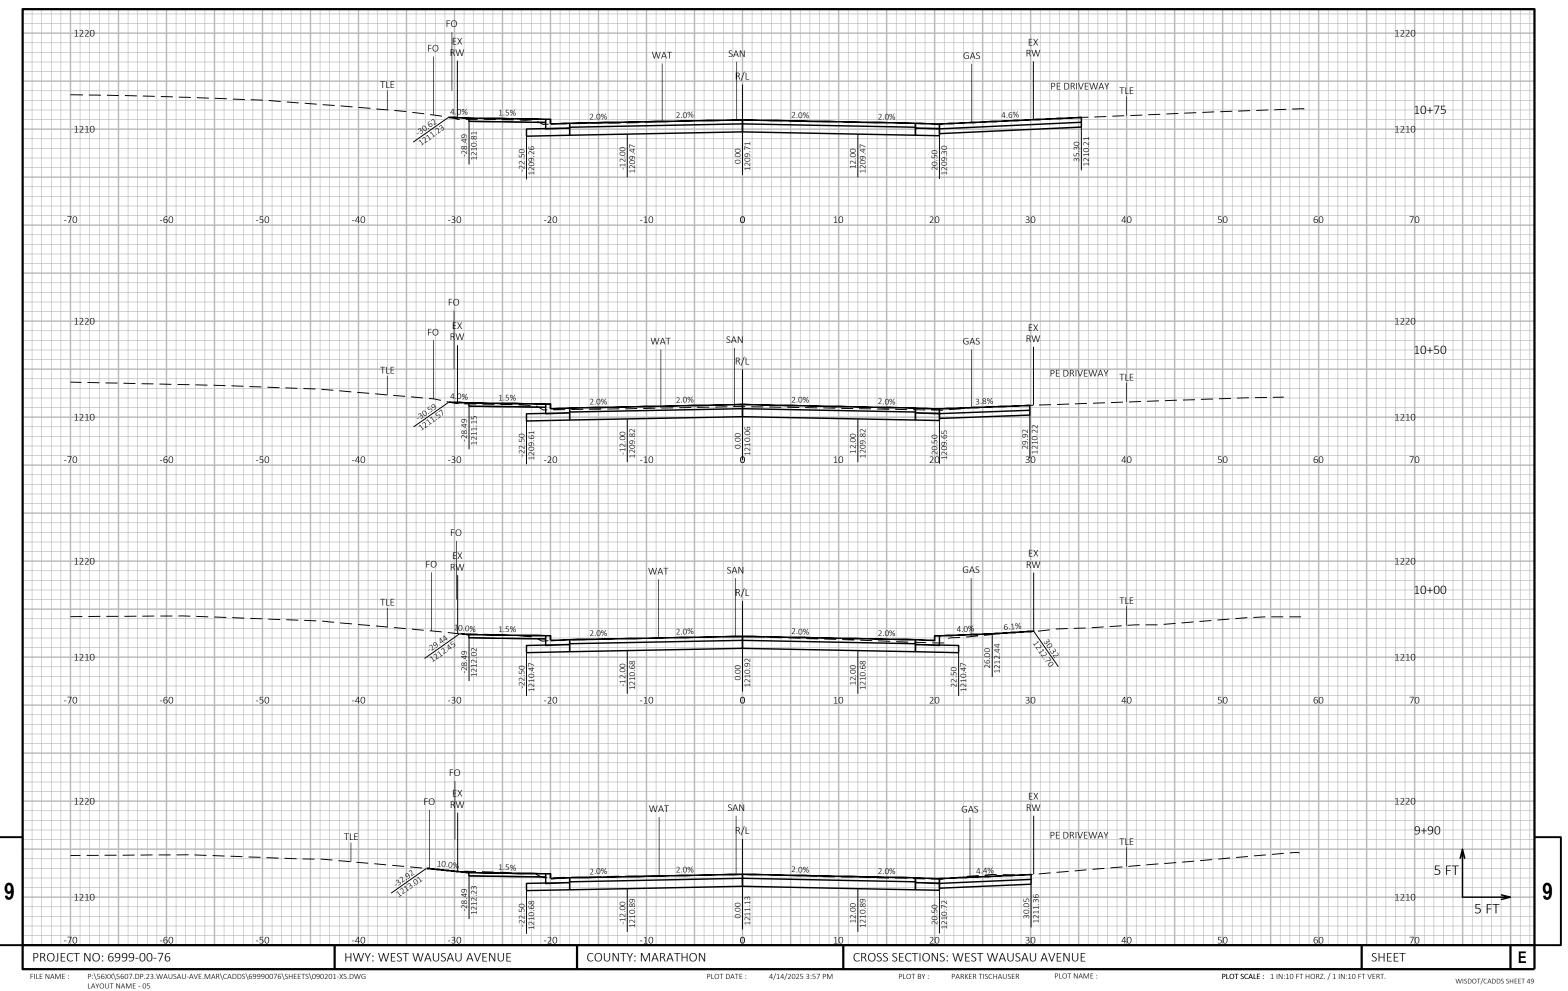


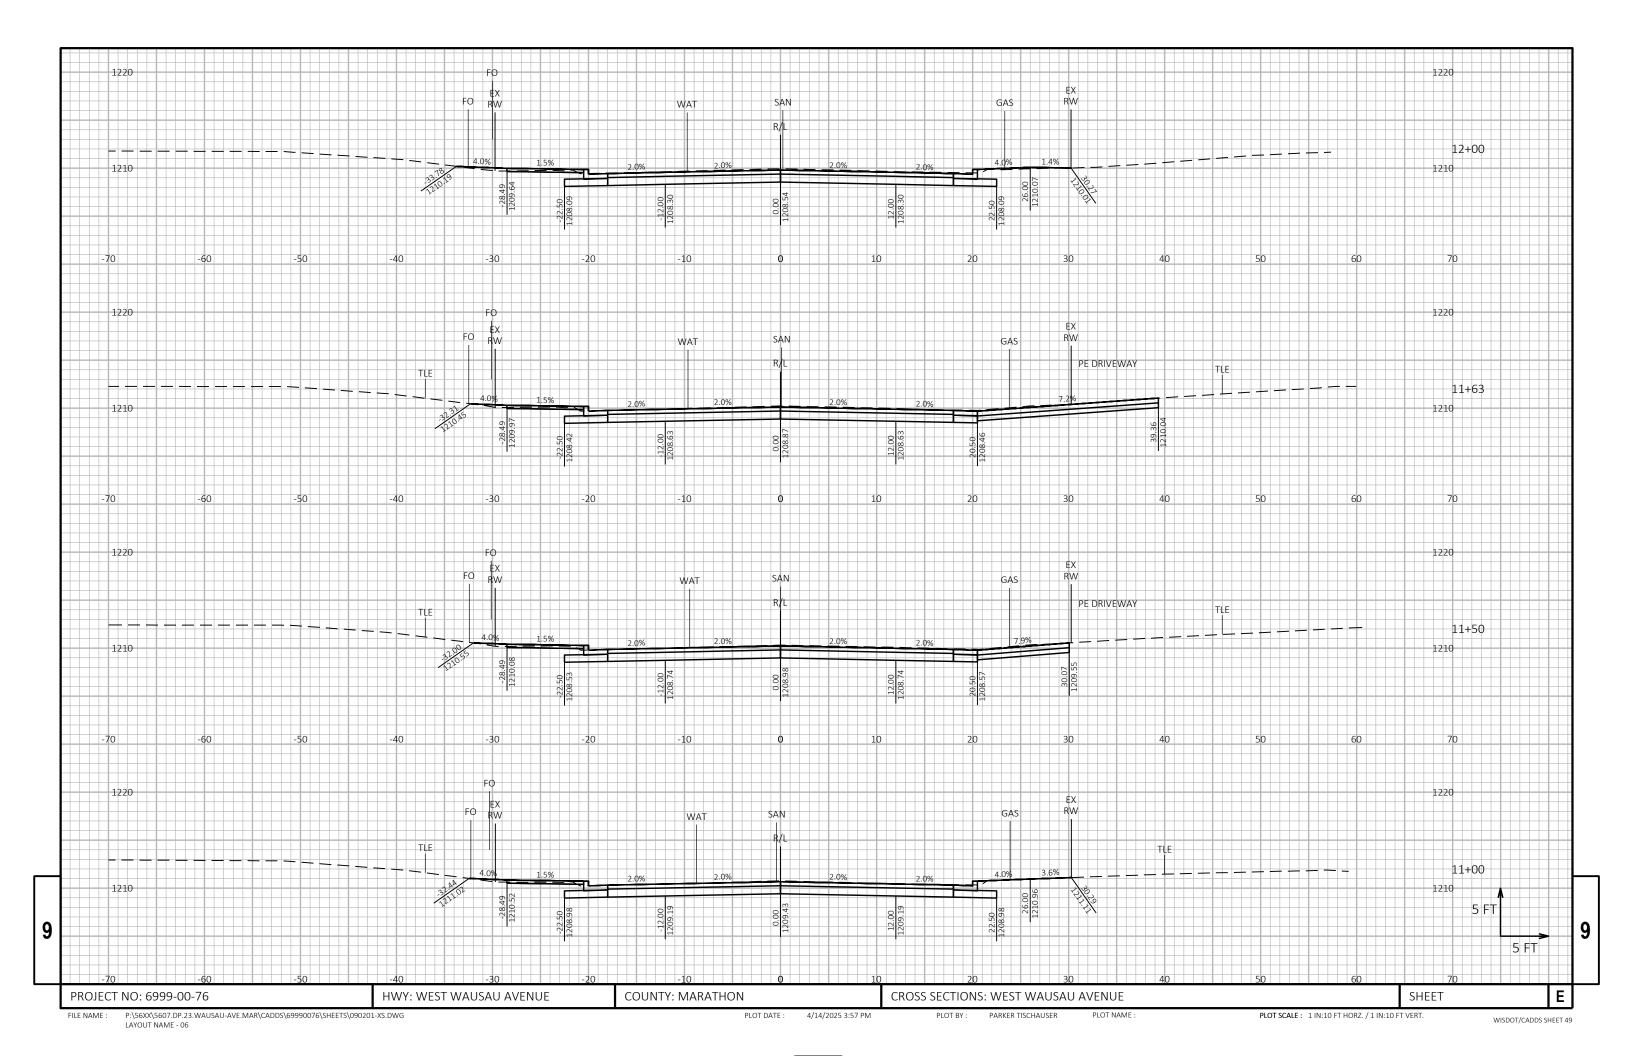


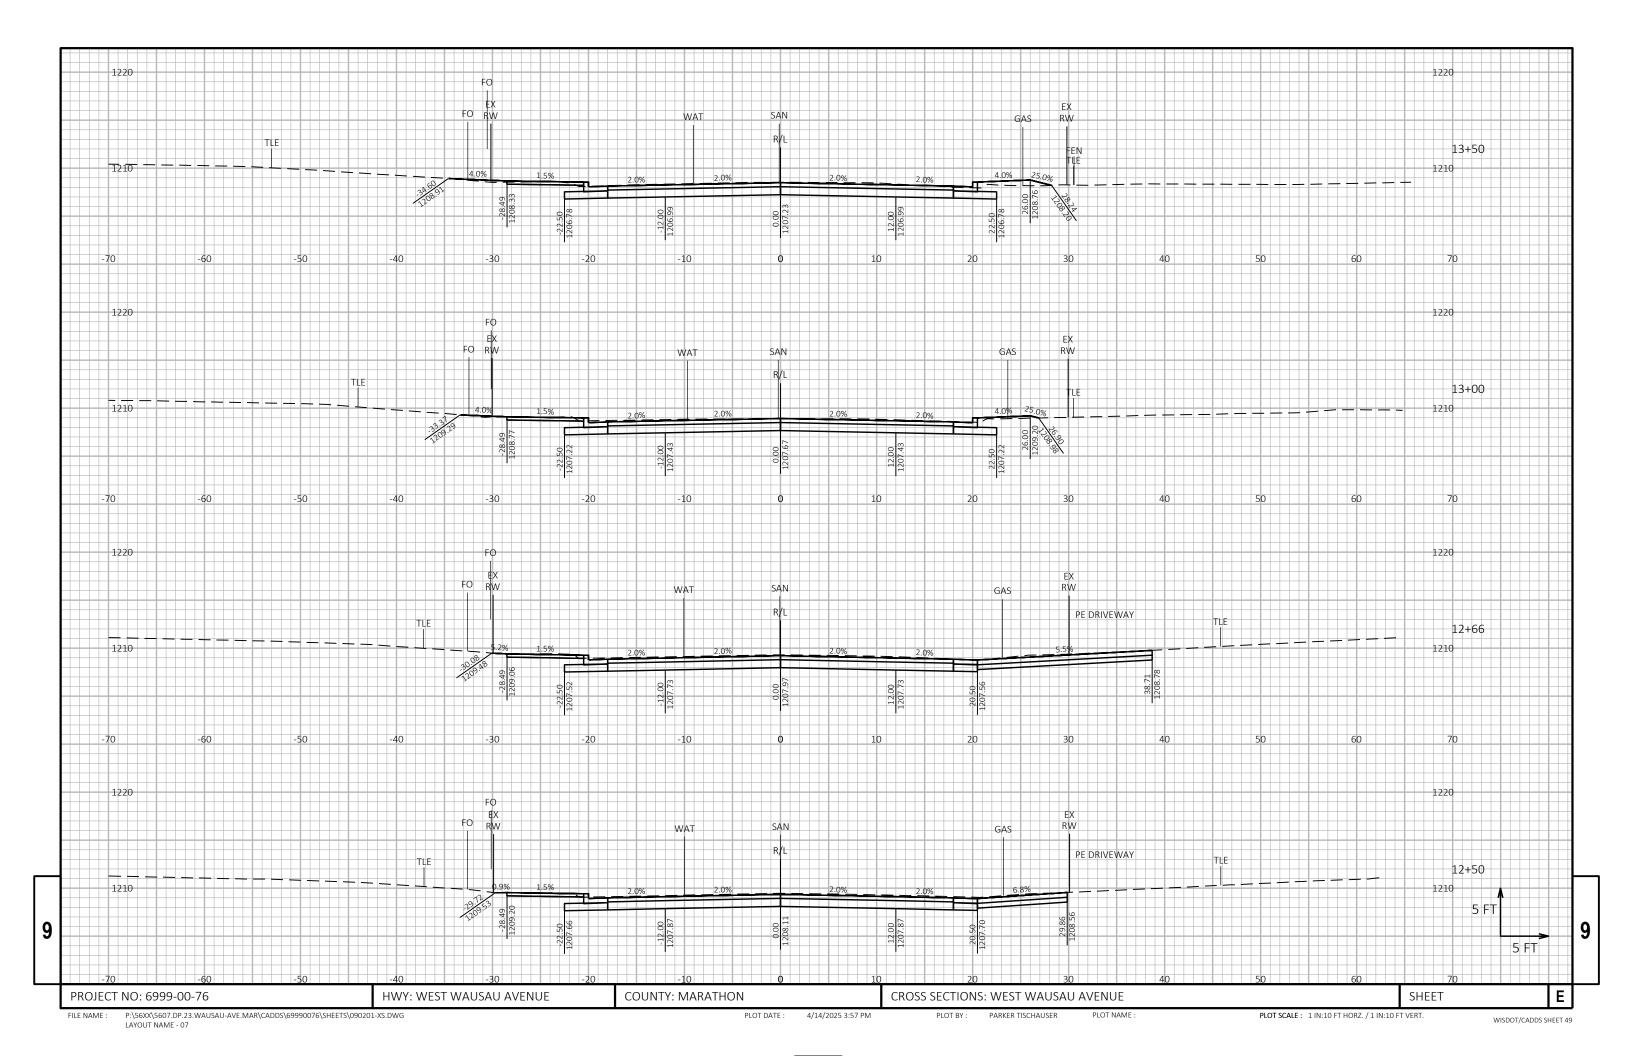


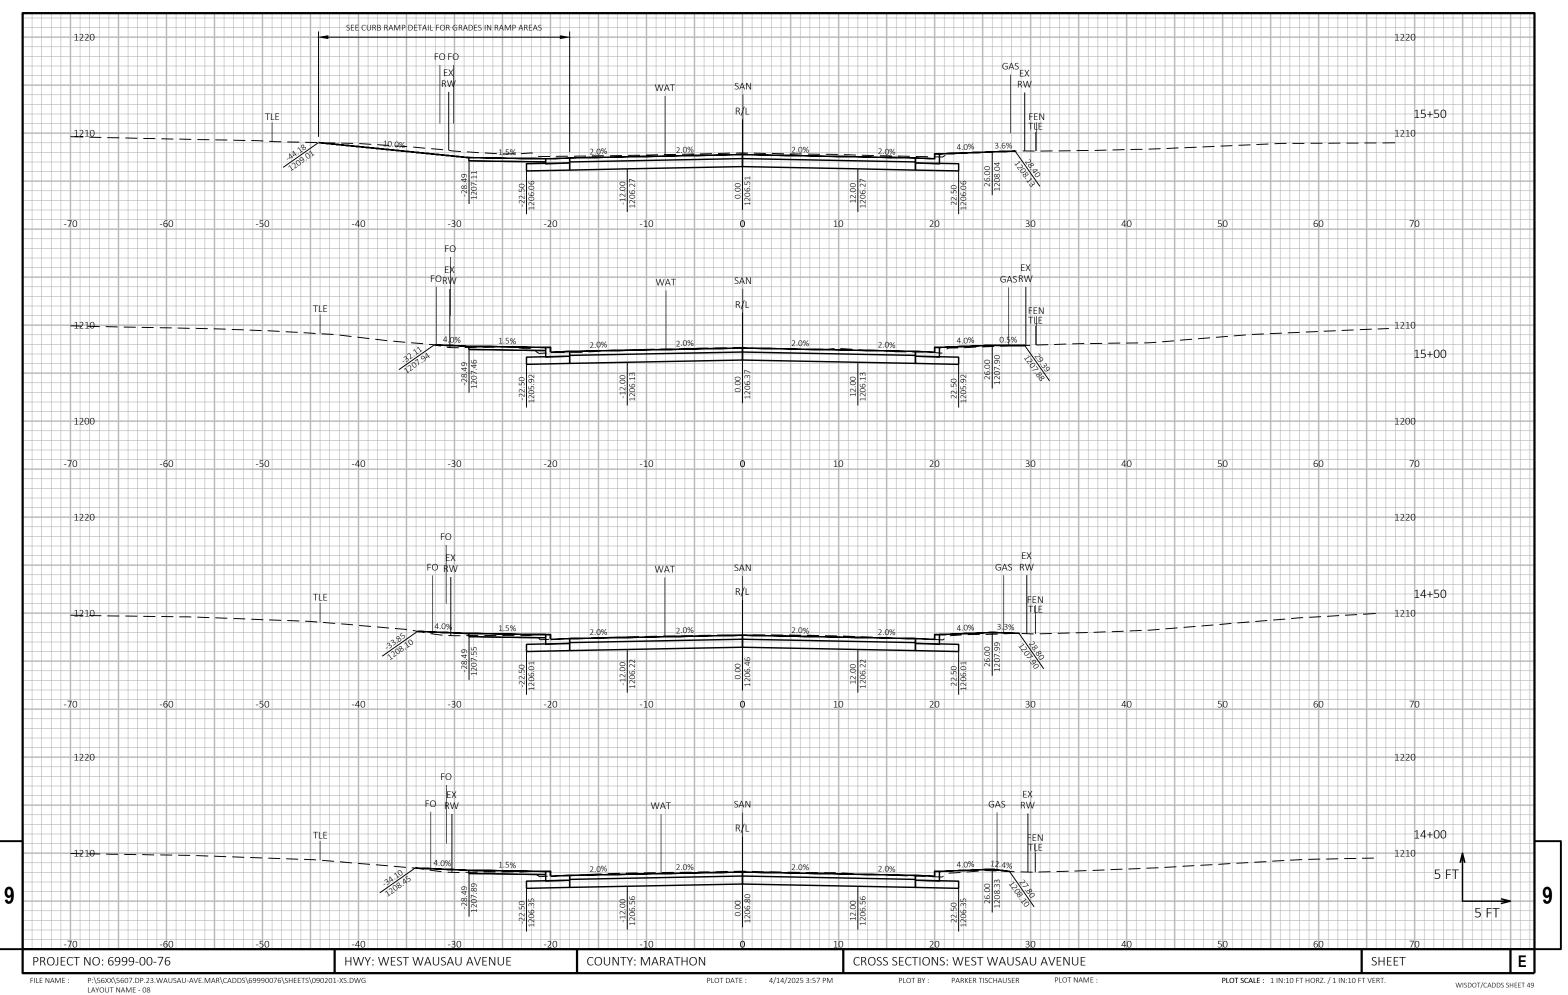


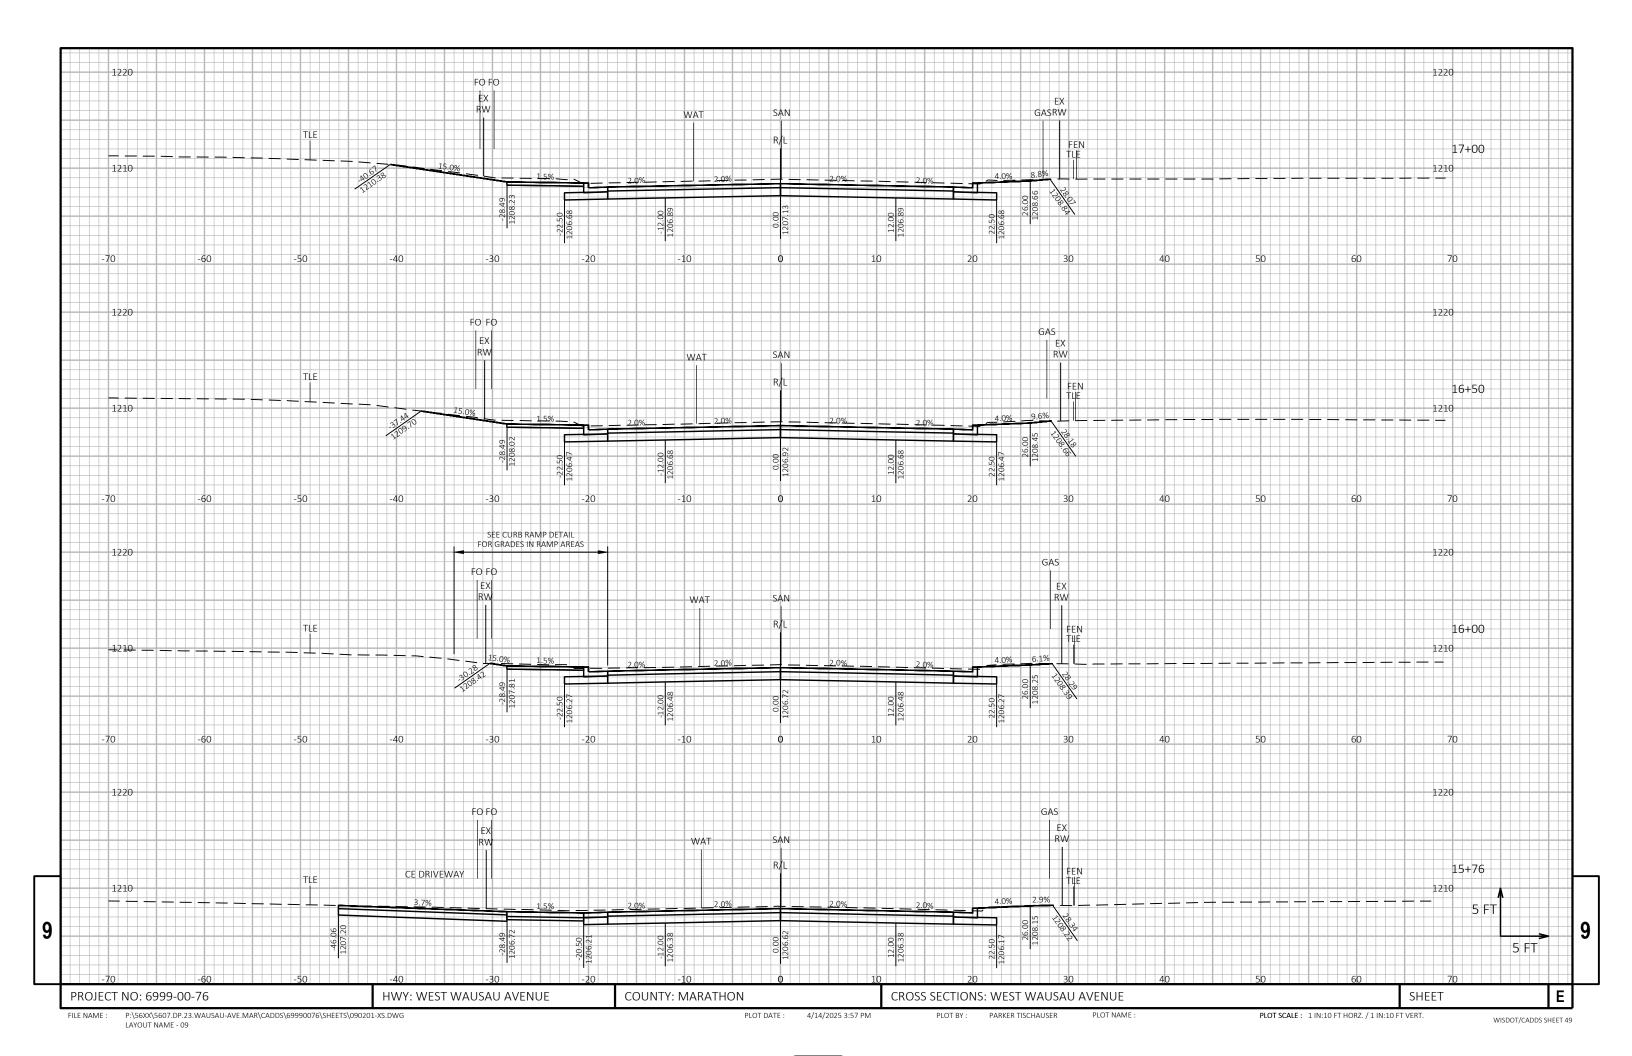

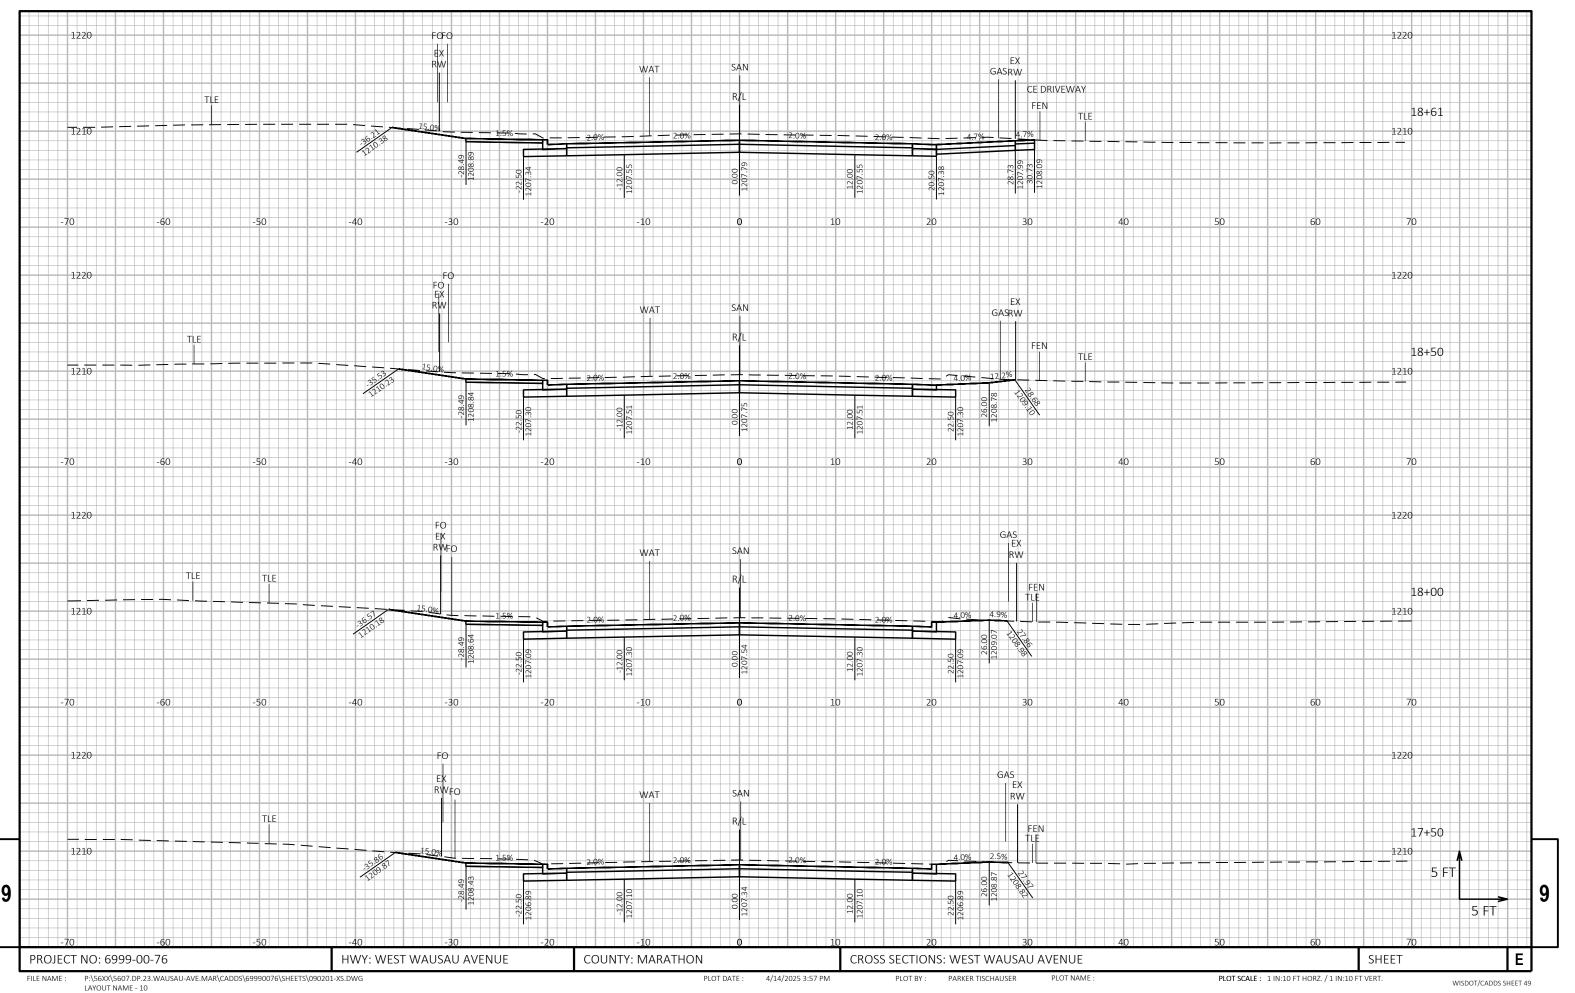

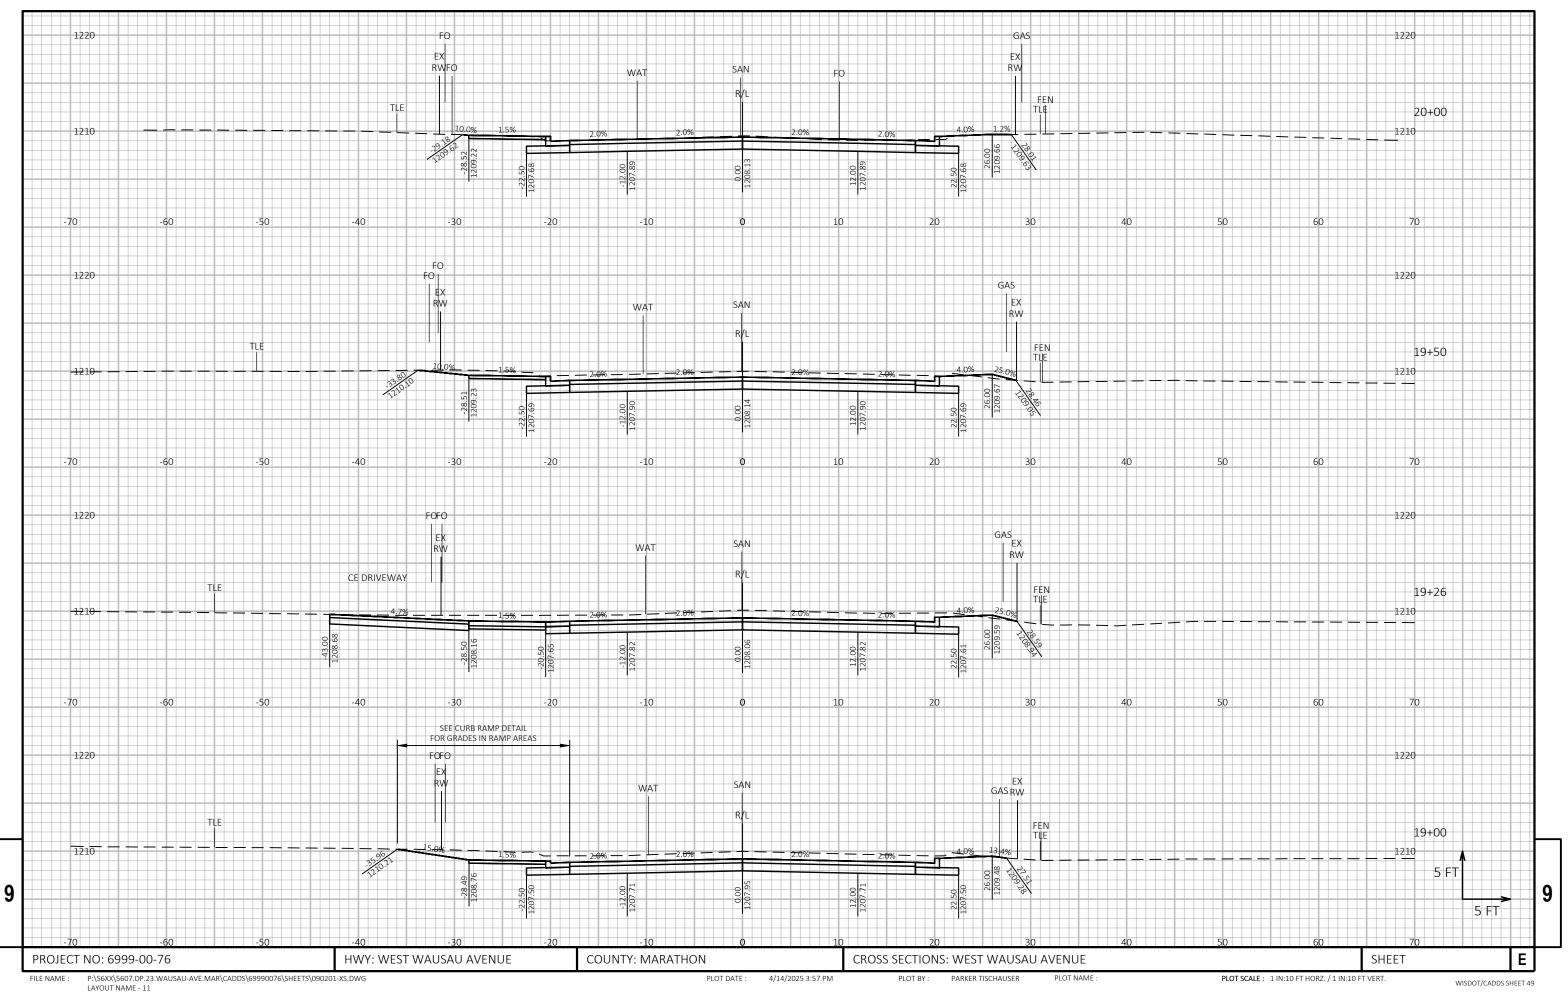

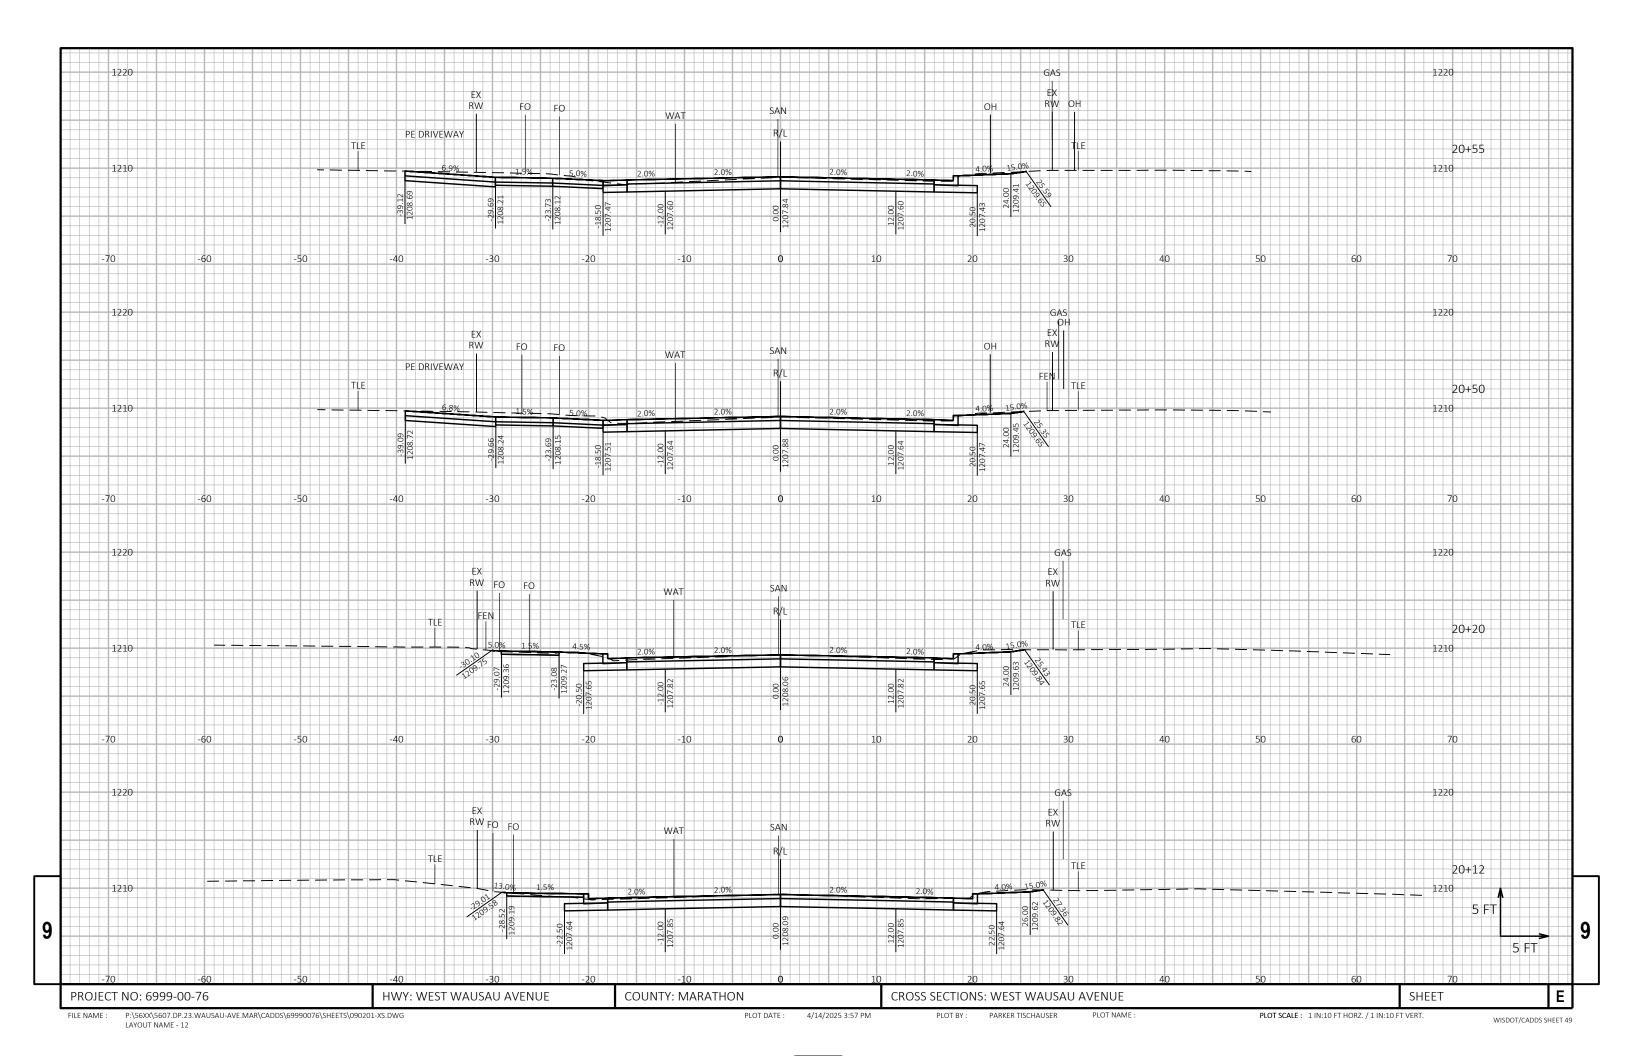

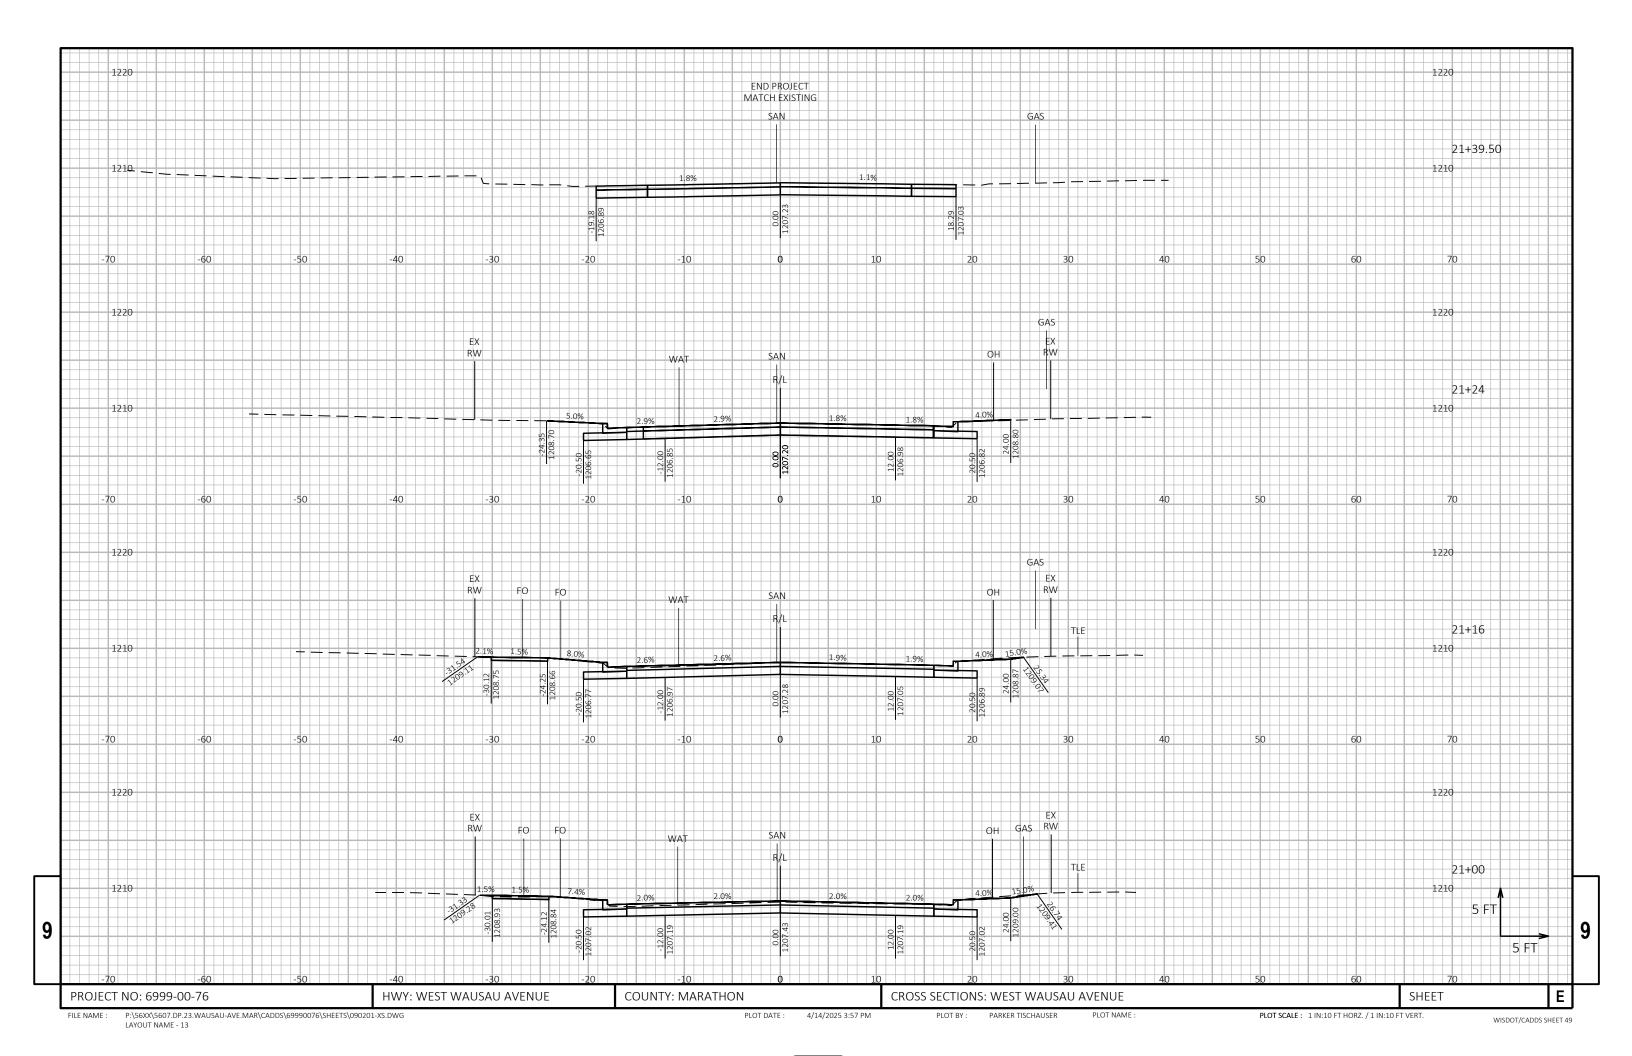

Notes



Wisconsin Department of Transportation

Dedicated people creating transportation solutions through innovation and exceptional service.

http://www.dot.wisconsin.gov