SEPTEMBER 2025 ORDER OF SHEETS

Typical Sections and Details Estimate of Quantities Miscellaneous Quantities Section No. Plan and Profile Section No. Standard Detail Drawings Section No. Cross Sections

TOTAL SHEETS = 52

DESIGN DESIGNATION

A.A.D.T. A.A.D.T. DHV. = 170 D.D. = 50/50 = 15.9% DESIGN SPEED = 35 MPH

CONVENTIONAL SYMBOLS

PLAN		PROFILE	
CORPORATE LIMITS	1//////	GRADE LINE	
PROPERTY LINE		ORIGINAL GROUND	_ ^ _ \
LOT LINE		MARSH OR ROCK PROFILE (To be noted as such)	_ ROCK
LIMITED HIGHWAY EASEMENT	L	SPECIAL DITCH	LABEL
EXISTING RIGHT OF WAY PROPOSED OR NEW R/W LINE		GRADE ELEVATION	95.36
SLOPE INTERCEPT		CULVERT (Profile View)	0 □
REFERENCE LINE	300,EB,	UTILITIES	
EXISTING CULVERT		ELECTRIC	— Е —
PROPOSED CULVERT		FIBER OPTIC	—— FO ——
(Box or Pipe)		GAS	G
COMBUSTIBLE FLUIDS	M	SANITARY SEWER	SAN
COMIBOSTIBLE FLOIDS	-caution>	STORM SEWER	—— SS ——
	/ '	TELEPHONE	— r —
MARSH AREA	(===)	WATER	—— w ——
	(UTILITY PEDESTAL	Ħ
	~~~~~~~	POWER POLE	4
WOODED OR SHRUB AREA	ę ż	TELEPHONE POLE	Ø

## STATE OF WISCONSIN **DEPARTMENT OF TRANSPORTATION**


PLAN OF PROPOSED IMPROVEMENT

## C NEW LISBON, W BRIDGE STREET

LEER STREET TO RIVER STREET

### LOC STR JUNEAU COUNTY

STATE PROJECT NUMBER 5829-00-72

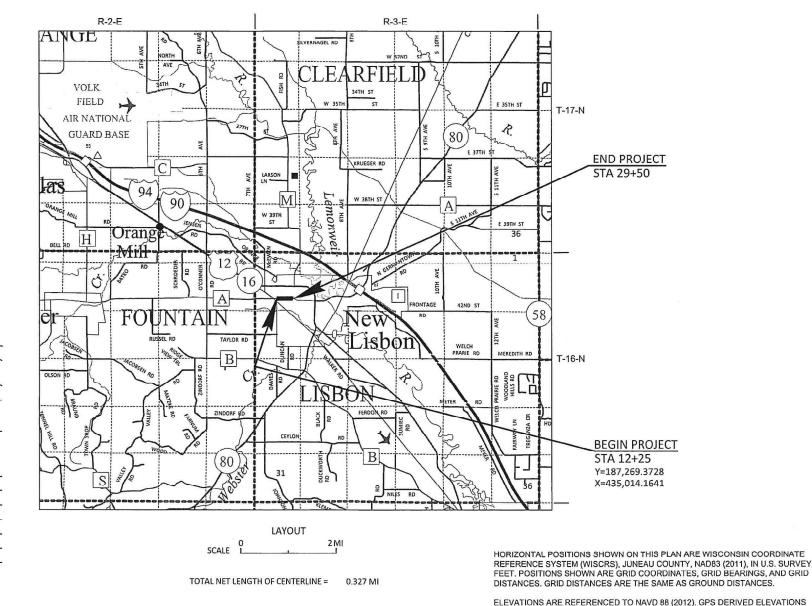

**FEDERAL PROJECT** STATE PROJECT **PROJECT** CONTRACT 5829-00-72 WISC 2025594

ACCEPTED FOR

CITY OF NEW LISBON

ORIGINAL PLANS PREPARED BY



SEH 329 Jay Street, Suite 301 La Crosse, WI 54601-4007 Short Elliott Hendrickson Inc. Iding a Better World 608.782.3161 main | 888.908.8166 fax

for All of Us™ www.sehinc.com BURG 45000-6 BROWNSVILLE

STATE OF WISCONSIN DEPARTMENT OF TRANSPORTATION

KYLE HEMP P.E.

4/22/2025

ARE BASED ON GEOID 12A.

CWT

HUNDREDWEIGHT

#### STANDARD ABBREVIATIONS

ABUT **ABUTMENT** HYD HYDRANT AC ACRE ID **INSIDE DIAMETER** AGGREGATE AGG INVFRT INV APRON ENDWALL FOR CULVERT PIPE **IRON PIPE ON PIN AECPRC** REINFORCED CONCRETE LHF LEFT-HAND FORWARD APRON ENDWALL FOR CULVERT PIPE LENGTH OF CURVE **AECPCS CORRUGATED STEEL** LINEAR FOOT **ASPH ASPHALTIC** LONG CHORD OF CURVE 1 C AVG AVERAGE LS LUMP SUM AVERAGE DAILY TRAFFIC ADT МН MANHOLE BF **BACK FACE** MID POINT OF RADIUS MOR ВМ BENCH MARK NC NORMAL CROWN BR BRIDGE NO NUMBER CE COMMERCIAL ENTRANCE OBLITERATE **OBLIT** C/L CENTER LINE **PAVT PAVEMENT** Δ CENTRAL ANGLE OR DELTA PE PRIVATE ENTRANCE COB CENTER OF BARRIER PVRC POINT OF VERTICAL REVERSE CURVE CONC CONCRETE QUARTER POINT OF RADIUS QOR CULVERT PIPE REINFORCED CONCRETE **CPRC** RADIUS CULVERT PIPE REINFORCED CONCRETE **CPRCHE** REQ'D REQUIRED HORIZONTAL ELLIPTICAL RESIDENCE OR RESIDENTIAL RES CR CRFFK RIGHT-HAND FORWARD RHF CUBIC YARD CY R/W RIGHT-OF-WAY C&G **CURB AND GUTTER** RIVER D **DEGREE OF CURVE** RDWY ROADWAY **DESIGN HOUR VOLUME** DHV REFERENCE LINE R/L DISCH DISCHARGE SALV SALVAGED DG **DITCH GRADE** SAN **SANITARY SEWER** DWY DRIVEWAY SF SOUARE FEET FAST GRID COORDINATE Х SQUARE YARD STEEL PLATE BEAM GUARD ENERGY SY EAT SDD STANDARD DETAIL DRAWINGS ABSORBING TERMINAL **EOR END POINT OF RADIUS** STA **STATION ELEVATION** STORM SEWER EL SS STORM SEWER PIPE REINFORCED **ENTRANCE** FNT **SSPRC** CONCRETE **ESALS EQUIVALENT SINGLE AXLE LOADS** SE SUPERELEVATION RATE FXC **EXCAVATION** TC TOP OF CURB **EXCAVATION BELOW SUBGRADE** EBS T OR TN TOWN **EXIST EXISTING** FACE OF CURB TRUCKS (PERCENT OF) FC TYP TYPICAL FF **FACE TO FACE** VARIABLE **FERT** FERTILIZE VAR VC VERTICAL CURVE FE FIELD ENTRANCE NORTH GRID COORDINATE FLOW LINE YD YARD FO FIBER OPTIC

#### RUNOFF COEFFICIENT TABLE

		HYDROLOGIC SOIL GROUP											
		A			В			С			D		
	SLOPE RANGE (PERCENT)			SLOPE RANGE (PERCENT)			SLOPE RANGE (PERCENT)			SLOPERANGE (PERCENT)			
LAND USE:	0-2	2-6	6 & OVER	0-2	2-6	6 & OVER	0-2	2-6	6 & OVER	0-2	2-6	6 & OVER	
ROW CROPS	.08	.16 .30	.22 .38	.12 .26	.20 .34	.27 .44	.15 .30	.24 .37	.33 .50	.19 .34	.28 .41	.38 .56	
MEDIAN STRIP- TURF	.19 .24	.20 .26	.24 .30	.19 .25	.22 .28	.26 .33	.20 .26	.23 .30	.30 .37	.20 .27	.25 .32	.30 .40	
SIDE SLOPE- TURF			.25 .32			.27 .34			.28 .36			.30 .38	
PAVEMENT:			l.							•			
ASPHALT						.7095							
CONCRETE						.8095							
BRICK						.7080							
DRIVES, WALKS						.7585							
ROOFS						.7595							
GRAVEL ROADS, SH	OULDERS					.4060			-				

TOTAL PROJECT AREA = 3.0 ACRES

PROJECT NO:

OTAL AREA EXPECTED TO BE DISTURBED BY CONSTRUCTION ACTIVITIES = 1.7 ACRES

#### MUNICIPALITY CONTACT:

CITY OF NEW LISBON PUBLIC WORKS PO BOX 218 NEW LISBON, WI 53950 TELEPHONE: 608.562.521 ATTENTION: NICK WYSS EMAIL: NLDPW@MWT.NET

SOUTHWEST REGION 2101 WRIGHT STREET, MADISON, WI 53704 TELEPHONE: 608.246.7963 ATTENTION: DELLA KOENIG EMAIL: DELLA.KOENIG@DOT.WI.GOV

WISDOT CONTACT:

WISCONSIN DEPT OF TRANSPORTATION

#### **DESIGN CONTACT:**

SEH INC 329 JAY STREET, SUITE 301 LA CROSSE, WI 54601 TELEPHONE: 608.498.4804 ATTENTION: ALEIGHA BURG EMAIL: ABURG@SEHINC.COM

WI DEPT OF NATURAL RESOURCES DNR SERVICE CENTER 3550 MORMON COULEE RD LA CROSSE, WI 54601 TELEPHONE: 608.785.9115 ATTENTION: KAREN KALVELAGE EMAIL: KAREN.KALVELAGE@WISCONSIN.GOV

**DNR AREA LIAISON:** 

#### **UTILITY CONTACT LIST:**

**ALLIANT ENERGY - ELECTRICITY** 

388 EAST STATE ST MAUSTON, WI 53948 ATTENTION: TYLER DONOVAN TELEPHONE: (608) 963-9585

EMAIL: TYLERDONOVAN@ALLIANTENERGY.COM

EMAIL: TYLERDONOVAN@ALLIANTENERGY.COM

**ALLIANT ENERGY - GAS** 388 EAST STATE ST MAUSTON, WI 53948 ATTENTION: TYLER DONOVAN TELEPHONE: (608) 963-9585

AT&T - COMMUNICATIONS **70 E DIVISION ST** 

FOND DU LAC, WI 54935 ATTENTION: RICK PODOLAK TELEPHONE: (715) 410-0656 EMAIL: RP4514@ATT.COM

CITY OF NEW LISBON - ELECTRICITY 232 W PLEASANT ST

NEW LISBON, WI 53950-1378 ATTENTION: NICK WYSS TELEPHONE: (608) 562-5213 EMAIL: NLDPW@MWT.NET

CITY OF NEW LISBON - SEWER 232 W PLEASANT ST NEW LISBON, WI 53950-1378 ATTENTION: NICK WYSS TELEPHONE: (608) 562-5213 EMAIL: NLDPW@MWT.NET

CITY OF NEW LISBON - WATER 232 W PLEASANT ST NEW LISBON, WI 53950-1378 ATTENTION: NICK WYSS TELEPHONE: (608) 562-5213 EMAIL: NLDPW@MWT.NET

DAIRYLAND POWER COOPERATIVE - ELECTRICITY 3200 EAST AVENUE SOUTH P.O. BOX 817 LA CROSSE, WI 54602

ATTENTION: MIKE LYDON TELEPHONE: (608) 787-1381

EMAIL: MICHAEL.LYDON@DAIRYLANDPOWER.COM

LEMONWEIR VALLEY TELEPHONE -

COMMUNICATIONS 127 US HWY 12 P.O. BOX 267 CAMP DOUGLAS, WI 54618 ATTENTION: BEN GRILLEY TELEPHONE: (608) 542-0186 EMAIL: BEN.GRILLEY@GETLYNXX.COM

**MEDIACOM - COMMUNICATIONS** 1501 DIVISION STREET DECORAH, IA 52101 ATTENTION: CRAIG EGGERT TELEPHONE: (563) 419-5160 EMAIL: CEGGERT@MEDIACOMCC.COM

#### **GENERAL NOTES:**

- 1. NO TREES OR SHRUBS SHALL BE REMOVED WITHOUT APPROVAL OF THE ENGINEER.
- THE LOCATIONS OF EXISTING AND PROPOSED UTILITY INSTALLATIONS AS SHOWN ON THE PLANS ARE APPROXIMATE. THERE MAY BE OTHER UTILITY INSTALLATIONS WITHIN THE PROJECT AREA THAT ARE NOT SHOWN
- TRAFFIC CONTROL DEVICES SHALL BE ADJUSTED TO FIT FIELD CONDITIONS AS DIRECTED BY THE ENGINEER.
- 4. THE EROSION CONTROL FEATURES AS SHOWN IN THE PLANS ARE AT SUGGESTED LOCATIONS. EXACT LOCATIONS WILL BE DETERMINED BY THE ENGINEER IN THE FIELD.
- ASPHALTIC AND CONCRETE SURFACES SHALL BE SAWCUT AT THE MATCH LINE AS SHOWN ON THE PLAN OR AS DIRECTED BY THE ENGINEER.
- A CONVERSION FACTOR OF 2.0 TONS/CY IS USED TO ESTIMATE QUANTITIES FOR BASE
- APPLY TACK COAT AT A RATE OF 0.07 GAL/SY TO MILLED SURFACE AND 0.05 GA/SY BETWEEN LAYERS OF HMA PAVEMENT.
- HMA PAVEMENT WEIGHT CALCULATIONS ARE BASED ON 112 LB/SY/IN.
- THE CONTRACTOR'S PAVING OPERATIONS SHALL BE CONSISTENT WITH THE PLAN AND TYPICAL SECTIONS AND CONSTRUCTED TO PREVENT HMA LONGITUDINAL JOINTS FROM BEING LOCATED WITHIN A DRIVING, TURNING, PASSING OR PARKING LANE.

# Dial or (800)242-8511

www.DiggersHotline.com

#### **BORING LOG**

		ASPHALTIC			
BORING NO.	STATION	PAVEMENT BASE (IN		SUBBASE MATERIAI	
		DEPTH (IN)			
B-1	14+00	5.5	6.5	CLAY	
B-2	21+50	3	9	CLAY	
B-3	28+00	9	4	SAND	

5829-00-72

HWY: CTH A (W BRIDGE ST)

COUNTY: JUNEAU


**GENERAL NOTES** 


PLOT BY: SEH

LAYOUT NAME: 01

PLOT SCALE : N/A SHEET

WISDOT/CADDS SHEET 42

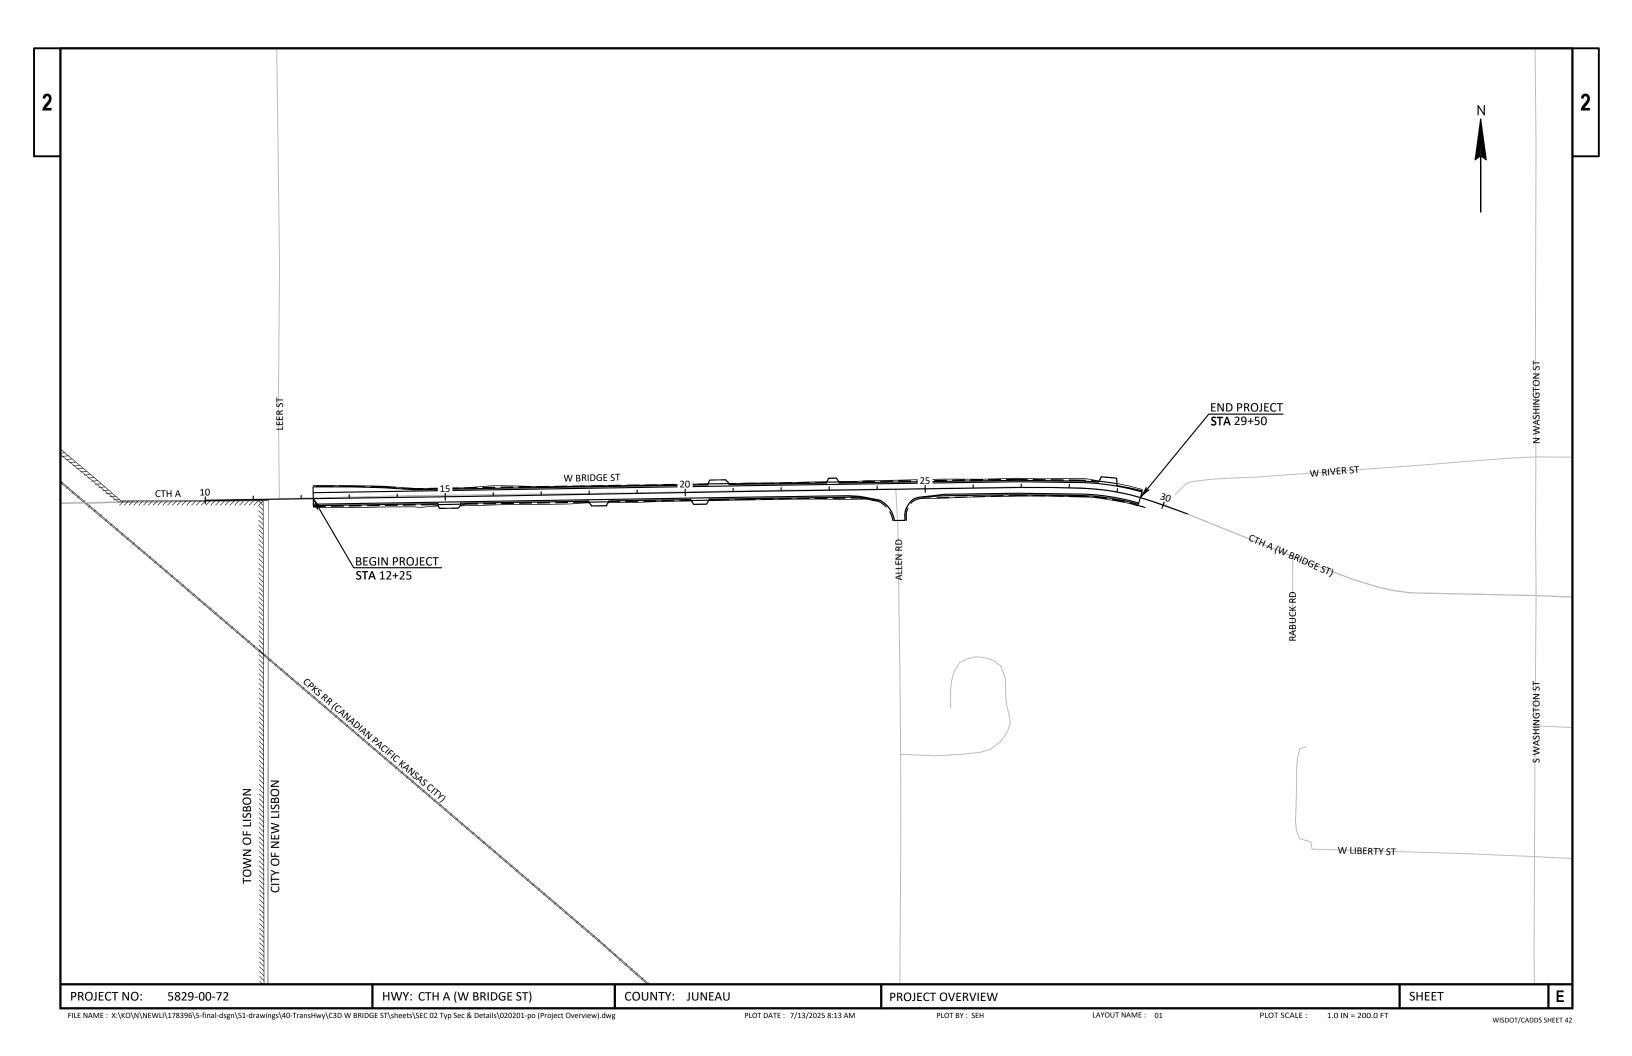

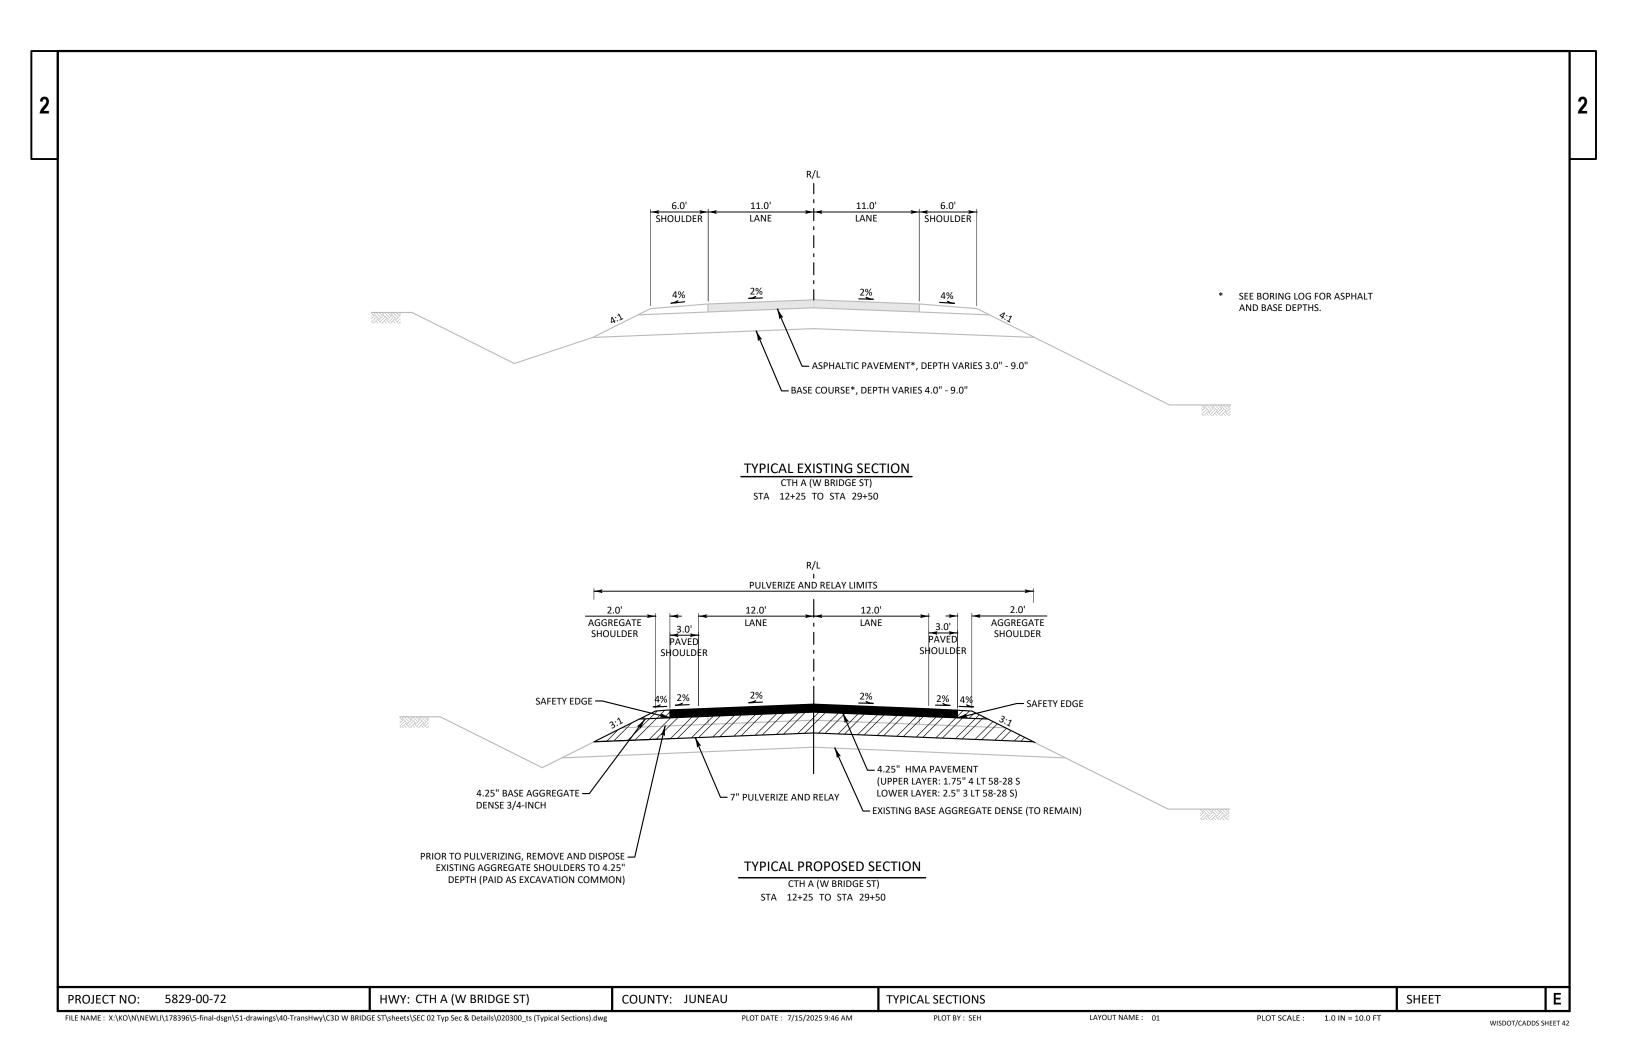


PROJECT NO:

5829-00-72


## ASPHALTIC SURFACE DRIVEWAYS AND FIELD ENTERANCES (PE,CE, OR FE)


DENSE REQUIRED SHALL BE PAID UNDER ITEM - "BASE AGGREGATE

DENSE 3/4-INCH".

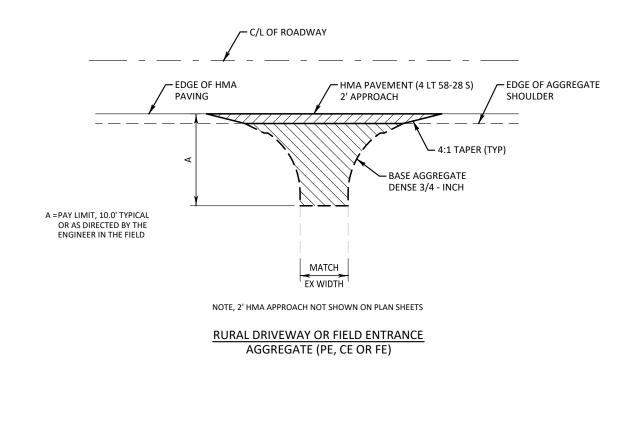

HWY: CTH A (WEST BRIDGE STREET)

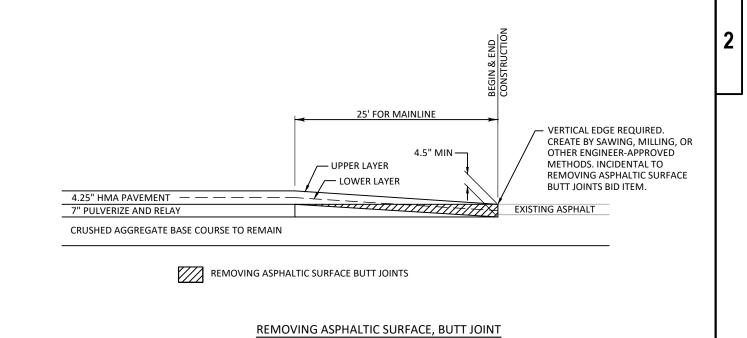

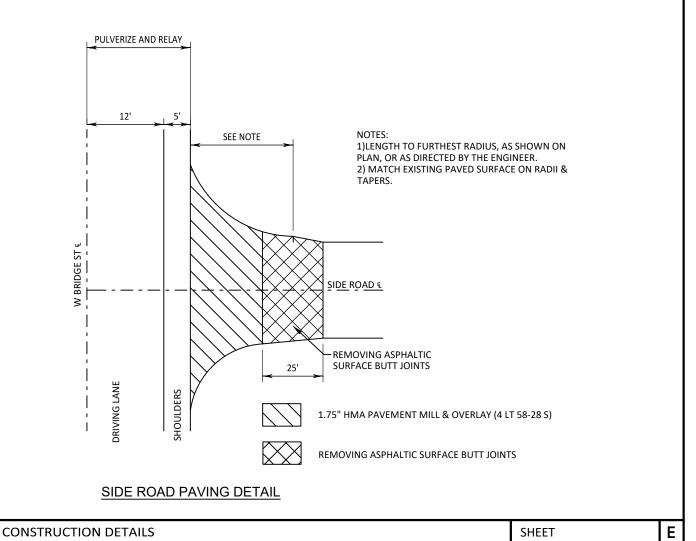

FILE NAME : X:\KO\N\NEWLI\178396\5-FINAL-DSGN\51-DRAWINGS\40-TRANSHWY\C3D W BRIDGE ST\SHEETS\SEC 02 TYP SEC & DETAILS\021001-CD (CONSTRUCTION DETAILS).DWG

COUNTY: JUNEAU


N DETAILS).DWG PLOT DATE: 7/13/2025 8:13 AM


PLOT BY: SEH


LAYOUT NAME: 01

PLOT SCALE: 1 IN:100 FT

WISDOT

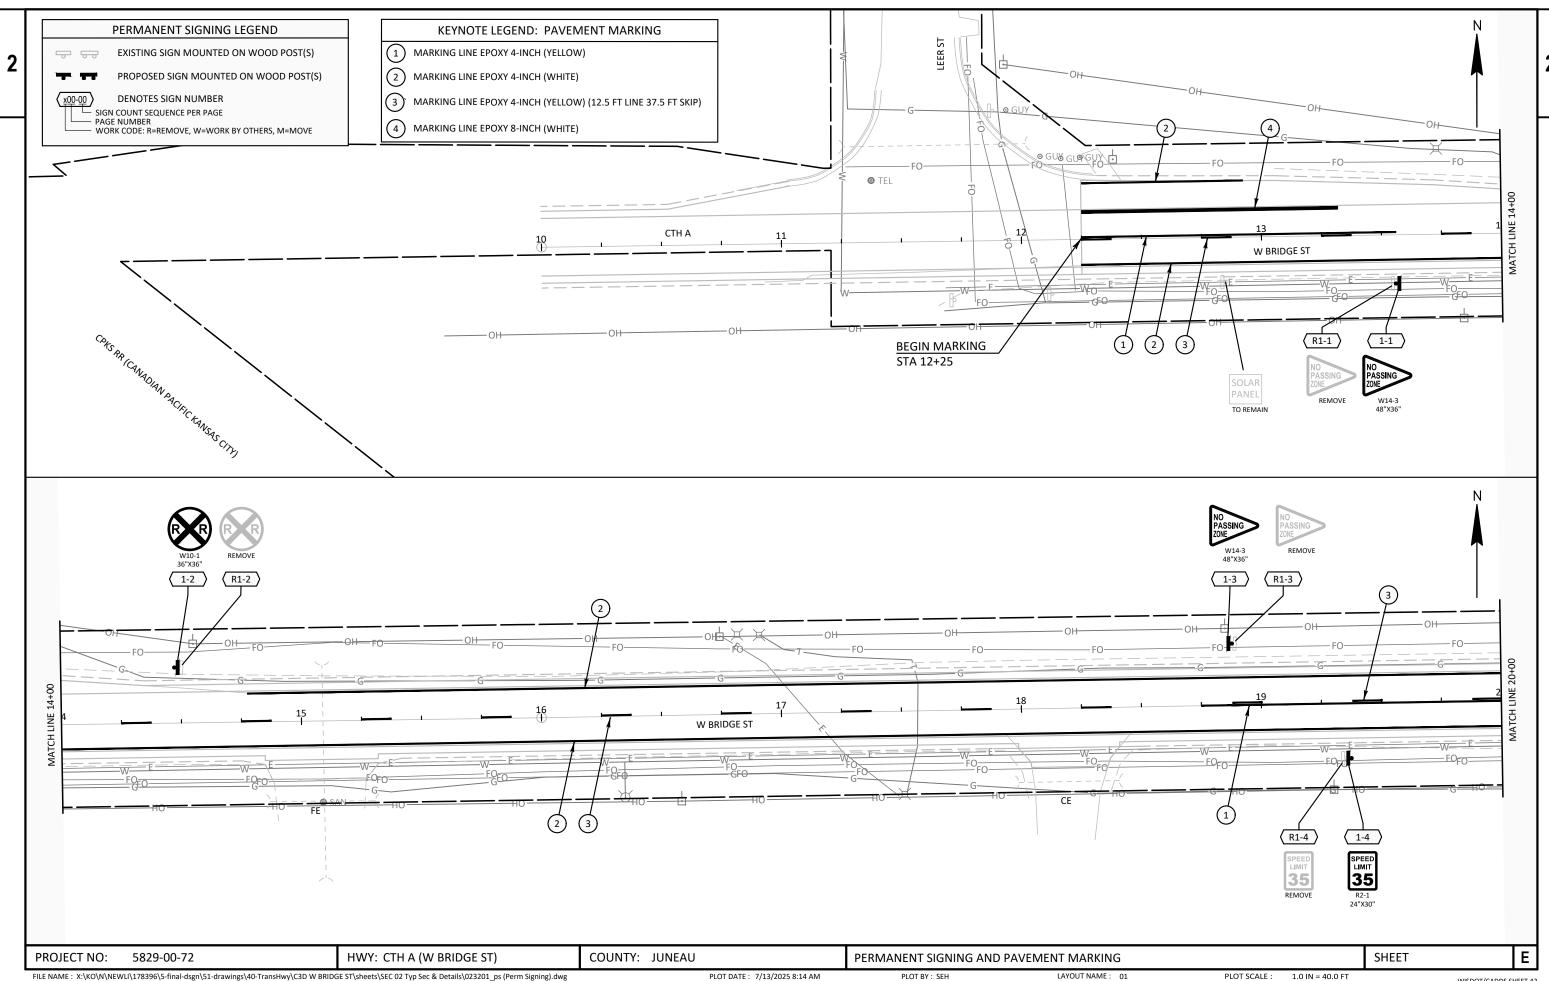

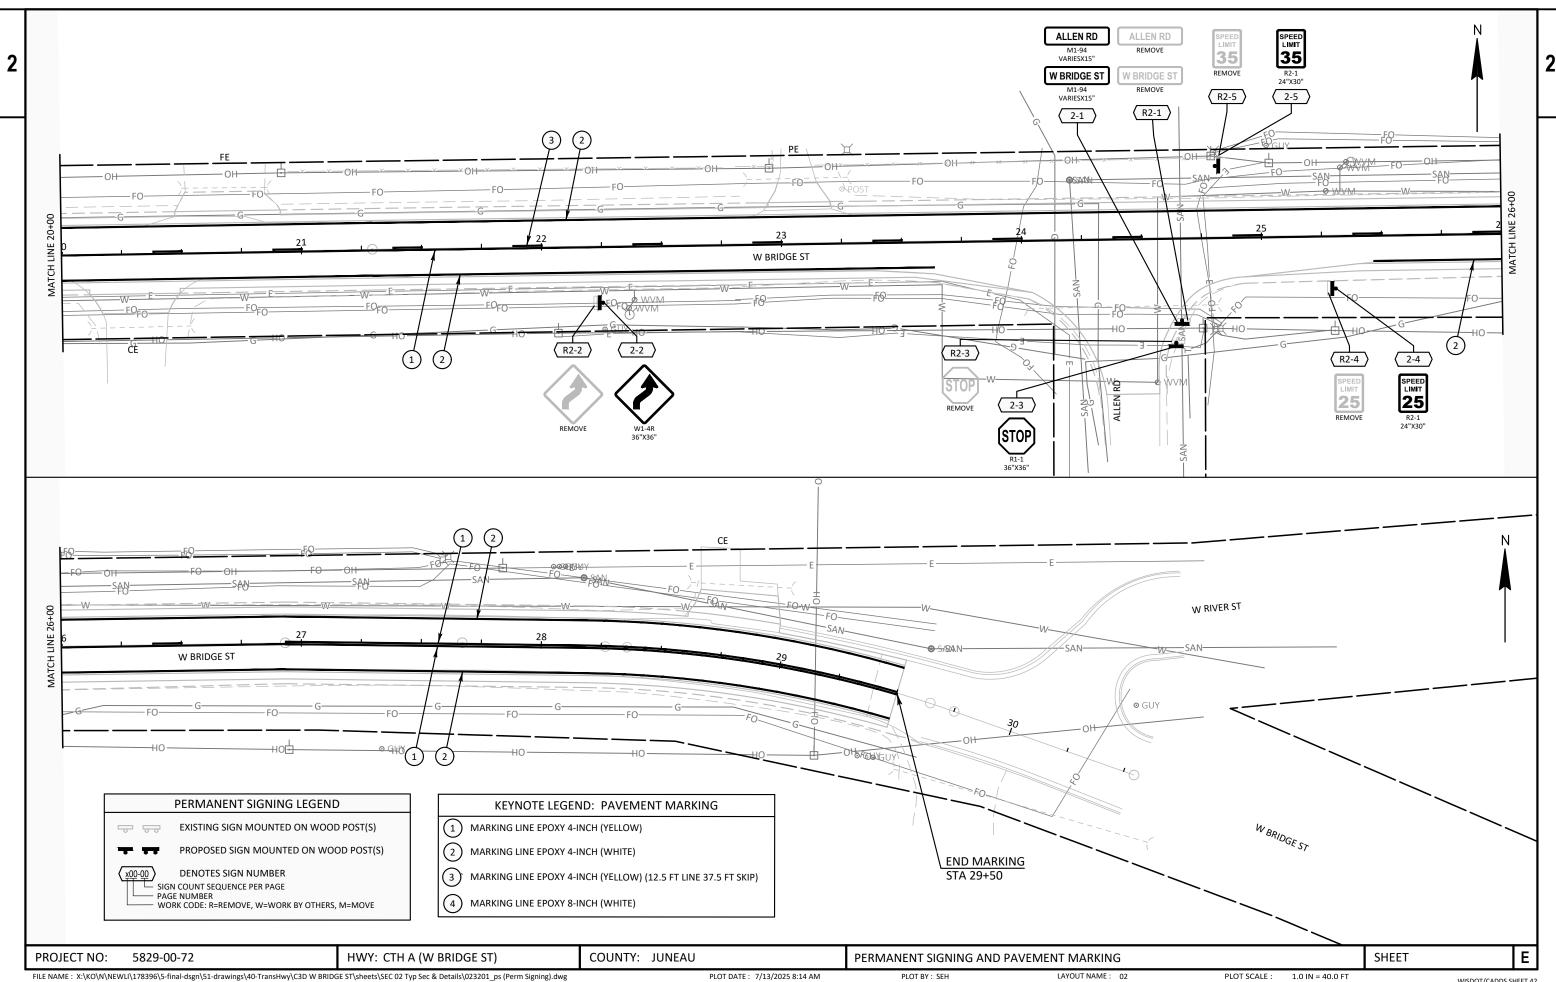

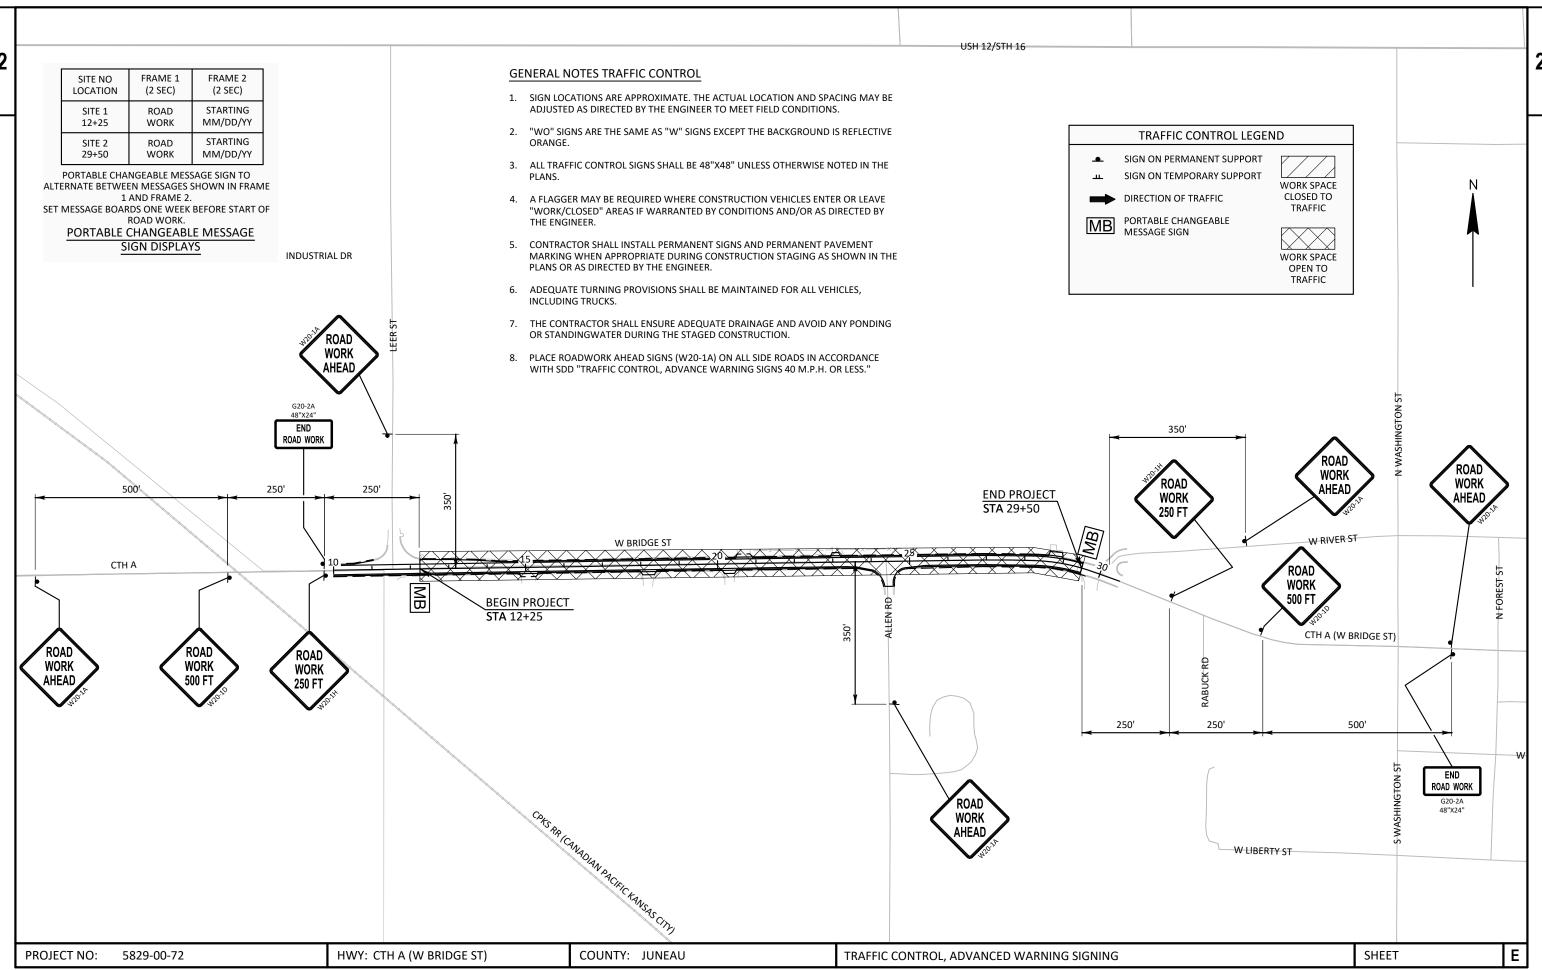

3

5829-00-72
------------

					3029-00-72
Line	Item	Item Description	Unit	Total	Qty
0002	204.0110	Removing Asphaltic Surface	SY	158.000	158.000
0004	204.0115	Removing Asphaltic Surface Butt Joints	SY	261.000	261.000
0006	204.0120	Removing Asphaltic Surface Milling	SY	176.000	176.000
8000	205.0100	Excavation Common	CY	54.000	54.000
0010	213.0100	Finishing Roadway (project) 01. 5829-00-72	EACH	1.000	1.000
0012	305.0110	Base Aggregate Dense 3/4-Inch	TON	270.000	270.000
0014	325.0100	Pulverize and Relay	SY	5,950.000	5,950.000
0016	455.0605	Tack Coat	GAL	436.000	436.000
0018	460.2000	Incentive Density HMA Pavement	DOL	920.000	920.000
0020	460.5223	HMA Pavement 3 LT 58-28 S	TON	833.000	833.000
0022	460.5224	HMA Pavement 4 LT 58-28 S	TON	604.000	604.000
0024	465.0120	Asphaltic Surface Driveways and Field Entrances	TON	30.000	30.000
0026	618.0100	Maintenance and Repair of Haul Roads (project) 01. 5829-00-72	EACH	1.000	1.000
0028	619.1000	Mobilization	EACH	1.000	1.000
0030	624.0100	Water	MGAL	46.000	46.000
0032	634.0616	Posts Wood 4x6-Inch X 16-FT	EACH	9.000	9.000
0034	637.2210	Signs Type II Reflective H	SF	40.840	40.840
0036	637.2230	Signs Type II Reflective F	SF	18.190	18.190
0038	638.2602	Removing Signs Type II	EACH	9.000	9.000
0040	638.3000	Removing Small Sign Supports	EACH	9.000	9.000
0042	642.5001	Field Office Type B	EACH	1.000	1.000
0044	643.0900	Traffic Control Signs	DAY	348.000	348.000
0046	643.1050	Traffic Control Signs PCMS	DAY	14.000	14.000
0048	643.3105	Temporary Marking Line Paint 4-Inch	LF	4,882.000	4,882.000
0050	643.5000	Traffic Control	EACH	1.000	1.000
0052	646.1020	Marking Line Epoxy 4-Inch	LF	4,882.000	4,882.000
0054	646.3020	Marking Line Epoxy 8-Inch	LF	107.000	107.000
0056	650.8000	Construction Staking Resurfacing Reference	LF	1,725.000	1,725.000
0058	650.9911	Construction Staking Supplemental Control (project) 01. 5829-00-72	EACH	1.000	1.000
0060	690.0150	Sawing Asphalt	LF	346.000	346.000
0062	740.0440	Incentive IRI Ride	DOL	1,307.000	1,307.000
0064	SPV.0035	Special 01. Base Repair for Pulverized Asphalt Base Layer	CY	20.000	20.000
0066	SPV.0060	Special 01. Adjust Existing Water Valve Box	EACH	1.000	1.000

_ 4
•

#### REMOVING ASPHALTIC PAVEMENT

#### **EXCAVATION COMMON**

		204.0110 REMOVING ASPHALTIC	204.0115 REMOVING ASPHALTIC SURFACE	204.0120 REMOVING ASPHALTIC SURFACE		CATEGORY	BEGIN STATION	ТО	END STATION	LOCATION	205.0100 CY
		SURFACE	BUTT JOINTS	MILLING		0010	12+25	-	20+47	LT	13
STATION	LOCATION	SY	SY	SY	REMARKS		20+93	-	22+95	LT	4
12+25	RT<	-	108	-	ВОР		23+21	-	28+60	LT	9
18+20	RT	42	-	-	PE ASPHALT		12+25	-	14+85	RT	5
20+32	RT	37	-	-	PE ASPHALT		15+32	-	17+99	RT	5
23+07	LT	25	-	-	PE ASPHALT		18+41	-	20+12	RT	3
24+50	RT	-	73	176	SIDEROAD		20+49	-	24+04	RT	6
28+70	RT	54	-	-	PE ASPHALT		24+93	-	29+50	RT	9
29+50	RT<	-	80	-	EOP						
PROJEC	CT TOTALS	158	261	176					PROJECT TOTALS		54

#### BASE AGGREGATE ITEMS

					305.0110 BASE AGGREGATE DENSE 3/4-INCH	624.0100* WATER	
CATEGORY	STATION	TO	STATION	LOCATION	TON	MGAL	REMARKS
0010	12+25	-	14+85	RT	21	1	SHOULDER
0010	12+25	-	20+47	LT	65	1	SHOULDER
0010	14+85	-	15+32	RT	12	1	AGG DRIVE
0010	15+32	-	17+99	RT	21	1	SHOULDER
0010	18+41	-	20+12	RT	14	1	SHOULDER
0010	20+47	-	20+92	LT	12	1	AGG DRIVE
0010	20+49	-	24+04	RT	28	1	SHOULDER
0010	20+93	-	22+95	LT	17	1	SHOULDER
0010	23+21	-	28+60	LT	42	1	SHOULDER
0010	24+93	-	29+50	RT	38	1	SHOULDER
			PROJEC	CT TOTALS	270	10	

^{*}ADITIONAL QUANTITIES FOUND ELSEWHERE

#### PULVERIZE AND RELAY

				SPV.0035.01		
			325.0100	BASE REPAIR		
			PULVERIZE	FOR PULVERIZED	624.0100*	
			AND RELAY	ASPHALT BASE LAYER	WATER	
CATEGORY	STATION	LOCATION	SY	CY	MGAL	REMARKS
0010	12+25 - 29+50	LT & RT	5950	20	36	_
		PROJECT TOTALS	5950	20	36	

*ADITIONAL QUANTITIES FOUND ELSEWHERE

Ε SHEET PROJECT NO: 5829-00-72 HWY: CTH A (W BRIDGE ST) COUNTY: JUNEAU MISCELLANEOUS QUANTITIES PLOT DATE : 7/13/2025 8:14 AM

#### **PAVEMENT**

465.0120 ASPHALTIC SURFACE 455.0605 460.5223 460.5224 DRIVEWAYS HMA PAVEMENT HMA PAVEMENT TACK AND FIELD COAT 3 LT 58-28 S 4 LT 58-28 S **ENTRANCES** CATEGORY STATION LOCATION GAL TON TON TON REMARKS 0010 12+25 - 29+50 RT/LT 415 833 583 RT PE ASPHALT 18+20 3 9 RT 20+32 PE ASPHALT 8 2 23+07 LT 2 4 PE ASPHALT 24+50 RT 11 21 SIDEROAD LT PE ASPHALT 28+70 9 3 PROJECT TOTALS 436 833 30

NOTE: TACK COAT REQUIRED PRIOR TO PAVING OVER PULVERIZE AND RELAY. CALCULATIONS BASED ON APPLICATION RATE

OF 0.07 GAL/SY. HMA PAVEMENT WEIGHT CALCULATIONS BASED ON UNIT WEIGHT OF 112 LB/SY/INCH.

#### PERMANENT SIGNING

							634.0616	637.2210	637.2230	638.2602	638.3000	
				SIZ	ZE		POSTS WOOD 4X6-INCH X 16-FT	SIGNS TYPE I REFLECTIVE H	SIGNS TYPE II REFLECTIVE F	REMOVING SIGNS TYPE II	REMOVING SMALL SIGN SUPPORTS	
PROJECT NUMBER	CATEGORY	SIGN NUMBER	SIGN CODE	(INCH)	(INCH)	MESSAGE	EACH	SF	SF	EACH	EACH	REMARKS
5829-00-72	0010	1-1	W14-3	48	36	NO PASSING ZONE	1	-	5.56	1	1	-
		1-2	W10-1	36	36	RAILROAD CROSING	1	-	7.07	1	1	-
		1-3	W14-3	48	36	NO PASSING ZONE	1	-	5.56	1	1	-
		1-4	R2-1	24	30	SPEED LIMIT 35	1	5	-	1	1	-
		2-1	M1-94	15	45	ALLEN RD	1	4.69	-	1	1	-
		2-1	M1-94	15	45	W BRIDGE ST	-	4.69	-	-		-
		2-2	W1-4	36	36	ROAD CURVES AHEAD	1	9	-	1	1	-
		2-3	R1-1	36	36	STOP	1	7.46	-	1	1	-
		2-4	R2-1	24	30	SPEED LIMIT 35	1	5	-	1	1	-
		2-5	R2-1	24	30	SPEED LIMIT 25	1	5	-	1	1	-
						PROJECT TOTAL	9	40.84	18.19	9	9	

PROJECT NO: 5829-00-72	HWY: CTH A (W BRIDGE ST)	COUNTY: JUNEAU		MISCELLANEOUS QUANTITIES			SHEET	E
FILE NAME: X:\KO\N\NEWLI\178396\5-FINAL-DSGN\51-DRAWINGS\40-TRANSHWY\C	BD W BRIDGE ST\SHEETS\SEC 03 MISC QTYS\030201-MQ (MISC QTYS).DWG	PLOT D	ATE: 7/13/2025 8:14 AM	PLOT BY: DEAN STODOLA	PLOT NAME :	PLOT SCALE : 1" = 1'	•	

X:\KO\n\newli\178396\5-final-dsgn\51-drawings\40-transhwy\c3d w bridge st\sheets\sec 03 misc qtys\030201-mq (misc qtys).dwg layout name - 02 FILE NAME :

PLOT DATE: 7/13/2025 8:14 AM

PLOT BY: DEAN STODOLA

PLOT SCALE : 1" = 1'

TRAFFIC CONTROL ITEMS

643.0900

643.1050

		APPROX. SERVICE	TRAFFIC	CONTROL SIGNS	TRAFFIC CO	ONTROL SIGNS PCMS	
CATEGORY	PROJECT LOCATION	PERIOD DAYS	QTY.	DAY	QTY.	DAY	REMARKS
0010	PRE-WARNING	7	0	0	2	14	PRE-WARN PRIOR TO CONSTRUCTION START
	ENTIRE PROJECT	29	12	348	0	0	-
		PROJECT TOTAL	PROJECT TOTAL			14	

#### PAVEMENT MARKING

					646.1020	MARKING LINE EPOXY 4-INCH		MARKING LINE EPOXY 8-INCH	TE	543.3105 MPORARY LINE PAINT 4-IN	JCH	648.0100 LOCATING NO-PASSING
					(WHITE, SOLID)	(YELLOW, SOLID)	(YELLOW, 12.5-FT SKIPS)	(WHITE, SOLID)	(WHITE, SOLID)	(YELLOW, SOLID)	(YELLOW, 12.5-FT SKIPS)	ZONES
CATEGORY	STATION	TO	STATION	LOCATION	LF	LF	LF	LF	LF	LF	LF	MI
0010	12+25 12+25	- -	29+50 29+50	PROJECT LT&RT	- 3082	- 1450	- 350	- 107	- 3082	- 1450	- 350	0.33
		PROJE	CT TOTAL			4882		107		4	882	0.33

PROJECT VO: 5829-00-72 HWY: CTH A (W BRIDGE ST) COUNTY: JUNEAU SILEANEOUS QUANTITIES

FILE NAME: SUNGNIVE WILLI/178396\S-FINAL-DSGN\S1-DRAWINGS\40-TRANSHWYCST-BRAWINGS\40-TRANSHWYCST-BRAWINGS\40-TRANSHWYCST-BRAWINGS\40-TRANSHWYCST-BRAWINGS\40-TRANSHWYCST-BRAWINGS\40-TRANSHWYCST-BRAWINGS\40-TRANSHWYCST-BRAWINGS\40-TRANSHWYCST-BRAWINGS\40-TRANSHWYCST-BRAWINGS\40-TRANSHWYCST-BRAWINGS\40-TRANSHWYCST-BRAWINGS\40-TRANSHWYCST-BRAWINGS\40-TRANSHWYCST-BRAWINGS\40-TRANSHWYCST-BRAWINGS\40-TRANSHWYCST-BRAWINGS\40-TRANSHWYCST-BRAWINGS\40-TRANSHWYCST-BRAWINGS\40-TRANSHWYCST-BRAWINGS\40-TRANSHWYCST-BRAWINGS\40-TRANSHWYCST-BRAWINGS\40-TRANSHWYCST-BRAWINGS\40-TRANSHWYCST-BRAWINGS\40-TRANSHWYCST-BRAWINGS\40-TRANSHWYCST-BRAWINGS\40-TRANSHWYCST-BRAWINGS\40-TRANSHWYCST-BRAWINGS\40-TRANSHWYCST-BRAWINGS\40-TRANSHWYCST-BRAWINGS\40-TRANSHWYCST-BRAWINGS\40-TRANSHWYCST-BRAWINGS\40-TRANSHWYCST-BRAWINGS\40-TRANSHWYCST-BRAWINGS\40-TRANSHWYCST-BRAWINGS\40-TRANSHWYCST-BRAWINGS\40-TRANSHWYCST-BRAWINGS\40-TRANSHWYCST-BRAWINGS\40-TRANSHWYCST-BRAWINGS\40-TRANSHWYCST-BRAWINGS\40-TRANSHWYCST-BRAWINGS\40-TRANSHWYCST-BRAWINGS\40-TRANSHWYCST-BRAWINGS\40-TRANSHWYCST-BRAWINGS\40-TRANSHWYCST-BRAWINGS\40-TRANSHWYCST-BRAWINGS\40-TRANSHWYCST-BRAWINGS\40-TRANSHWYCST-BRAWINGS\40-TRANSHWYCST-BRAWINGS\40-TRANSHWYCST-BRAWINGS\40-TRANSHWYCST-BRAWINGS\40-TRANSHWYCST-BRAWINGS\40-TRANSHWYCST-BRAWINGS\40-TRANSHWYCST-BRAWINGS\40-TRANSHWYCST-BRAWINGS\40-TRANSHWYCST-BRAWINGS\40-TRANSHWYCST-BRAWINGS\40-TRANSHWYCST-BRAWINGS\40-TRANSHWYCST-BRAWINGS\40-TRANSHWYCST-BRAWINGS\40-TRANSHWYCST-BRAWINGS\40-TRANSHWYCST-BRAWINGS\40-TRANSHWYCST-BRAWINGS\40-TRANSHWYCST-BRAWINGS\40-TRANSHWYCST-BRAWINGS\40-TRANSHWYCST-BRAWINGS\40-TRANSHWYCST-BRAWINGS\40-TRANSHWYCST-BRAWINGS\40-TRANSHWYCST-BRAWINGS\40-TRANSHWYCST-BRAWINGS\40-TRANSHWYCST-BRAWINGS\40-TRANSHWYCST-BRAWINGS\40-TRANSHWYCST-BRAWINGS\40-TRANSHWYCST-BRAWINGS\40-TRANSHWYCST-BRAWINGS\40-TRANSHWYCST-BRAWINGS\40-TRANSHWYCST-BRAWINGS\40-TRANSHWYCST-BRAWINGS\40-TRANSHWYCST-BRAWINGS\40-TRANSHWYCST-BRAWINGS\40-TRANSHWYCST-BRAWINGS\40-TRA

WISDOT/CADDS SHEET 42

Ε

#### CONSTRUCTION STAKING

650.9911 650.8000 SUPPLEMENTAL RESURFACING CONTROL REFERENCE (5829-00-72) CATEGORY STATION LF EACH 0010 12+25 - 29+50 1725 1 PROJECT TOTAL 1725 1


#### ADJUSTING UTILITIES


SPV.0060.01 ADJUST EXISTING WATER VALVE BOX CATEGORY STATION LOCATION EACH 0020 24+56 60.4' RT 1 PROJECT TOTAL 1

#### SAWING

				690.0150 SAWING ASPHALT	
_	CATEGORY	STATION	LOCATION	LF	REMARKS
	0010	12+25	RT<	39	START OF PROJECT
	0010	18+20	RT	64	PRIVATE ENTRANCE
	0010	20+32	RT	57	PRIVATE ENTRANCE
	0010	23+07	LT	35	PRIVATE ENTRANCE
	0010	24+50	RT	57	SIDEROAD
	0010	28+70	RT	65	PRIVATE ENTRANCE
	0010	29+50	RT<	29	END OF PROJECT
_		PROJE	CT TOTAL	346	

SHEET Ε PROJECT NO: 5829-00-72 HWY: CTH A (W BRIDGE ST) COUNTY: JUNEAU MISCELLANEOUS QUANTITIES 7/13/2025 8:14 AM

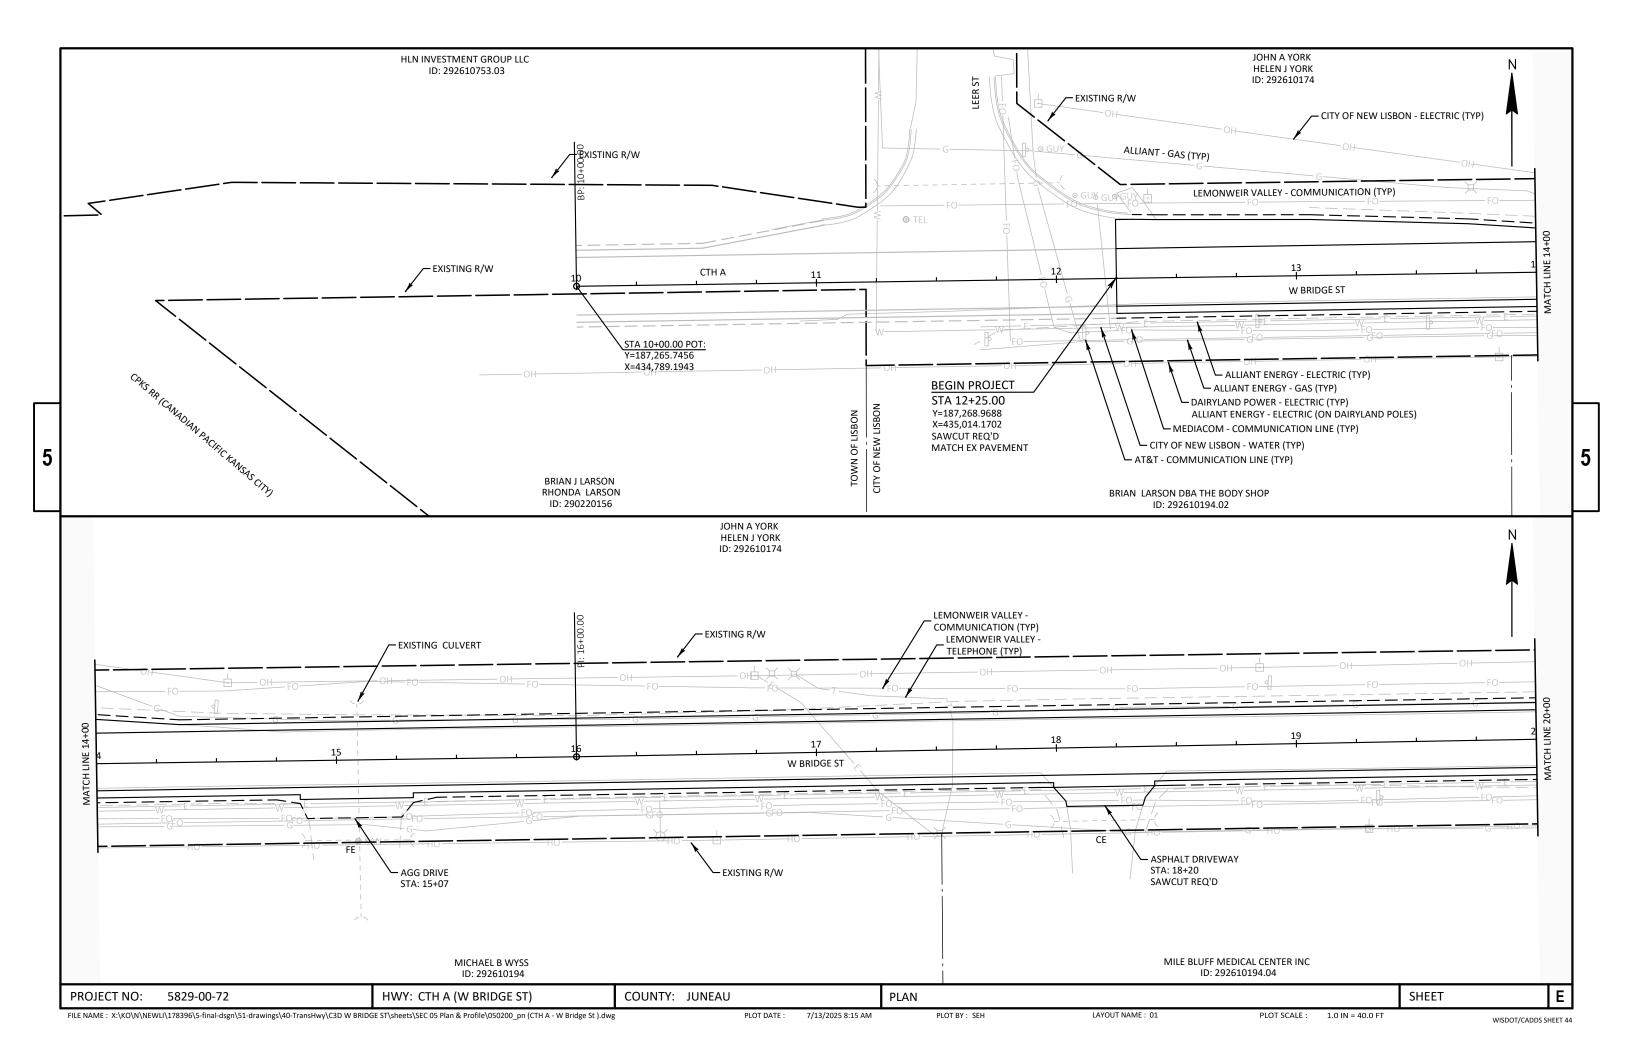


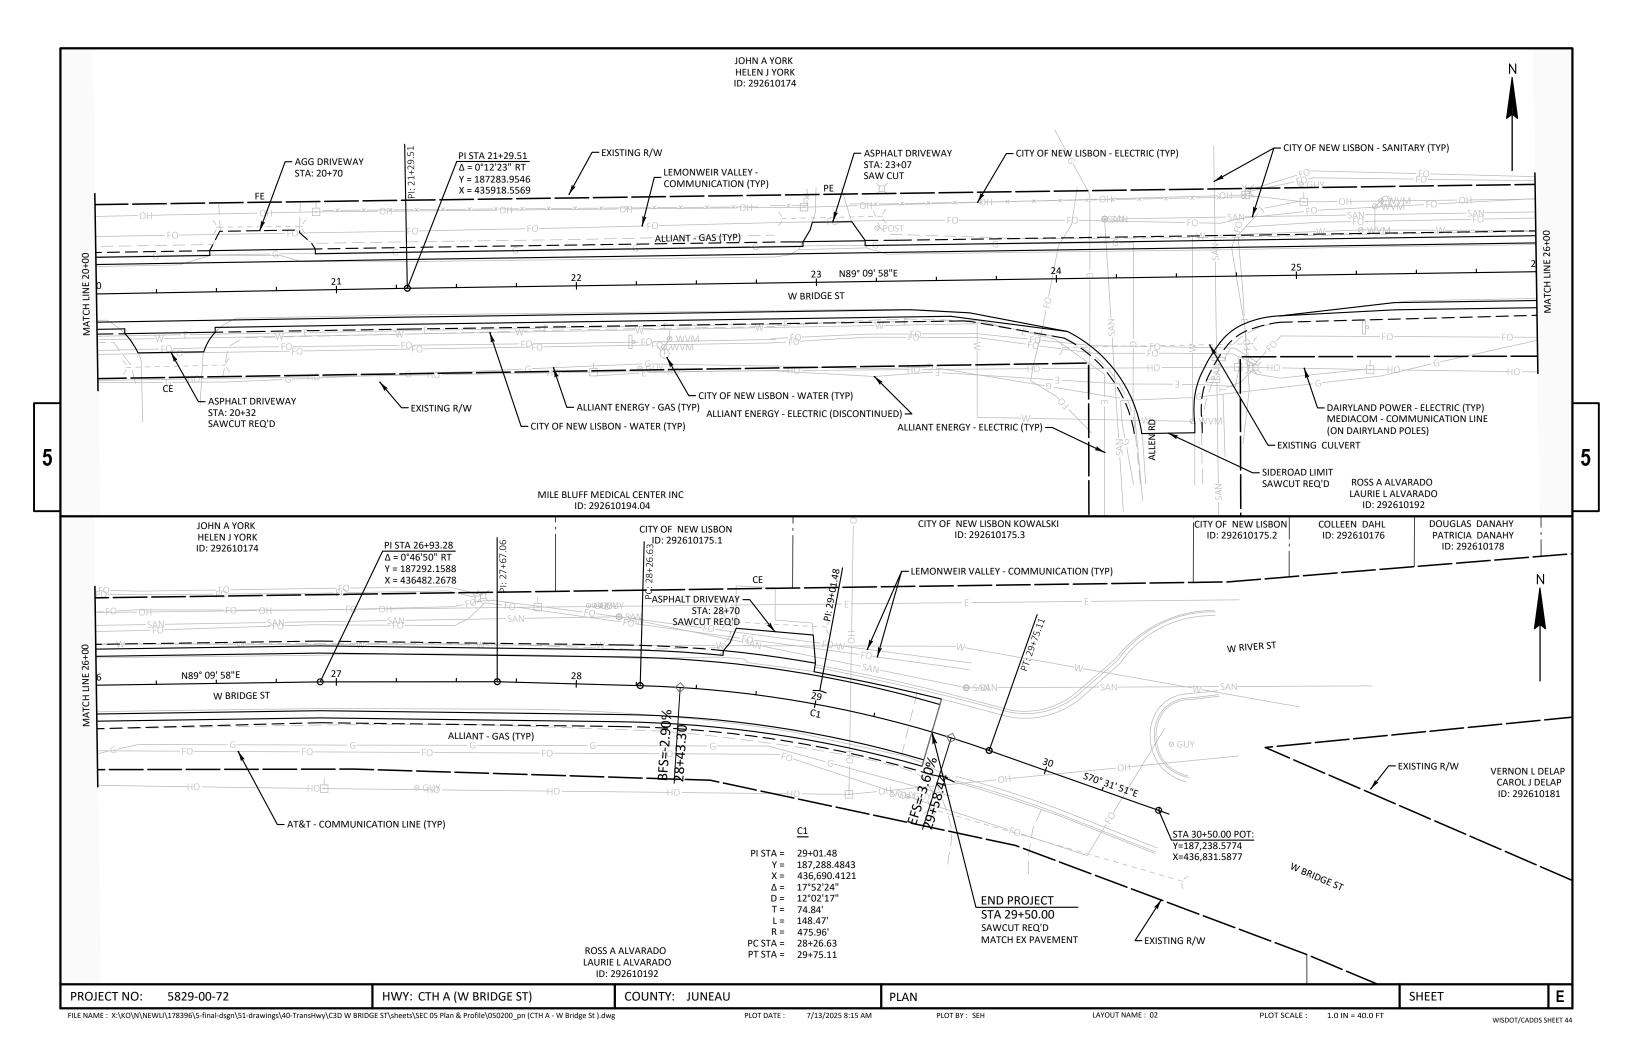


## Standard Detail Drawing List

08D22-01	DRIVEWAYS WITHOUT CURB & GUTTER RESURFACING PROJECTS RURAL
13C19-03	HMA LONGITUDINAL JOINTS
14B29-01	SAFETY EDGE
15C05-05	TRAFFIC CONTROL, ADVANCE WARNING SIGNS 40 M.P.H. OR LESS
15C08-23A	PERMANENT LONGITUDINAL PAVEMENT MARKINGS
15C08-23B	TEMPORARY LONGITUDINAL PAVEMENT MARKING
15C12-09A	TRAFFIC CONTROL FOR LANE CLOSURE WITH FLAGGING OPERATION
15C19-09A	MOVING PAVEMENT MARKING OPERATION TWO-LANE TWO-WAY ROADWAY
15C35-06A	PAVEMENT MARKING (INTERSECTIONS)
15D28-04	TRAFFIC CONTROL, WORK ON SHOULDER OR PARKING LANE, UNDIVIDED ROADWAY
15D39-02	TRAFFIC CONTROL, DROP-OFF SIGNING
15D45-03	TRAFFIC CONTROL, SIGNING ON ROADWAYS WITH LOOSE GRAVEL

6

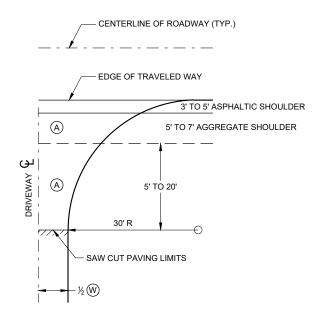


- (A) : PAID FOR AS ASPHALTIC SURFACE DRIVEWAYS AND FIELD ENTRANCES. (TON)
- ig(Big) : PAID FOR AS BASE AGGREGATE DENSE 1  $1\!\!\!/ _4$ " (TON)
- W): DRIVEWAY WIDTH 16' MIN. 24' MAX.

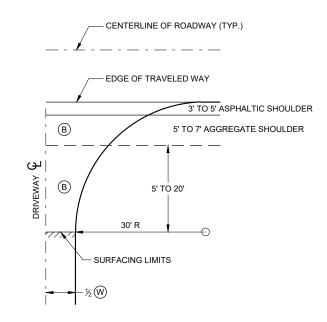


PLAN VIEW
HALF SECTION

## PLAN VIEW HALF SECTION

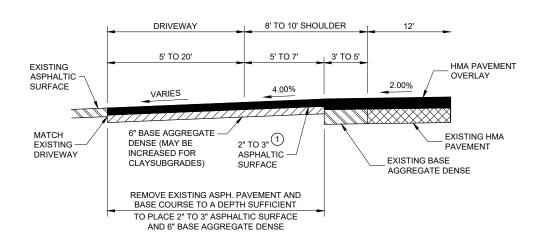

PROFILE VIEW
RURAL ENTRANCE
WITH ASPHALTIC SURFACE
RESURFACING PROJECTS

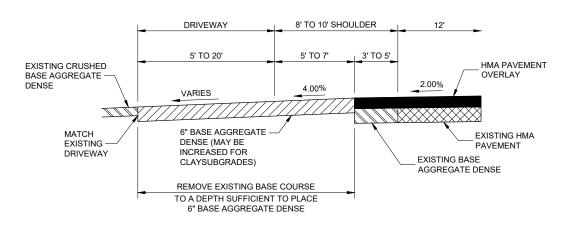

PROFILE VIEW
RURAL ENTRANCE
WITH AGGREGATE SURFACE
6" BASE AGGREGATE DENSE
RESURFACING PROJECTS

#### DRIVEWAYS WITHOUT CURB AND GUTTER RESURFACING PROJECTS RURAL

STATE OF WISCONSIN
DEPARTMENT OF TRANSPORTATION

 APPROVED
 /S/ Rodney Taylor

 December 2016
 /S/ Rodney Taylor

 DATE
 ROADWAY STANDARDS DEVELOPMENT


 ENGINEER
 ENGINEER


SDD 08D22 - 01


6

08D22 -


SD

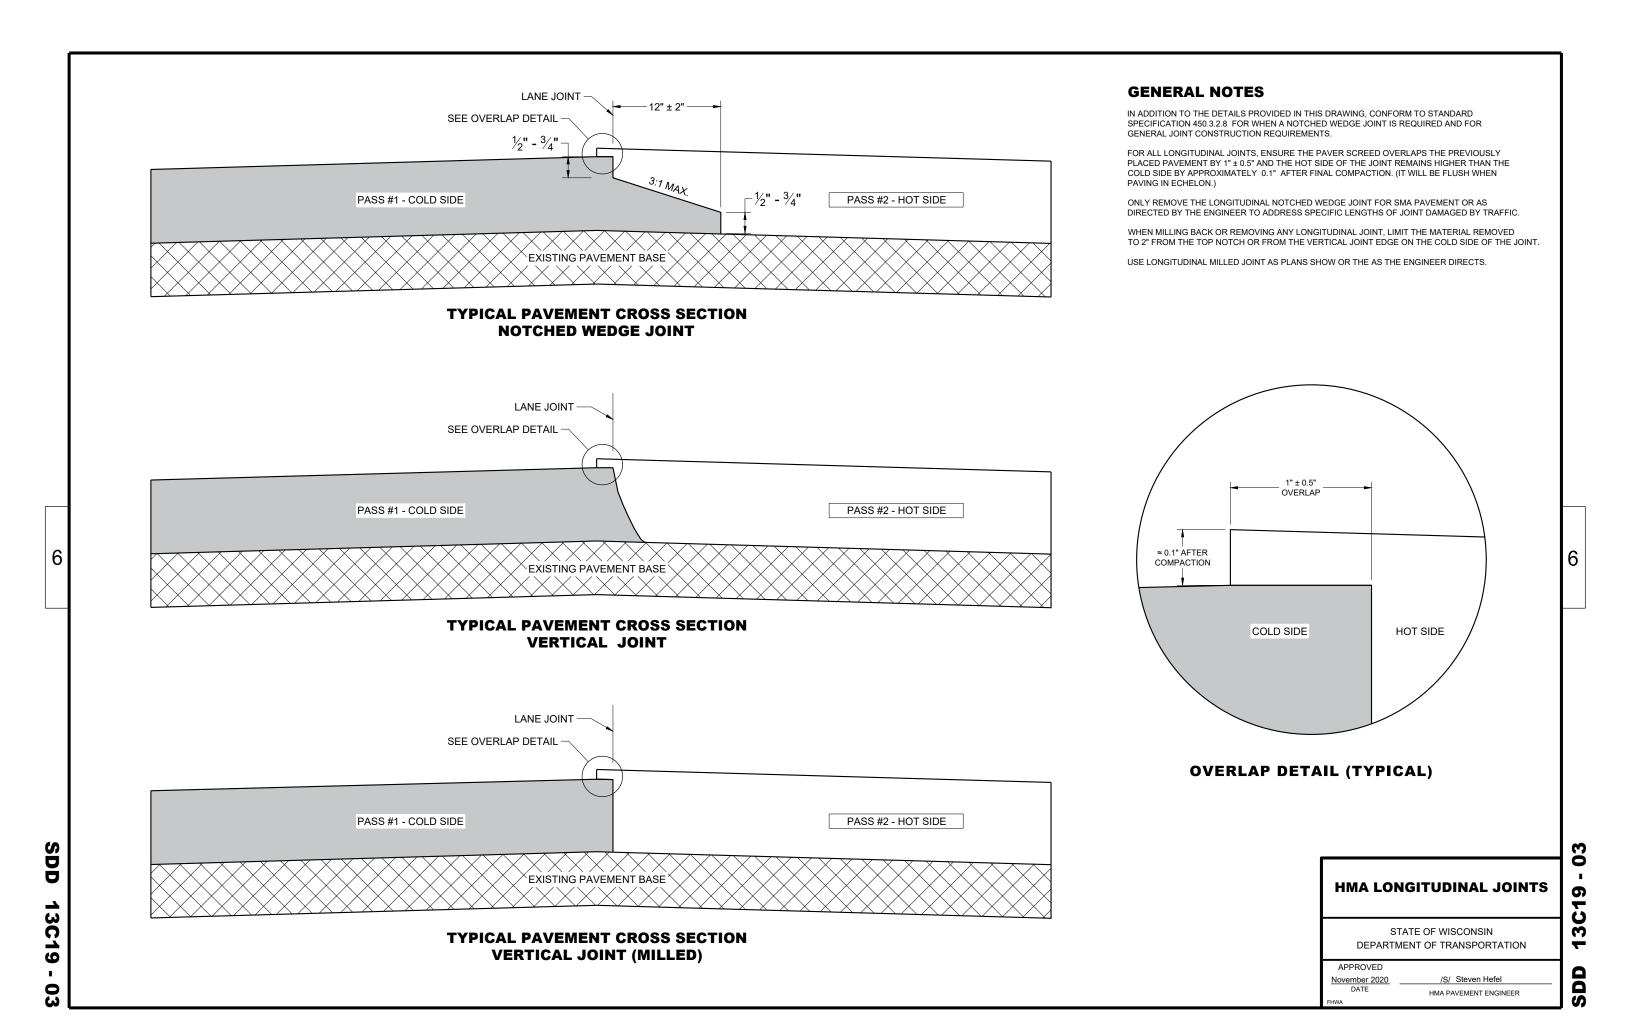


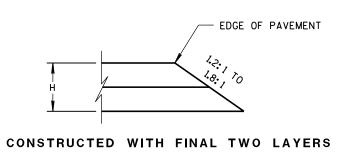

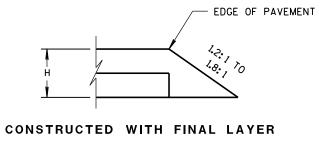


FOR H 5" OR LESS

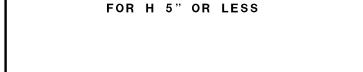

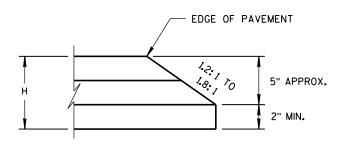


CONSTRUCTED WITH FINAL TWO LAYERS

FOR H GREATER THAN 5"

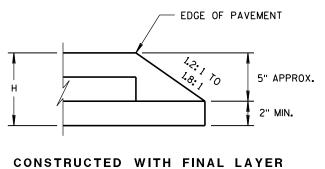

FOR H GREATER THAN 5"

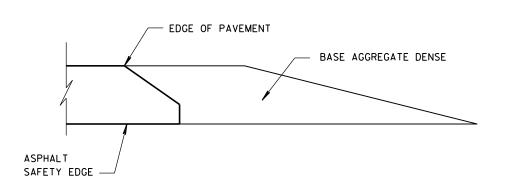

FINISHED SHOULDER AGGREGATE PLACEMENT

HMA PAVEMENT AND HMA OVERLAYS

SAFETY EDGE SM

STATE OF WISCONSIN
DEPARTMENT OF TRANSPORTATION

6

 $\mathbf{\omega}$ 


Ω


Ω

APPROVED

DATE ROADWAY STANDARDS DEVELOPMENT ENGINEER

6

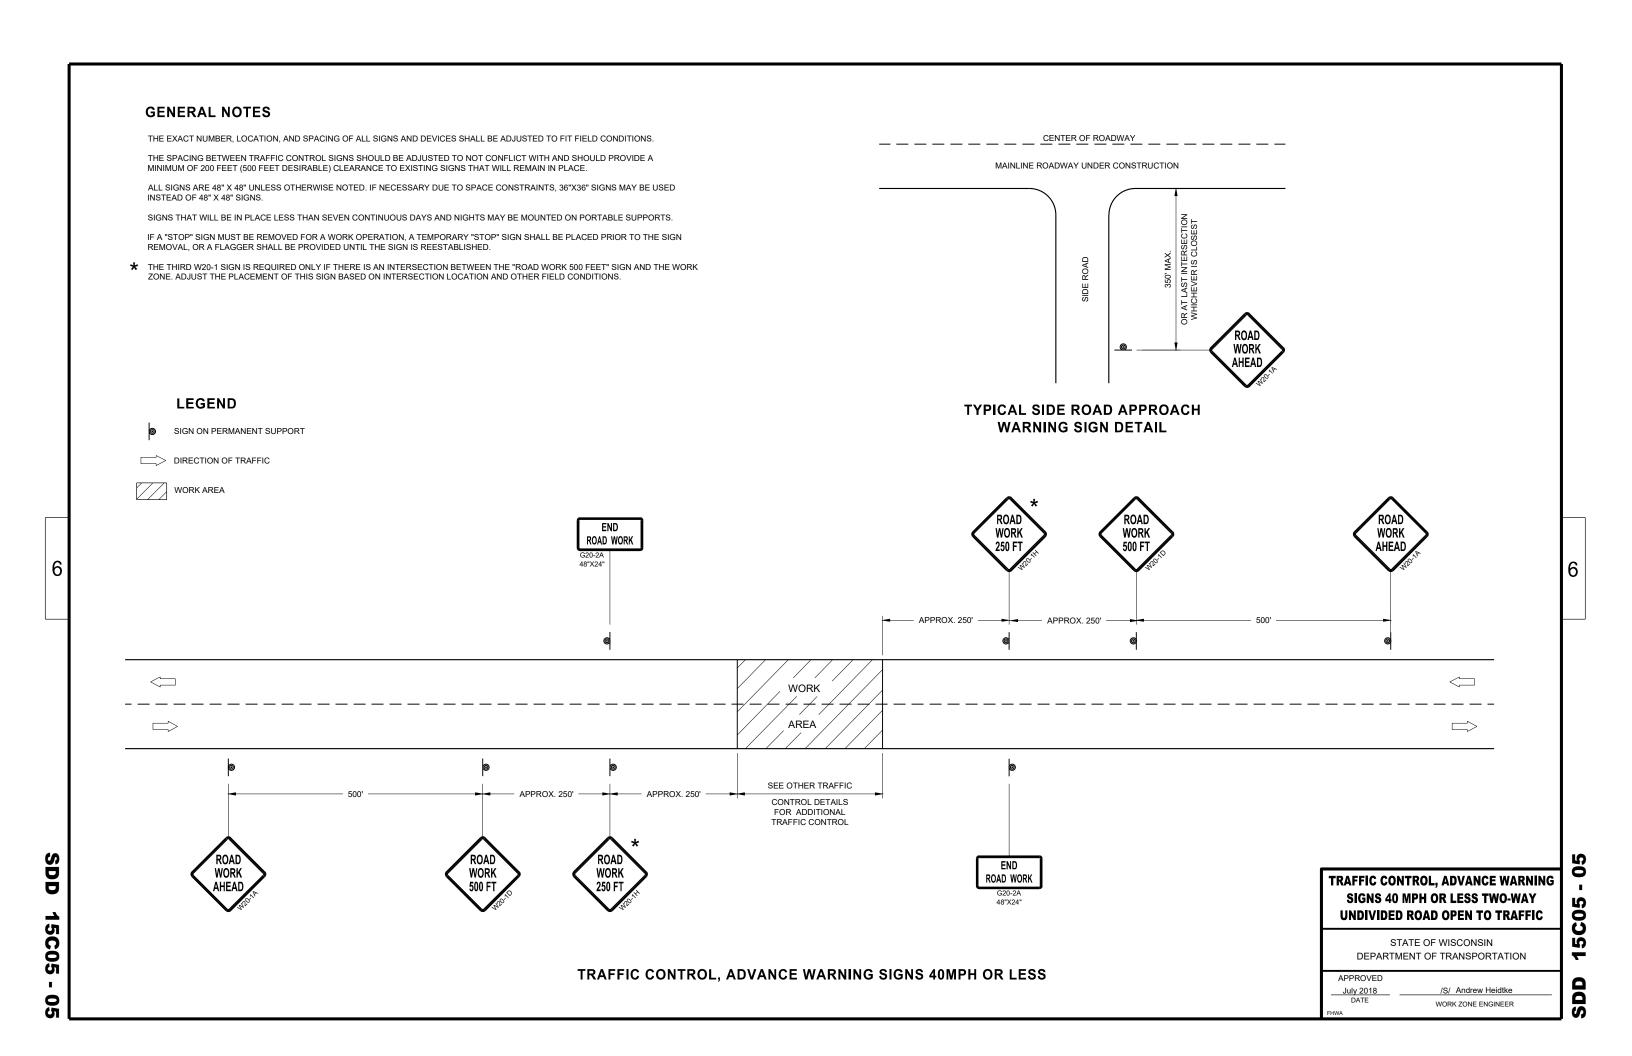

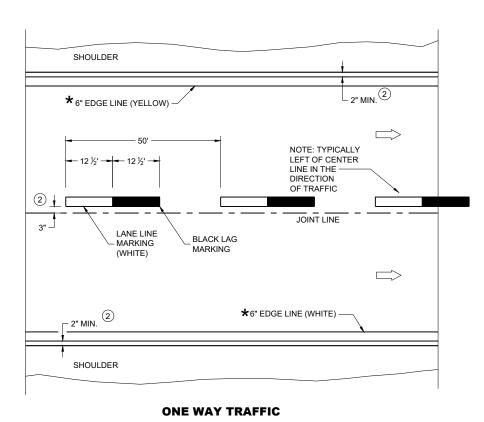

**PERMANENT PAVEMENT MARKING** 

#### **GENERAL NOTES**

DETAILS OF CONSTRUCTION NOT SHOWN ON THIS DRAWING SHALL CONFORM TO STANDARD SPECIFICATIONS AND SPECIAL PROVISIONS.

- 1) LOCATE THE NO PASSING ZONE W14-3 SIGN WITHIN 50 FEET OF THE "T" MARKING
- (2) MEASURE FROM EDGE OF MARKING TO JOINT LINE. THIS DOES NOT INCLUDE SPACE NEEDED FOR GROOVING OPERATIONS.

#### **LEGEND**

"T" MARKING

SIGN ON PERMANENT SUPPORT

DIRECTION OF TRAFFIC

PERMANENT LONGITUDINAL **PAVEMENT MARKINGS** 

STATE OF WISCONSIN DEPARTMENT OF TRANSPORTATION

May 2023 DATE


/S/ Jeannie Silver Statewide Pavement Marking Engineer

6

SDD

C08-23 Ŋ SD

15C08-23a

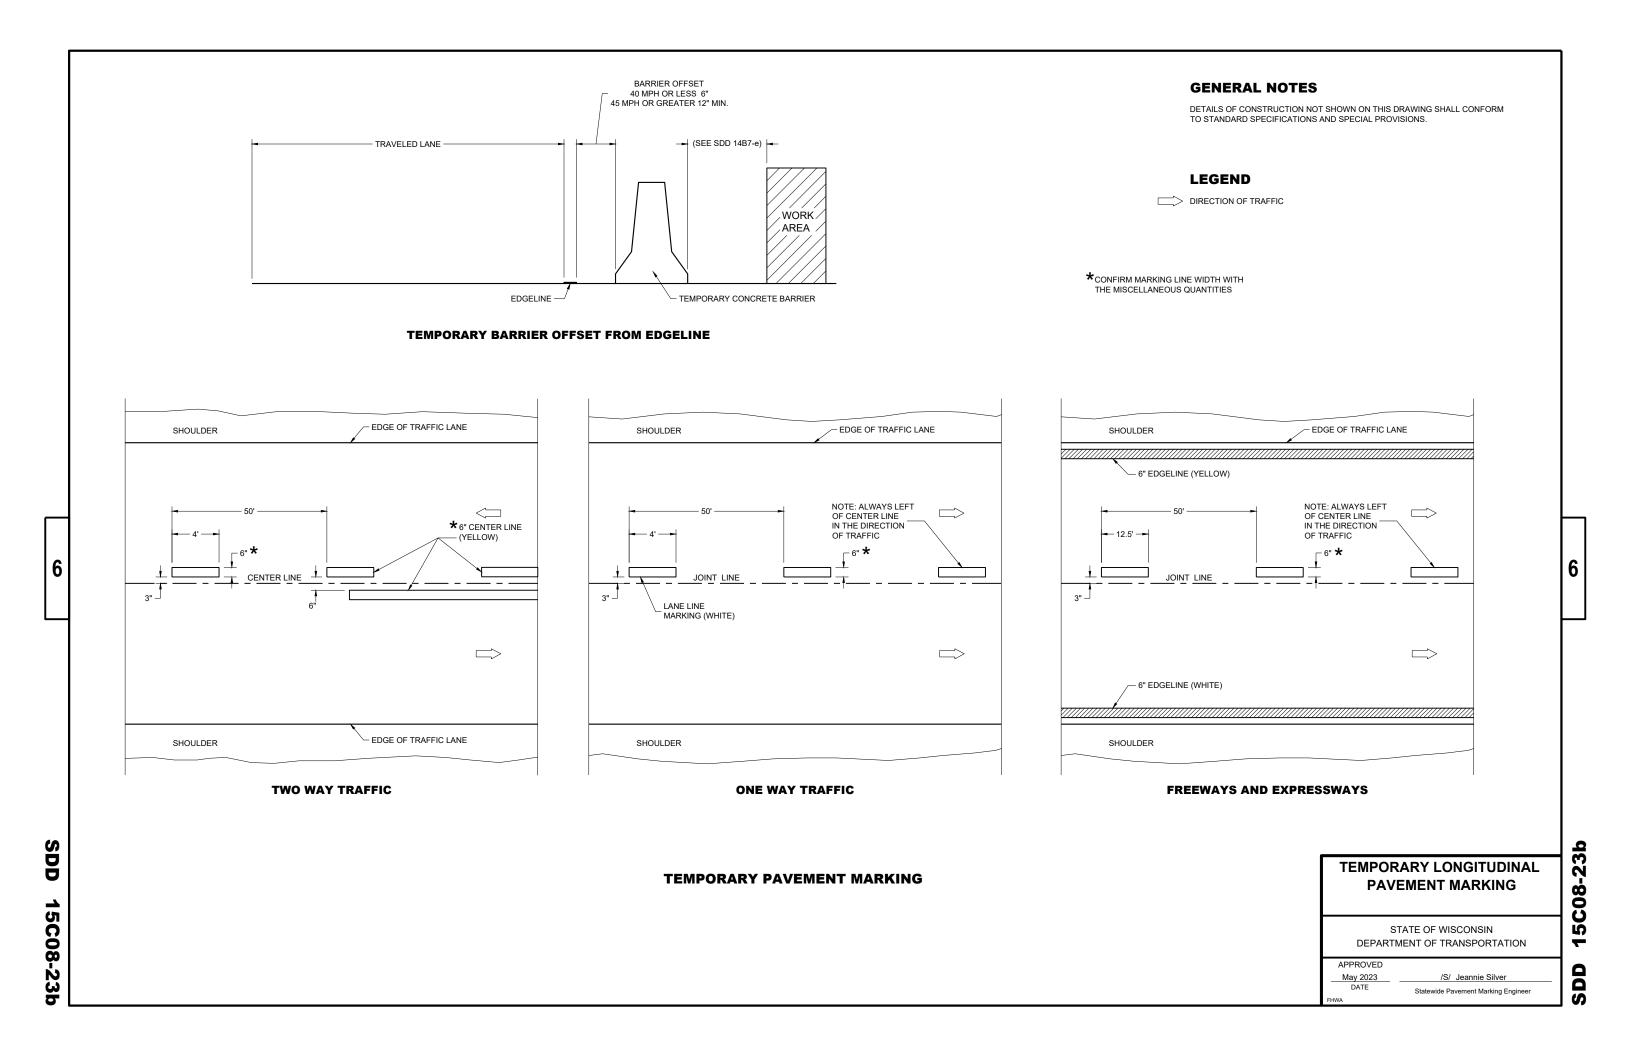

RUMBLE

STRIPS

ROAD

WORK

#### **GENERAL NOTES FLAGGING LEGEND** DETAILS OF TRAFFIC CONTROL DEVICES AND INSTALLATION NOT SHOWN ON THIS DRAWING SHALL CONFORM TO THE PERTINENT REQUIREMENTS OF THE STANDARD SPECIFICATIONS, THE SPECIAL PROVISIONS, AND THE MANUAL ON FLAGGERS SHALL BE IN SIGHT OF EACH OTHER OR IN DIRECT COMMUNICATION AT ALL TIMES. THEY SHALL BE EQUIPPED WITH STOP/SLOW PADDLES FASTENED ON SUPPORT STAFFS. WHEN THE FLAGGING OPERATION IS NOT IN EFFECT REMOVE TEMPORARY SIGN ON PORTABLE OR PERMANENT SUPPORT UNIFORM TRAFFIC CONTROL DEVICES. PORTABLE RUMBLE STRIPS PRIOR TO COVERING OR REMOVING ALL ADVANCE SIGNING. ① FOR MOVING WORK OPERATIONS, POST ADDITIONAL W20-7A FLAGGER SIGNS AT APPROXIMATELY 3,500' INTERVALS IN THE MOVING ALL SIGNS ARE 48" X 48" UNLESS OTHERWISE NOTED. TEMPORARY PORTABLE RUMBLE WORK OPERATION OR AS APPROVED BY THE ENGINEER. STRIP ARRAY "WO" SIGNS ARE THE SAME AS "W" SIGNS EXCEPT THE BACKGROUND IS ORANGE. (2) SIGN NOT REQUIRED IF FLAGGING OPERATION OCCURS WITHIN A SIGNED ROAD WORK ZONE AREA. THE EXACT NUMBER, LOCATION AND SPACING OF ALL SIGNS, DEVICES, AND LOCATION OF ALL FLAGGERS SHALL BE DIRECTION OF TRAFFIC ADJUSTED TO FIT FIELD CONDITIONS AS APPROVED BY THE ENGINEER. WHEN THE DISTANCE BETWEEN FLAGGERS EXCEEDS 2 MILES, A PILOT CAR IS REQUIRED. WHEN CURVES REDUCE SIGHT DISTANCE BELOW 400', A PILOT CAR IS REQUIRED. THE FIRST ADVANCE WARNING SIGN SHOULD TYPICALLY BE LOCATED IN ADVANCE OF THE ANTICIPATED TRAFFIC BACKUP WORK AREA **TEMPORARY PORTABLE RUMBLE STRIPS** WHEN A SIDE ROAD OR RAMP INTERSECTS THE FACILITY ON WHICH THE WORK IS BEING PERFORMED, ADDITIONAL UTILIZE TEMPORARY PORTABLE RUMBLE STRIPS ON ALL FLAGGING OPERATIONS. TRAFFIC CONTROLS SHALL BE PROVIDED AS SPECIFIED IN THE PLANS AND/OR THE SPECIAL PROVISIONS OR AS APPROVED FLAGGER, EQUIPPED WITH STOP/SLOW ③ EACH TEMPORARY PORTABLE RUMBLE STRIP ARRAY CONSISTS OF THREE RUMBLE STRIPS PLACED TRANSVERSE ACROSS THE LANE AT PADDLE FASTENED ON SUPPORT STAFF THE LOCATIONS SHOWN. WITHIN EACH ARRAY, SPACING BETWEEN RUMBLE STRIPS SHALL BE 15 FEET ON CENTER ONLY USE TEMPORARY PORTABLE RUMBLE STRIPS FROM THE APPROVED PRODUCTS LIST. INSTALL TEMPORARY RUMBLE STRIPS PER MANUFACTURER'S RECOMMENDATIONS. PLACE ADVANCE SIGNING PRIOR TO INSTALLING TEMPORARY RUMBLE STRIPS. DO NOT INSTALL TEMPORARY PORTABLE RUMBLE STRIPS ON GRAVEL, MILLED SURFACES, OR ASPHALT THAT HAS BEEN PAVED LESS THAN 12 HOURS. **SIGN AND TEMPORARY RUMBLE** STRIP ARRAY SPACING TABLE 5' MIN BE SPACING "A" SPEED LIMIT USE OF WO3-4 SIGN IS OPTIONAL. WHEN USED, PREPARED THIS SIGN SHALL BE LOCATED BETWEEN THE 25-30 MPH TO STOP W20-7A AND W20-4A SIGNS, USING SPACING "A". 35-40 MPH 350' STOP/SLOW PADDLE ŔUMBLĖ 45-55 MPH 500' WO3-4 WORK **ON SUPPORT STAFF** ROAD STRIPS 1 VARIABLE DISTANCE - 200' - 300' (TYP.) END ROAD WORK |||3 WORK AREA A/2 END ROAD WORK 200' - 300' (TYP.) VARIABLE DISTANCE

#### TRAFFIC CONTROL FOR LANE CLOSURE WITH **FLAGGING OPERATION**


0


2


Ŋ

STATE OF WISCONSIN DEPARTMENT OF TRANSPORTATION

APPROVED	
May 2022	/S/ Andrew Heidtke
DATE	WORK ZONE ENGINEER

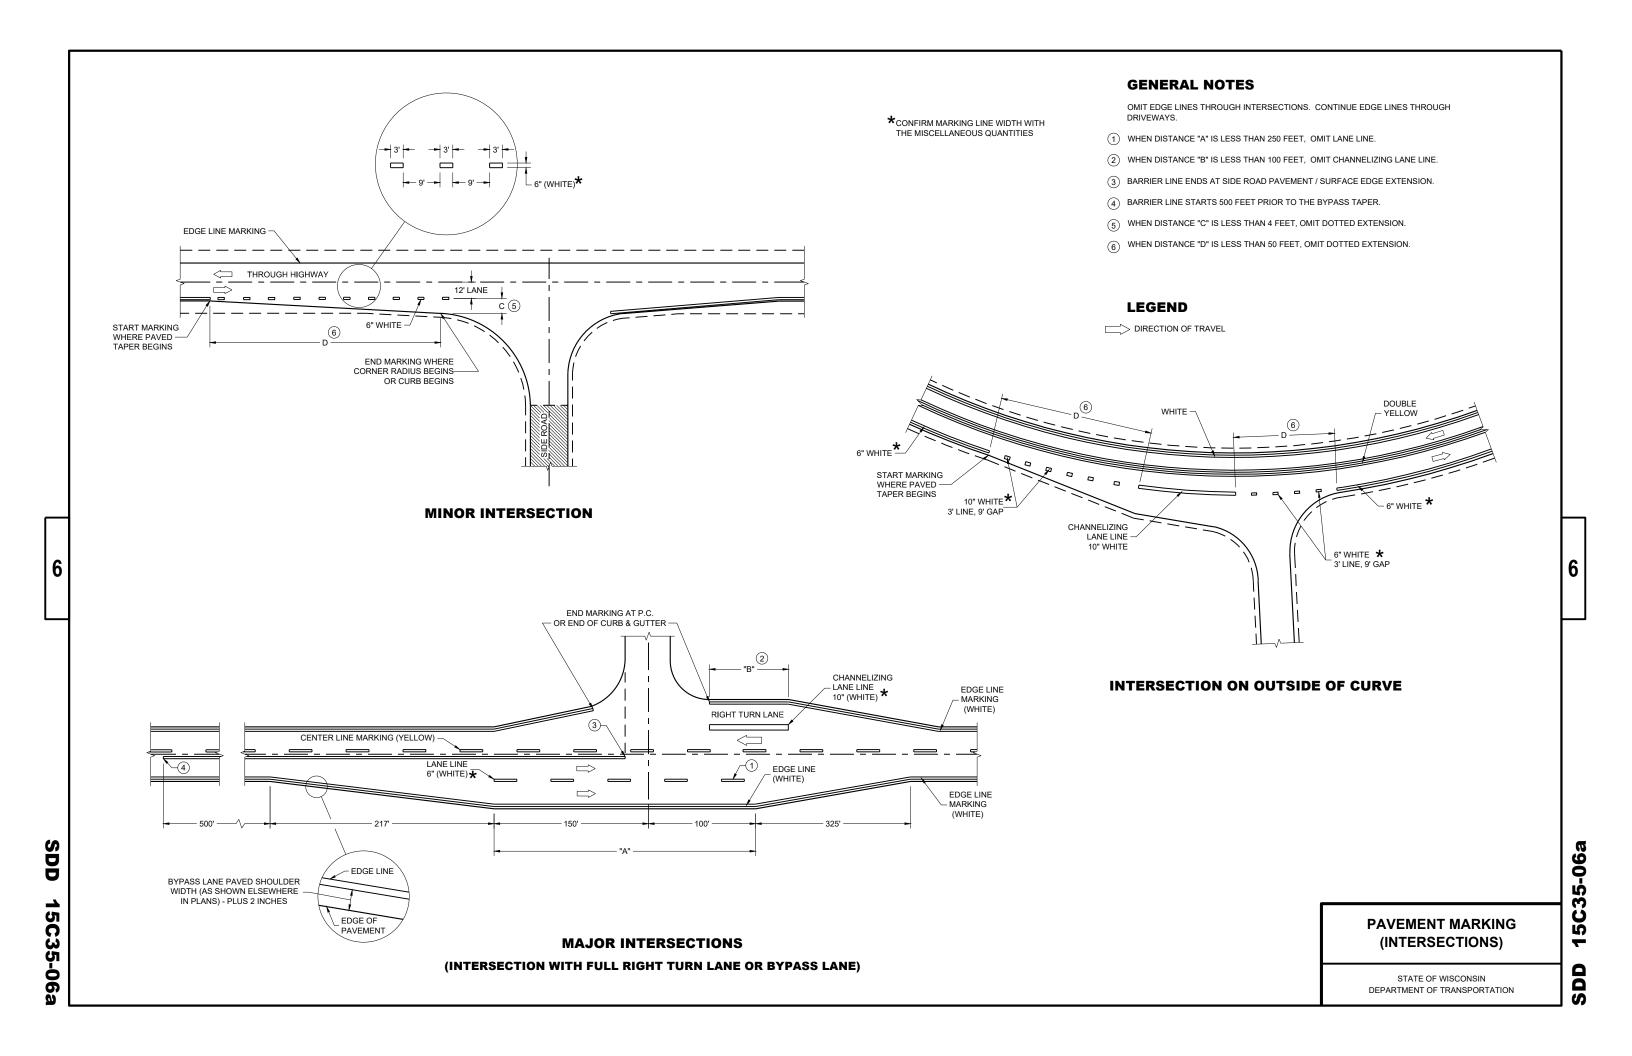

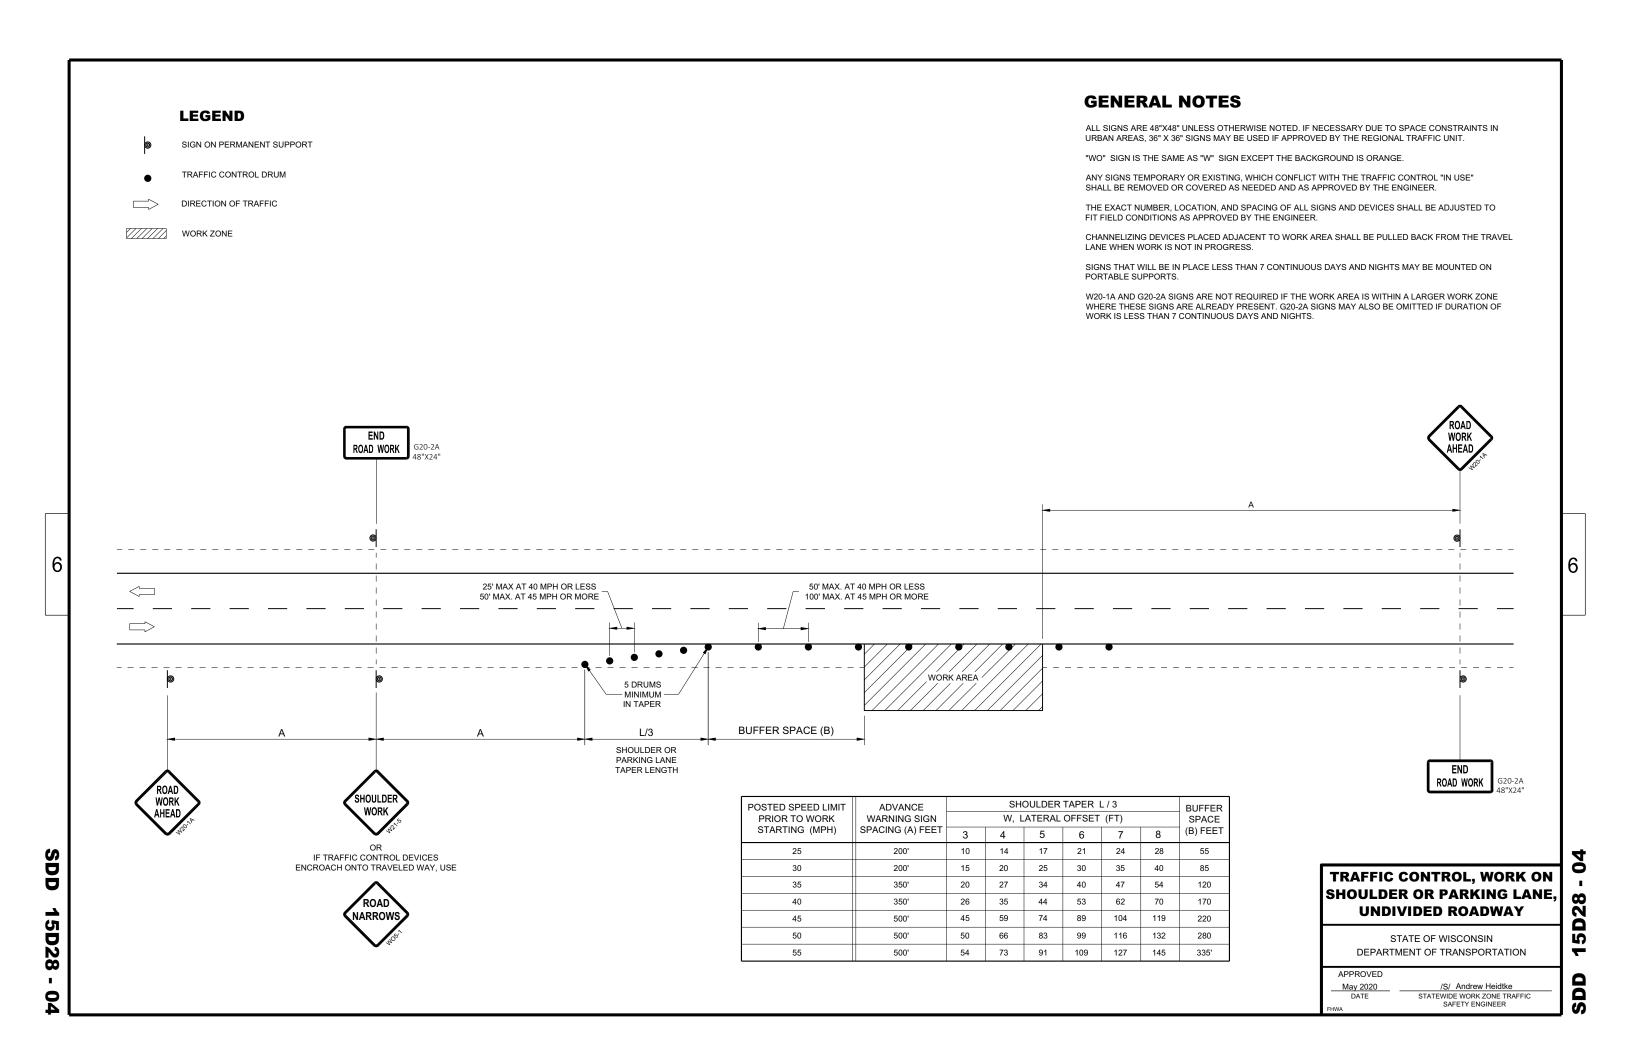

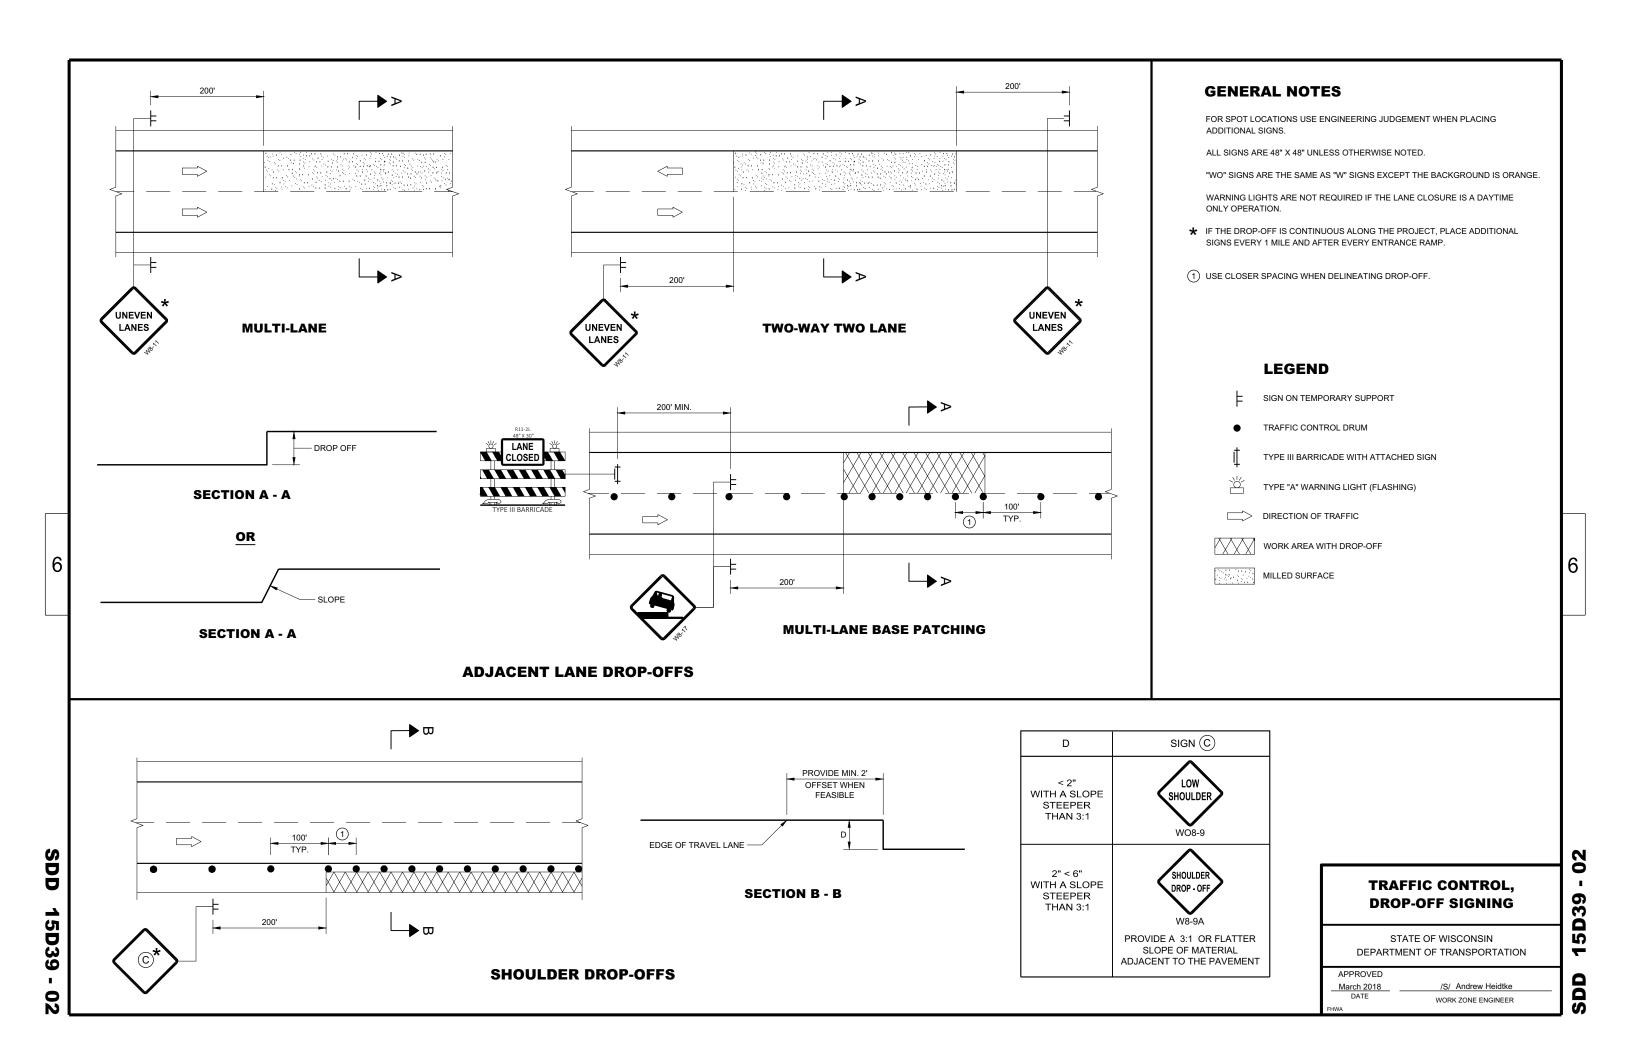

45

**5**0





RURAL AREA (See Note 2)



#### GENERAL NOTES

- 1. Signs wider than 4 feet or 20 sq.ft or larger, shall be mounted on multiple posts. Refer to plate A4-4.
- 2. If signs are mounted on or behind barrier wall, see A4-10 sign plate.

The Double Arrow sign (W12-1D) shall be mounted at a height of 2'-3" ( $\pm$ ) 3". The Chevron sign (W1-8), Roundabout Chevron panel (R6-4B), Enhanced Reference Markers, Clearance Markers (W5-52), Mile Markers (D10 series), In Road Object Markers (W5-54) & End of Road Markers (W5-56) shall be mounted at a height of 4'-3" ( $\pm$ ) 3".

- 3. For expressways and freeways, mounting height is 7'- 3"  $(\pm)$  3" or 6'-3"  $(\pm)$  3" depending upon existence of a sub-sign.
- 4. Minimum mounting height for signs mounted on traffic signal poles is 5' 3'' ( $\frac{+}{-}$ ) 3''.
- 5. Offset distance shall be consistent with existing signs or consistent throughout length of project.
- 6. Folding signs shall be mounted at a height of 5'-3'' ( $\pm$ ) 3'' or as directd by the Engineer.

2' Min - 4' Max (See Note 5)



White Edgeline
Location

Outside Edge
of Gravel

POST EMBEDMENT DEPTH

Area of Sign	
Installation	D
( Sq.Ft.)	(Min)
20 or Less	4'
Greater than 20	5'

The existence of curb and gutter does not in itself mandate the vertical clearance illustrated. That height is typically measured where there is sidewalk adjacent to the roadway or parking is permitted. In the absence of sidewalk vertical clearance is measured from the top of the curb. Offset of signs is measured from the flow line.

* 6 feet from edge of a paved shoulder or 12 feet from the edge of pavement (edge line location) or 2 feet from outside edge of gravel, whichever is greater unless directed by project engineer.

PLOT BY : mscj9h

TYPICAL INSTALLATION
OF PERMANENT TYPE II
SIGNS ON SINGLE POSTS

WISCONSIN DEPT OF TRANSPORTATION

APPROVED

Matthew R Rawh

For State Traffic Engineer

DATE 12/6/23 PLATE NO. _A4-3.23

Ε

PROJECT NO: HWY: COUNTY: SHEET NO:



NOTES: 1. ALL MATERIAL TO BE APPROVED

BY ENGINEER PRIOR TO INSTALLATION

- 2. SEE SIGN PLATE A4-8 FOR SIGN HARDWARE REQUIREMENTS
- 3. 18 INCH X 18 INCH SQUARE BOX-OUTS MAY BE USED FOR INSTALLATIONS IN EXISTING CONCRETE OR ASPHALT LOCATIONS.



#### **ELEVATION VIEW**

DETAIL OF STEEL 2 X 2 SIGN POST IN BOX-OUT



DETAIL OF WOOD 4 X 6 SIGN POST IN BOX-OUT

HWY:



#### PLAN VIEW

COUNTY:

FOR NEW CONCRETE/ASPHALT INSTALLATIONS

SIGN POST BOX-OUTS A4-3B

WISCONSIN DEPT OF TRANSPORTATION

For State Traffic Engineer

DATE 1/27/14 PLATE NO. A4-3B.1

SHEET NO:

FILE NAME : C:\CAEFiles\Projects\tr_stdplate\A43B.DGN

PROJECT NO:

PLOT DATE: 27-JAN-2014 09:48

PLOT NAME :

PLOT BY: mscsja

PLOT SCALE: 13.659812:1.000000

APPROVED

WISDOT/CADDS SHEET 42





2'Min - 4'Max (See Note 6)



	SIGN SHAPE OTHER THAN DIAMOND (TWO POSTS REQUIRED)				
	L	E			
***	Greater than 48" Less than 60"	12"			
	60" to 108"	L/5			

HWY:

SIGN SHAPE OTHER THAN	DIAMOND
(THREE POSTS REQUIR	RED)
L	E
Greater than 108" to 144"	12''

#### GENERAL NOTES

- 1. For 3 or 4 post installations, individual post spacing shall be greater than 3'-6".
- 2. See tables below for required number of posts.
- 3. For expressways and freeways, mounting height is 7'-3" (±) 3" or 6'-3" (±) 3" depending upon existence of sub-sign.
- 4. The (±) tolerance for mounting height is 3 inches.
- 5. J-Assemblies are considered to be one sign for mounting height.
- 6. Offset distance shall be consistent with existing signs or consistent throughout length of project.
- 7. Folding signs shall be mounted at a height of 5'-3'' ( $\pm$ ) 3'' or as directed by the engineer.
- 8. The Double Arrow sign (W12-1) shall be mounted at a height of 2'-3" (±) 3". The Chevron sign (W1-8), Roundabout Chevron panel (R6-4B), Clearance Markers (W5-52), Mile Markers (D10 series), In Road Object Markers (W5-54) & End of Road Markers (W5-56) shall be mounted at a height of 4"-3" (±) 3".
- * 6 feet from edge of a paved shoulder or 12 feet from the edge of pavement (edge line location) or 2 feet from outside edge of gravel, whichever is greater unless directed by project engineer.
- ** The existence of curb and gutter does not in itself mandate the vertical clearance illustrated. That height is typically measured where there is sidewalk adjacent to the roadway or parking is permitted. In the absence of sidewalk vertical clearance is measured from the top of the curb. Offset of signs is measured from the flow line.
- $\times \times \times$  See A4-3 sign plate for signs 4' or less in width and less than 20 S.F. in area.

#### POST EMBEDMENT DEPTH

	ı
Area of Sign	
Installation	D
( Sq. Ft.)	(Min)
20 or Less	4'
Greater than 20	5'

TYPICAL INSTALLATION OF TYPE II SIGNS ON MULTIPLE POSTS

WISCONSIN DEPT OF TRANSPORTATION

APPROVED

Matther R Rauch
For State Traffic Engineer

DATE 12/6/23

PLATE NO. <u>A4-4.16</u>

Ε

CUEET NO.

SHEET NO:

FILE NAME : C:\CAEfiles\Project\tr_stdplate\A44.dgn

PROJECT NO:


COUNTY:

PLOT DATE: 6-DEC 2023 11:31

PLOT NAME :

PLOT BY : mscj9h

PLOT SCALE: \$\$.....plotscale.....\$\$ WISDOT/CADDS SHEET 42

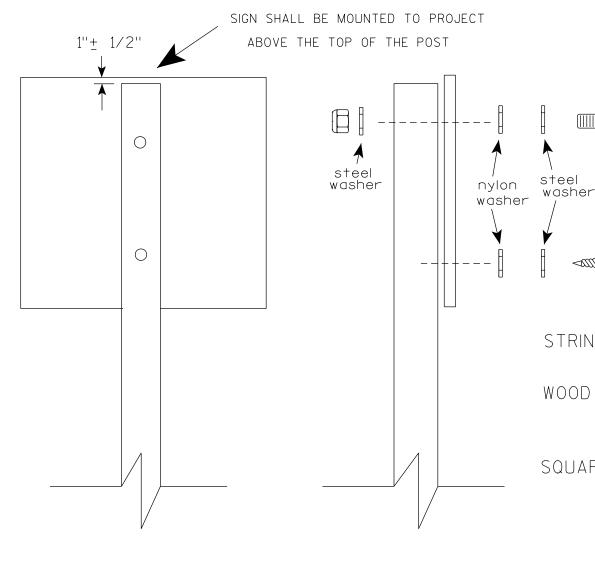

Nuts, bolts and lags used for mounting signs shall have hexagonal heads and shall be either:

- a. Hot dip galvanized in accordance with ASTM Designation: A 153. Class D. or SC 3
- b. Electro-galvanized in accordance with ASTM Designation: B 633, TYPE III, SC 3.

Threads on bolts and nuts shall be manufactured with sufficient allowance for the cadmium plate or galvanized coating to permit the nuts to run freely on the bolts.

STRINGER BOLTING TO ALUMINUM SIGNS (SEE SIGN PLATE A4-18)

MACHINE BOLTS -  $\frac{5}{16}$ " X 1-3/4" Length w/ lock nuts

WOOD POSTS  $(4'' \times 6'')$ 

LAG SCREWS - 3/8" X 3" (NO STRINGERS ON BACK OF SIGN) 3/8" X 4" (STRINGERS ON BACK OF SIGN)

SQUARE STEEL POSTS (2" x 2")

MACHINE BOLTS - 3/8" X 3-1/4" Length w/ nuts (NO STRINGER ON BACK OF SIGN) 3/8" X 5" Length w/ nuts (STRINGERS ON BACK OF SIGN)

RIVETS - 3/32 " (6605-9-6) BULB-TITE. TRI-FOLD. ALUMINUM BODY/MANDREL O.D. FLANGE .720-.765 INCH, GRIP RANGE .042-.375 INCH

WASHERS (ALL POSTS) -

1-1/4" O.D. X  $\frac{3}{8}$ " I.D. X  $\frac{1}{16}$ " STEEL 1-1/4" O.D. X  $\frac{3}{8}$ " I.D. X .080 NYLON

Two different fastening systems are shown for illustration purposes. On any individual sign, either one or the other system shall be used. Actual number of fasteners per sign varies with the sign area, but normally there are two. For a single post installation, all signs greater than 9 sq.ft. require the use of 3 fasteners.

ATTACHMENT OF SIGNS TO POSTS

APPROVED

DATE 4/1/2020

PLATE NO. <u>A4-8.9</u>

FILE NAME : C:\CAEFiles\Projects\tr_stdplate\A48.DGN

PROJECT NO:

PLOT DATE: 01-APRIL-2020

PLOT BY : dotc4c

WISDOT/CADDS SHEET 42

Ε

WISCONSIN DEPT OF TRANSPORTATION

Matther ≠or State Traffic Engineer

SHEET NO:



PROJECT NO: HWY: COUNTY: SHEET NO: FILE NAME : C:\CAEFiles\Projects\tr_stdplate\A49.DGN PLOT DATE: 05-FEB-2015 17:09 PLOT BY: mscsja PLOT NAME : PLOT SCALE: 13.659812:1.000000

DATE 2/05/15

PLATE NO. <u>A4-9.9</u>

For State Traffic Engineer



## BANDING



SINGLE SIGN





## WASHER PLACEMENT



HWY:

WASHERS (ALL POSTS) -

1-1/4" O.D. X³/₈" I.D. X¹/₁₆" STEEL 1-1/4" O.D.  $\times \frac{3}{8}$ " I.D.  $\times$  .080 NYLON FOR ALL TYPE H SIGNS

CHANNEL

#### GENERAL NOTES

- 1. Any sign over 3 feet in width shall use the V-Block banding method. See A5-10 standard plate.
- 2. Signs 3 feet or greater in height shall have three bracket bands installed. Signs less than 3 feet in height shall have two bracket bands installed.
- 3. Banding and assembly bracket shall be stainless steel. All bands shall be  $\frac{3}{4}$ " in width and 0.025" thickness.
- 4. ALL SIGN MOUNTING BOLTS AND WASHERS SHALL BE EITHER:
  - a. Hot dip or mechanically galvanized in accordance with ASTM Designation: A 153, Class D
  - b. Electro-galvanized in accordance with ASTM designation: B 633, Type III, SC 3

#### "J" ASSEMBLY



STANDARD SIGN SIGN BANDING DETAILS

WISCONSIN DEPT OF TRANSPORTATION

SHEET NO:

APPROVED

DATE 6/10/19

PLATE NO. A5-9.4

Ε

State Traffic Engineer

COUNTY:

PLOT NAME :

PLOT SCALE: \$\$.....plotscale.....\$\$ WISDOT/CADDS SHEET 42

PROJECT NO:

31/2"

VIEW FROM TOP

#### GENERAL NOTES

- 1. WOOD 4"X6" POST MATERIAL SHALL CONFORM TO 507.2.2 OF THE WISDOT STANDARD SPECIFICATIONS
- 2. BLOCK BANDING AND CLIPS SHALL BE STAINLESS STEEL,  $\frac{3}{4}$ " WIDTH AND 0.025" THICKNESS
- 3. SIGNS 3' OR GREATER IN HEIGHT SHALL UTILIZE 3 BLOCK BANDS. SIGNS UNDER 3' IN HEIGHT SHALL UTILIZE 2 BLOCK BANDS
- 4. ACTUAL NUMBER OF FASTENERS PER SIGN VARIES WITH THE SIGN AREA. BUT NORNALLY THERE ARE TWO. FOR SIGNS GREATER THAN 9 S.F. 3 FASTENERS SHALL BE USED.
- 5. ALL SIGN MOUNTING BOLTS AND WASHERS SHALL BE EITHER:
  - a. Hot dip or mechanically galvanized in accordance with ASTM Designation: A 153, Class D
  - b. Electro-galvanized in accordance with ASTM Designation: B 633, TYPE III, SC 3
- 6. ALL BOLTS SHALL HAVE HEXAGONAL HEADS.
- 7. STEEL WASHERS SHALL BE  $1^{1}/_{4}$ " O.D. X  $3/_{16}$ " I.D. X  $1/_{16}$ "
- 8. NYLON WASHERS SHALL BE  $1^{1}/_{4}$ " O.D. X  $3/_{8}$ " I.D. X .080 FOR TYPE H OR TYPE F FACE SIGN

 $\times$  LAG BOLTS SHALL BE  $\frac{3}{8}$ " X  $\frac{2}{2}$ "

BLOCK BANDING DETAIL ( V-BLOCK OPTION )

WISCONSIN DEPT OF TRANSPORTATION

APPROVED

DATE 4/19/2022 PLATE NO. A5-10.3

SHEET NO:

PROJECT NO:

PLOT DATE: 19-APRIL 2022 11:55

PLOT BY : dotc4c

WISDOT/CADDS SHEET 42

Ε

SIGN

## NOTES

- 1. Sign is Type II Type F Reflective
- 2. Color:

Background - Orange Message - Black

- 3. Message Series C
- 4. Corners may be square or rounded when base material is plywood but borders shall be rounded as shown. When base material is metal, the corners and borders shall be rounded.

C —		<u> </u>
		H
		F H B
		F G
		<b>\</b>
I	G20-2A	I

SIZE	А	В	С	D	E	F	G	Н	I	J	K	L	М	N	0	Р	Q	R	S	Т	V	W	X	Υ	Z	Area sq. ft.
1	36	18	1 1/2	3/8	1/2	4	3 3/4	2 1/2	4 1/8	4 1/8	11 1/8	2	1	12 1/8												4.5
2	48	24	1 1/8	1/2	5/8	6	4 1/2	3 3/4	5 %	6 3/4	16 3/4	2 1/2	1 3/4	18 1/2												8.0
2M	48	24	1 1/8	1/2	5/8	6	4 1/2	3 3/4	5 1/8	6 3/4	16 3/4	2 1/2	1 3/4	18 1/2												8.0
3	48	24	1 1/8	1/2	5/8	6	4 1/2	3 3/4	5 1/8	6 3/4	16 3/4	2 1/2	1 3/4	18 1/2												8.0
4	48	24	1 1/8	1/2	5/8	6	4 1/2	3 3/4	5 %	6 3/4	16 3/4	2 1/2	1 3/4	18 1/2												8.0
5	48	24	1 1/8	1/2	5/8	6	4 1/2	3 3/4	5 1/8	6 3/4	16 3/4	2 1/2	1 3/4	18 1/2												8.0

COUNTY:

STANDARD SIGN G20-2A

WISCONSIN DEPT OF TRANSPORTATION

APPROVED Matthew & Rauch

For State Traffic Engineer

DATE 1/26/2023 PLATE NO. G20-2A.10

SHEET NO:

FILE NAME : C:\CAEfiles\Projects\tr_stdplate\G202A.dgn

PROJECT NO:

HWY:

PLOT DATE: 26-JAN 2023 8:27

PLOT BY : dotc4c

PLOT NAME :

PLOT SCALE: \$\$.....plotscale.....\$\$ WISDOT/CADDS SHEET 42



- 1. Sign is Type II Type H Reflective reference WIS DOT Standard Specification for HIGHWAY and STRUCTURE CONSTRUCTION latest edition.
- 2. Color:

Background - Red Message - White

3. Message Series - C

<b>*</b>								— А — ;								<b></b>			<b>A</b>	
									H			G —							F	A
		E						               	- 1			_//								<b>Y</b>
D	E	F	G	Н	I	J	К	L	М	N	0	Р	0	R	S	Т	U	V	W	Х

SIZE	Α	В	С	D	E	F	G	Н	I	J	K	L	М	N	0	Р	0	R	S	T	U	٧	W	Х	Y	Z	Area sq. ft.
1	30				5/8	10	12 1/2	45°		12 3/4																	5.18
2S	30				5/8	10	12 1/2	45°		12 3/4																	5.18
2M	36				3/4	12	15	45°		15 3/8																	7.46
3	36				3/4	12	15	45°		15 3/8																	7.46
4	48				1	16	20	45°		20 1/2																	13.25
5	48				1	16	20	45°		20 1/2																	13.25
6	18				3/8	6	7 3/4	45°		7 3/4																	1.86
7	12				1/4	4	5	45°		5 1/8																	0.78

COUNTY:

STANDARD SIGN R1-1

WISCONSIN DEPT OF TRANSPORTATION

APPROVED

For State Traffic Engineer

DATE <u>11/12/15</u>

PLATE NO. _____R1-1.13

SHEET NO:

FILE NAME : C:\CAEfiles\Projects\tr_stdplate\R11.DGN

HWY:

PROJECT NO:

PLOT DATE: 22-AUG-2017 07:19

PLOT BY: \$\$...plotuser...\$\$ PLOT NAME:

PLOT SCALE: 4.427909:1.000000


WISDOT/CADDS SHEET 42

## NOTES

- 1. Sign is Type II Type H Reflective
- 2. Color:

Background - White Message - Black

- 3. Message Series E
- 4. Substitute appropriate numerals and optically adjust spacing to achieve proper balance.

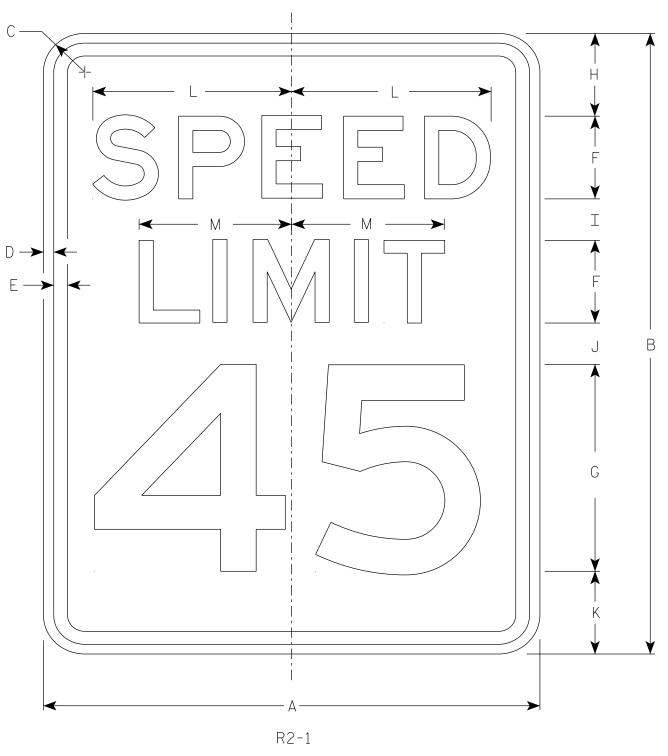

SIZE	Α	В	С	D	E	F	G	Н	I	J	K	L	М	N	0	Р	Q	R	S	Т	U	٧	W	X	Y	Z	Area sq. ft.
1	18	24	1 1/2	3/8	1/2	3	8	3	2	2	3	7 1/4	5 1/2														3.0
25	24	30	1 1/2	3/8	1/2	4	10	3	2 1/4	3 3/8	3 3/8	9 5/8	7 3/8														5.0
2M	30	36	1 1/8	1/2	5/8	5	12	5	2 1/2	2 1/2	4	12	9 1/4														7.5
3	36	48	1 1/8	1/2	5/8	6	14	6	5	5	6	14 3/8	11														12.0
4	36	48	1 1/8	1/2	5/8	6	14	6	5	5	6	14 3/8	11														12.0
5	48	60	3	3/4	1	8	20	6	4 1/2	6 3/4	6 3/4	19 1/4	14 5/8														20.0

COUNTY:

STANDARD SIGN R2-1

1/2 1

WISCONSIN DEPT OF TRANSPORTATION

SHEET NO:

APPROVED .

DATE 2/1/23

Frate Traffic Engineer

B PLATE NO. R2-1.14

FILE NAME : C:\CAEfiles\Projects\tr_stdplate\R21.dgn

HWY:

PROJECT NO:

PLOT DATE: 9-JULY 2024 1:47

PLOT BY : mscj9h

PLOT NAME :

PLOT SCALE: \$\$.....plotscale.....\$\$ WISDOT/CADDS SHEET 42

1

- 1. Sign is Type II Type F Reflective
- 2. Color:

Background - Yellow Message - Black

3. W1-4L is the same as W1-4R except the arrow is reversed along the vertical centerline.

N >
A M M M M M M M M M M M M M M M M M M M
H R Q I
A F → K G → C

W1-4R

SIZE	Α	В	С	D	E	F	G	Н	I	J	K	L	М	N	0	Р	Q	R	S	T	U	٧	W	Х	Υ	Z	Area sq. ft.
1	24		1 1/2	3/8	1/2	3 1/2	2 %	8 1/4	5 1/4	11 1/4	7	1 1/8	4	3	5/8	1/4	1 1/2	5									4.0
25	30		1 1/8	1/2	5/8	4 3/8	3 1/4	10 1/4	6 1/2	14	8 3/4	1 3/8	5	3 %	3/4	3/8	1 1/8	6 1/4									6.25
2M	36		2 1/4	5/8	3/4	5 1/4	4	12 3/8	7 1/8	16 1/8	10 1/2	1 5/8	6	4 1/2	1	1/2	2 1/4	7 1/2									9.0
3	36		2 1/4	5/8	3/4	5 1/4	4	12 3/8	7 1/8	16 1/8	10 1/2	1 5/8	6	4 1/2	1	1/2	2 1/4	7 1/2									9.0
4	36		2 1/4	5/8	3/4	5 1/4	4	12 3/8	7 1/8	16 1/8	10 1/2	1 5/8	6	4 1/2	1	1/2	2 1/4	7 1/2									9.0
5	48		3	3/4	1	7	5 1/4	16 1/2	10 1/2	22 1/2	14	2 1/4	8	6	1 1/4	5/8	3	10				·					16.0

COUNTY:

STANDARD SIGN W1-4

WISCONSIN DEPT OF TRANSPORTATION

APPROVED Matthew K Kauch

For State Traffic Engineer

DATE 3/23/2023 PLATE NO. W1-4.12

SHEET NO:

Ε

FILE NAME : C:\Users\PROJECTS\tr_stdplate\W14.dgn

HWY:

PROJECT NO:

PLOT DATE: 30-OCT 2023 9:43

PLOT BY : dotc4c

PLOT NAME :

PLOT SCALE: \$\$.....plotscale.....\$\$ WISDOT/CADDS SHEET 42

- 1. Sign is Type II Type F Reflective
- 2. Color:

Background - Yellow Message - Black

3. Message Series - E

	F G V
W10	0-1

SIZE	Α	В	С	D	E	F	G	Н	I	J	К	L	М	N	0	Р	Q	R	S	Т	U	V	W	Х	Y	Z	Area sq. ft.
1	30			3/8	5/8	7	3 1/2	45°	12 3/8	7 1/8	3	1 1/2															4.91
25	36			5/8	3/4	8	4	45°	14 3/8	8 %	4	2															7.07
2M	36			5/8	3/4	8	4	45°	14 3/8	8 %	4	2															7.07
3	36			5/8	3/4	8	4	45°	14 3/8	8 5/8	4	2															7.07
4	48			3/4	1 1/4	10	5	45°	18 3/8	11 5/8	5	2 1/2															12.57
5																											

COUNTY:

STANDARD SIGN W10-1

WISCONSIN DEPT OF TRANSPORTATION

APPROVED Matthew & Rawh

For State Traffic Engineer

SHEET NO:

DATE 3/27/24 PLATE NO. W10-1.9

FILE NAME : C:\CAEfiles\Projects\tr_stdplate_W101.dgn

HWY:

PROJECT NO:

PLOT DATE: 27-MAR 2024 3:30

PLOT BY: mscj9h

PLOT NAME :

PLOT SCALE: \$\$.....plotscale.....\$\$ WISDOT/CADDS SHEET 42




- 1. Sign is Type II Type F Reflective
- 2. Color:

Background - Yellow

Message – Black

3. Message Series - Lines 1 and 2 are Series D. Line 3 is series C.

4. Corners and borders shall be rounded on all base materials for this sign.

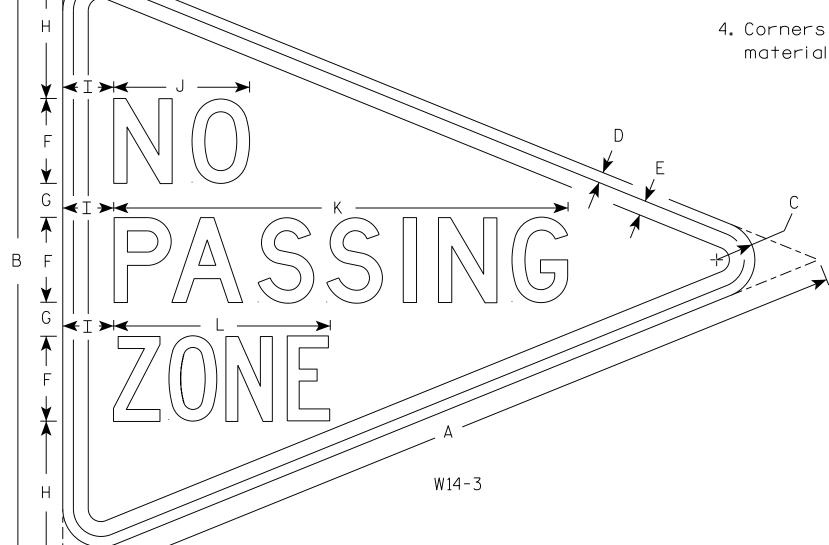

			,																								
SIZE	Α	В	С	D	E	F	G	Н	I	J	K	L	М	N	0	Р	0	R	S	Т	U	٧	W	Х	Y	Z	Area sq. ft.
1																											
2S	48	36	2 1/4	5/8	<i>7</i> ⁄8	5	2	8 ½	3	8	26 ¾	12 3/4															5.56
2M																											
3																											
4																											
5																											
PRO	JECT	NO:					Н	WY:					COL	INTY:													

STANDARD SIGN W14-3

WISCONSIN DEPT OF TRANSPORTATION

500 3/21/17

E 3/21/17 PLATE NO. W14-3

SHEET NO:

FILE NAME : C:\CAEfiles\Projects\tr_stdplate\W143.DGN

PLOT DATE: 21-MAR-2017 08:48

PLOT BY: \$\$...plotuser...\$\$ PLOT NAME:

PLOT SCALE : 5.650195:1.000000


WISDOT/CADDS SHEET 42


## NOTES

- 1. Sign is Type II Type F Reflective
- 2. Color:

Background - Orange Message - Black

- 3. Message Series C
- 4. Corners may be square or rounded when base material is plywood but borders shall be rounded as shown.
  When base material is metal, the corners and borders shall be rounded.

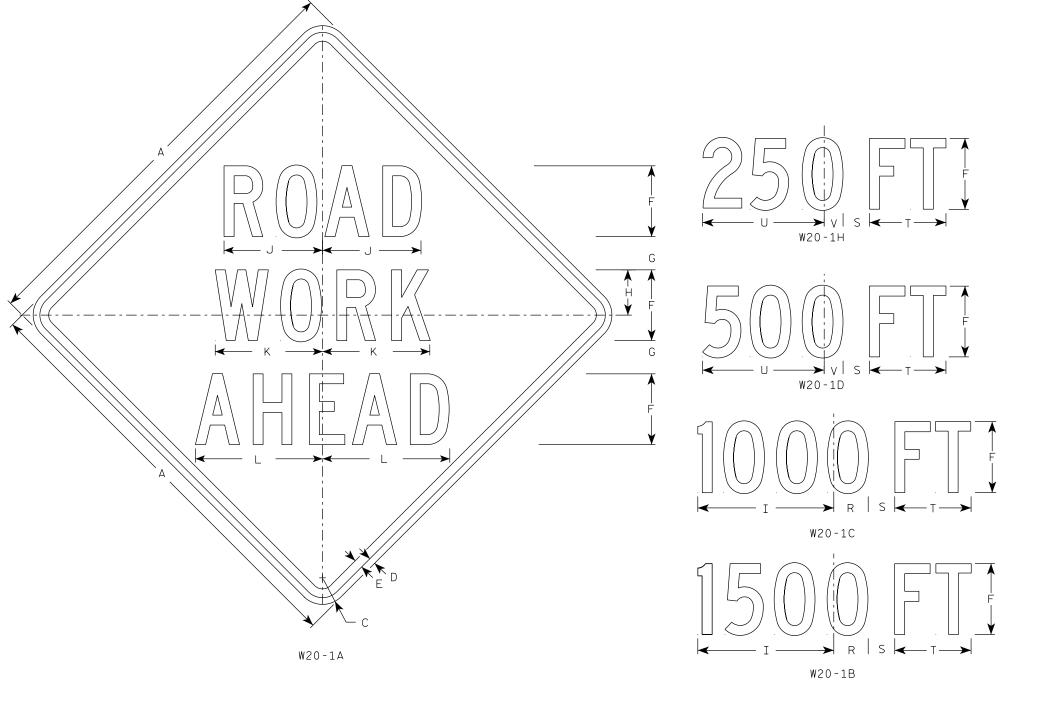

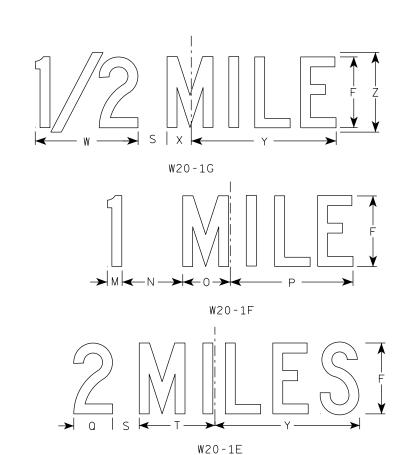

SIZE	Α	В	С	D	E	F	G	Н	I	J	K	L	М	N	0	Р	Q	R	S	Т	U	٧	W	X	Y	Z	Area sq. ft.
1	36		2 1/4	5/8	3/4	5	2 5/8	3 1/4	10 1/8	7	7	8 1/8	1 1/8	4 1/2	3 1/2	9	3 1/4	2 1/2	2 1/4	5	9	1 3/8	8	1 3/4	10 3/4	6	9.0
25	48		3	3/4	1	8	3 3/4	5 1/8	15 3/8	11 1/8	12 1/8	14 3/8	1	6 %	5 3/8	13 1/8	4 3/8	3 1/8	3	8	13 ¾	2 1/8	11 1/8	2 3/4	16 3/8	9	16.0
2M	48		3	3/4	1	8	3 3/4	5 1/8	15 3/8	11 1/8	12 1/8	14 3/8	1	6 1/8	5 3/8	13 1/8	4 3/8	3 1/8	3	8	13 ¾	2 1/8	11 1/8	2 3/4	16 3/8	9	16.0
3	48		3	3/4	1	8	3 3/4	5 1/8	15 3/8	11 1/8	12 1/8	14 3/8	1	6 %	5 3/8	13 1/8	4 3/8	3 1/8	3	8	13 ¾	2 1/8	11 1/8	2 3/4	16 3/8	9	16.0
4	48		3	3/4	1	8	3 3/4	5 1/8	15 3/8	11 1/8	12 1/8	14 3/8	1	6 1/8	5 3/8	13 1/8	4 3/8	3 1/8	3	8	13 ¾	2 1/8	11 1/8	2 3/4	16 3/8	9	16.0
5	48		3	3/4	1	8	3 3/4	5 1/8	15 3/8	11 1/8	12 1/8	14 3/8	1 5/8	6 %	5 3/8	13 1/8	4 3/8	3 1/8	3	8 %	13 ¾	2 1/8	11 7/8	2 3/4	16 3/8	9	16.0

STANDARD SIGN W20-1A, B, C, D, E, F, G & H


WISCONSIN DEPT OF TRANSPORTATION


APPROVED Matthew & Rauch
For State Traffic Engineer


DATE 1/10/2024 PLATE NO. W20-1.12


SHEET NO:


PROJECT NO:

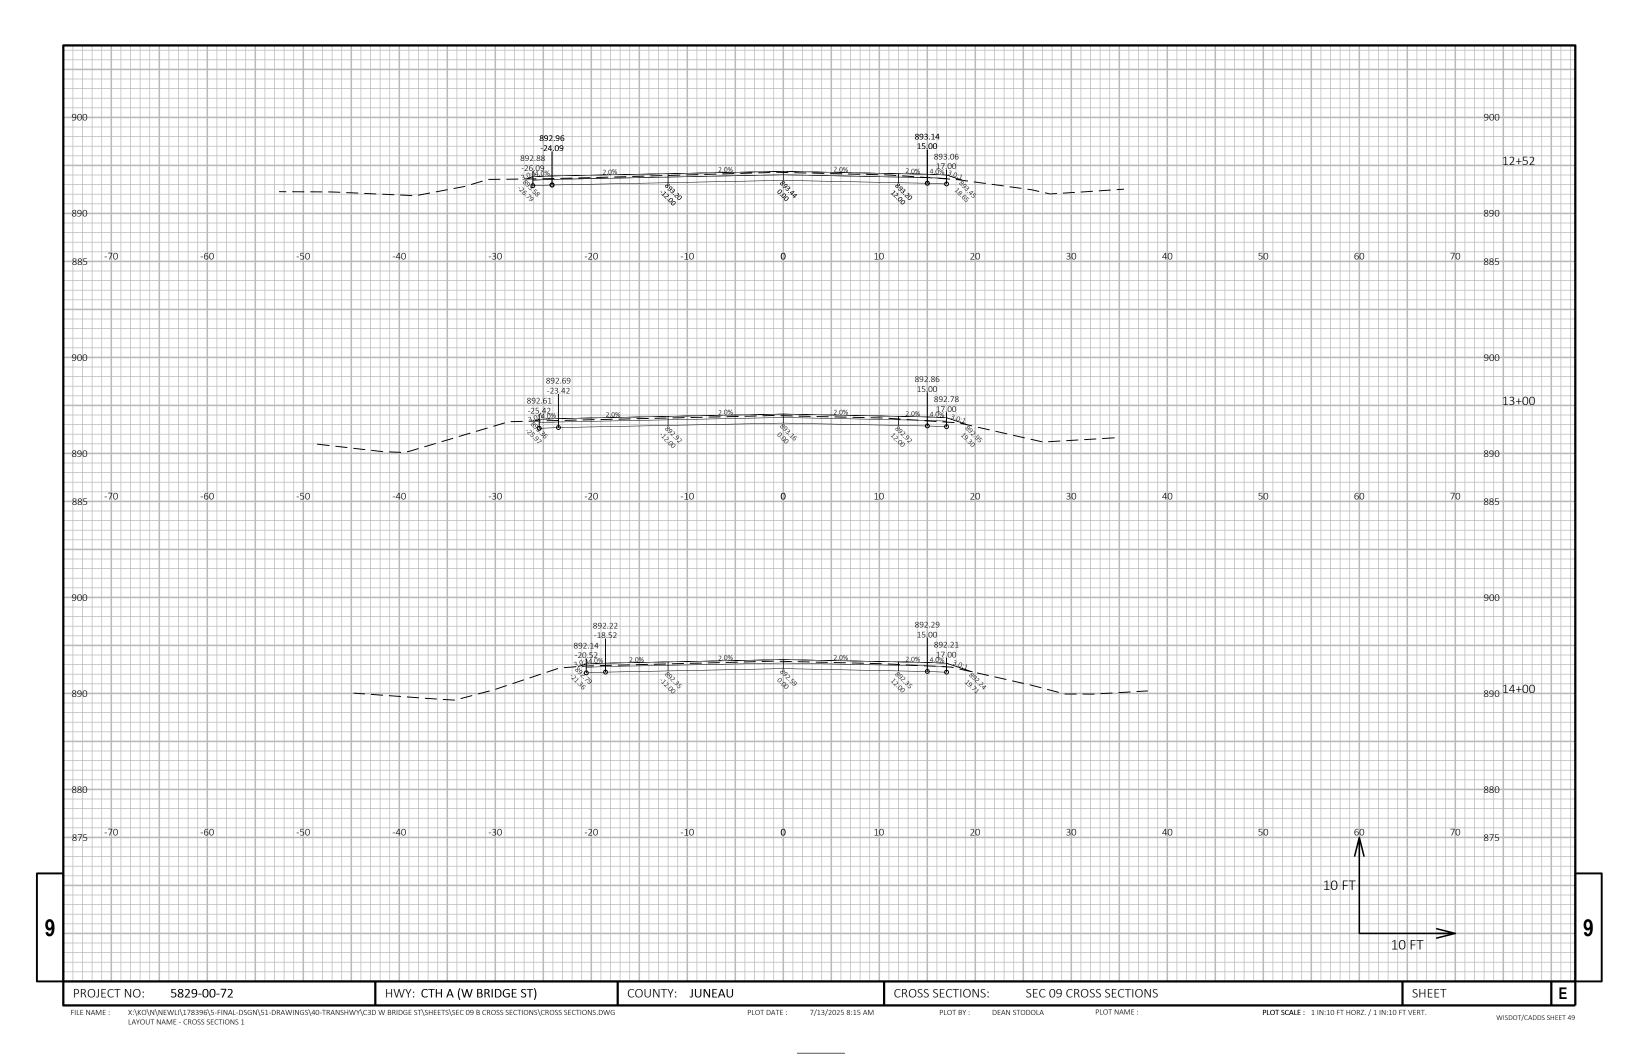


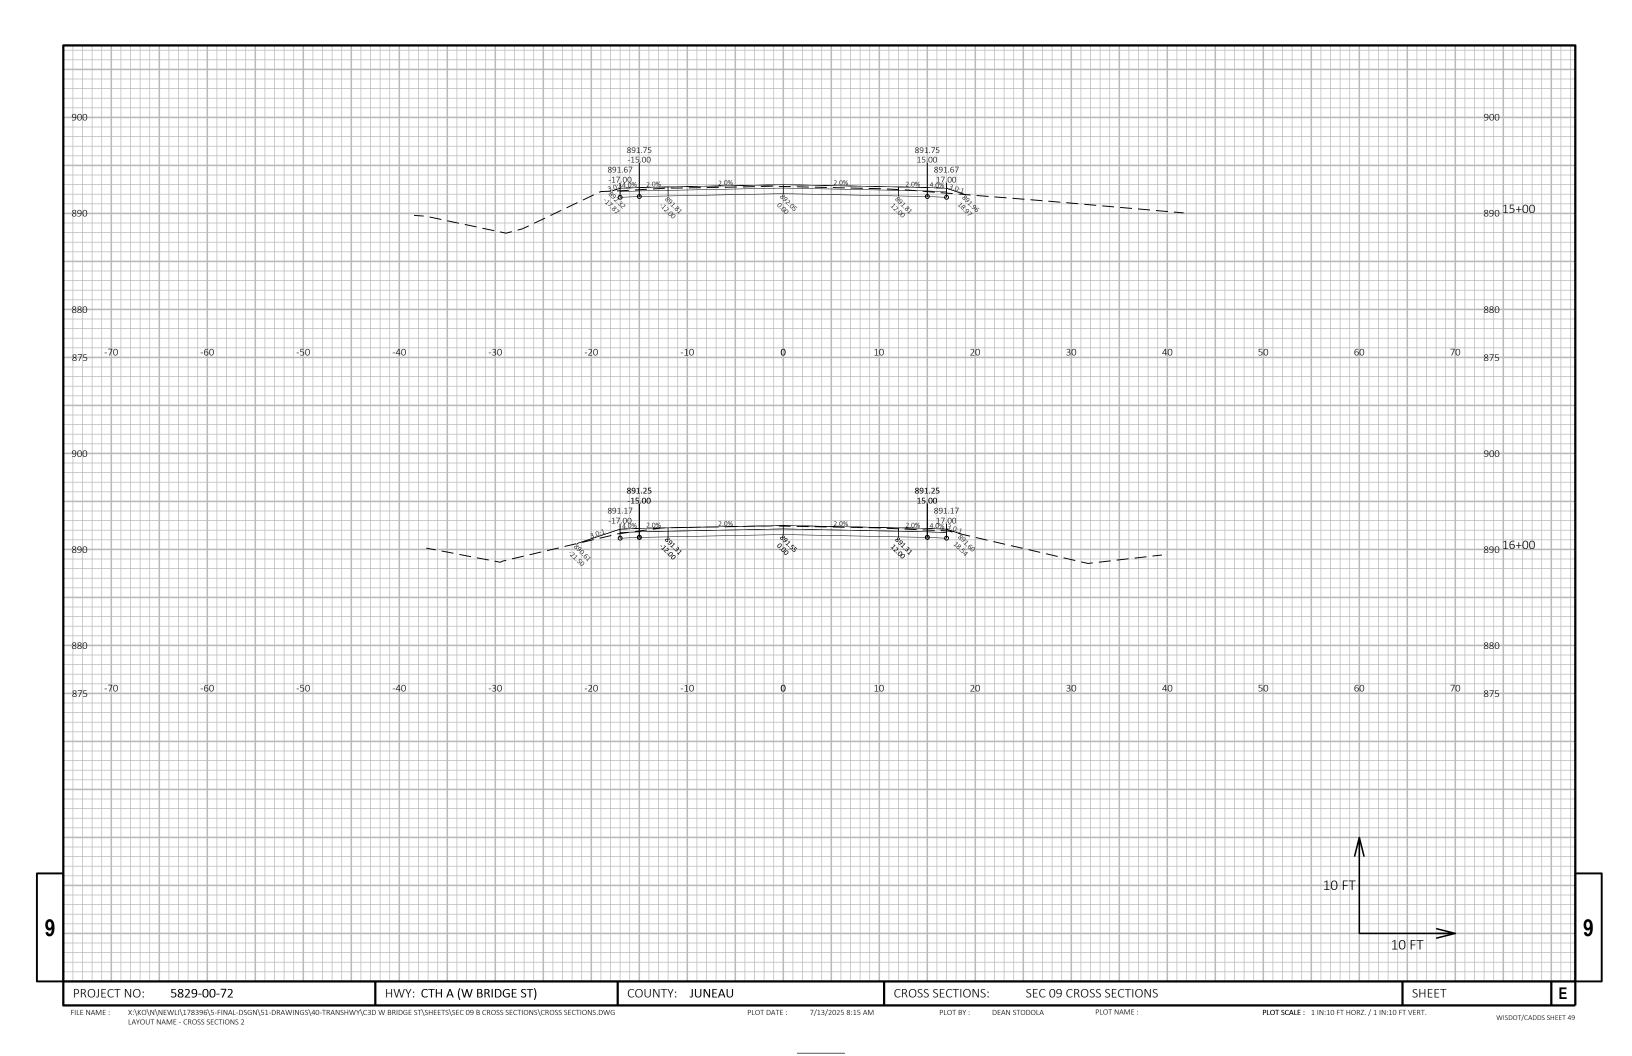


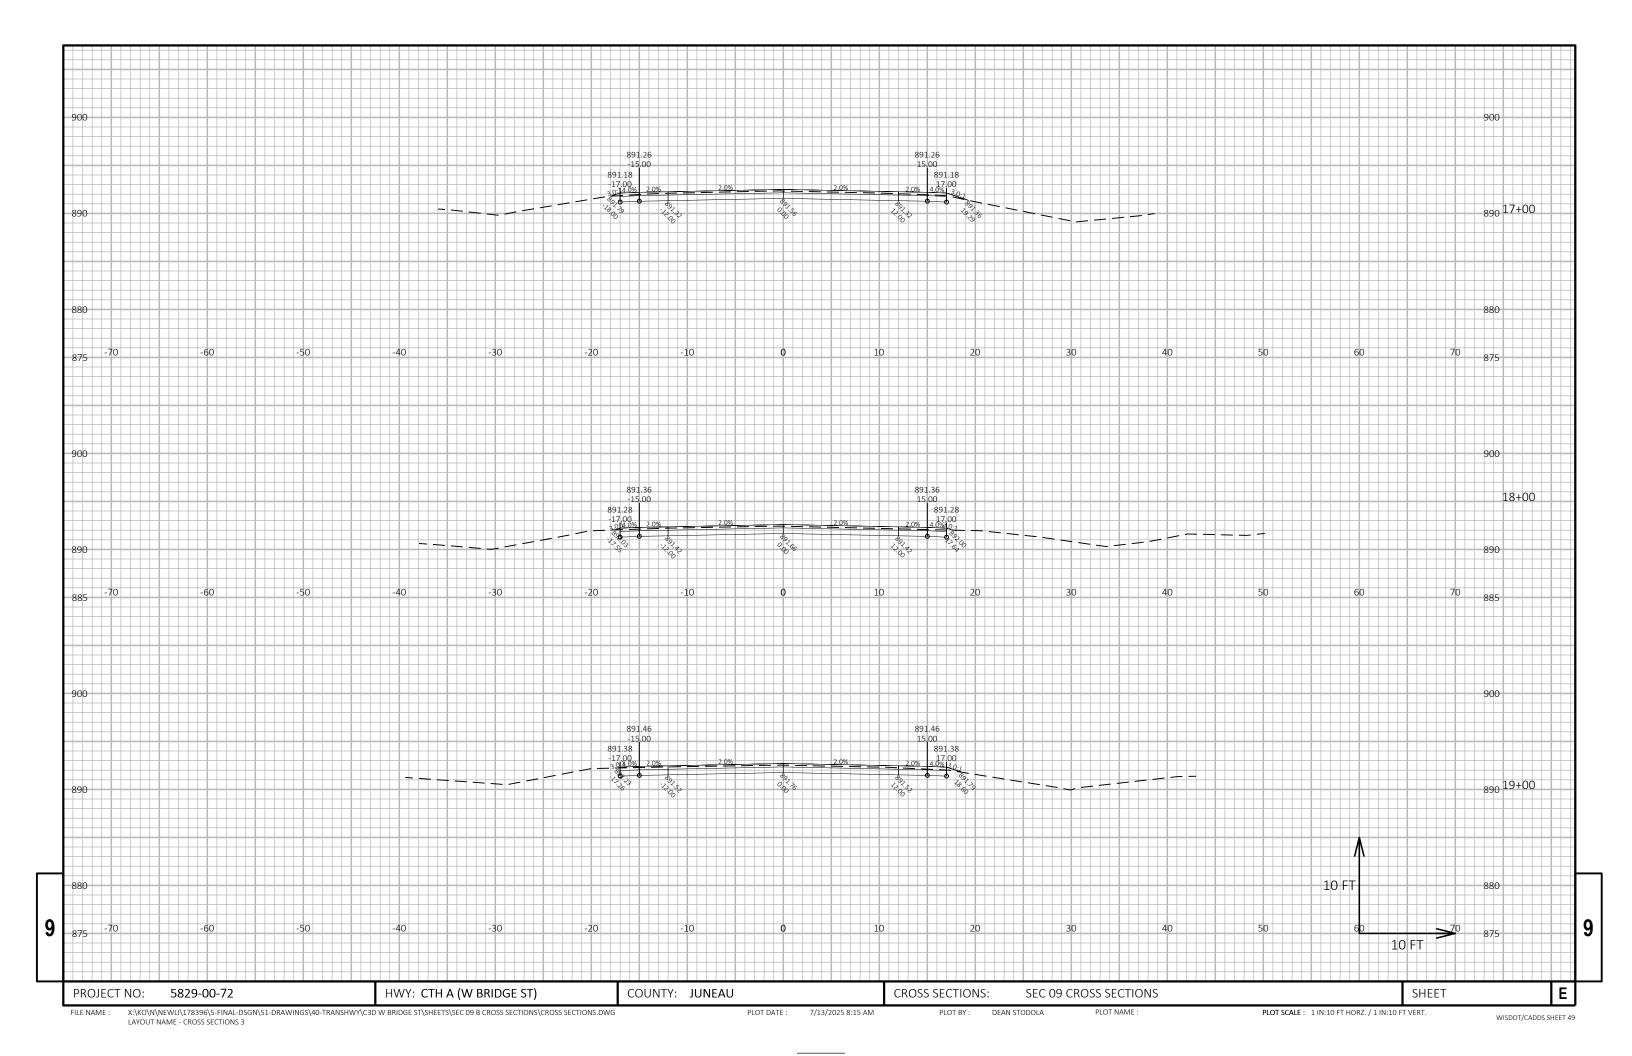

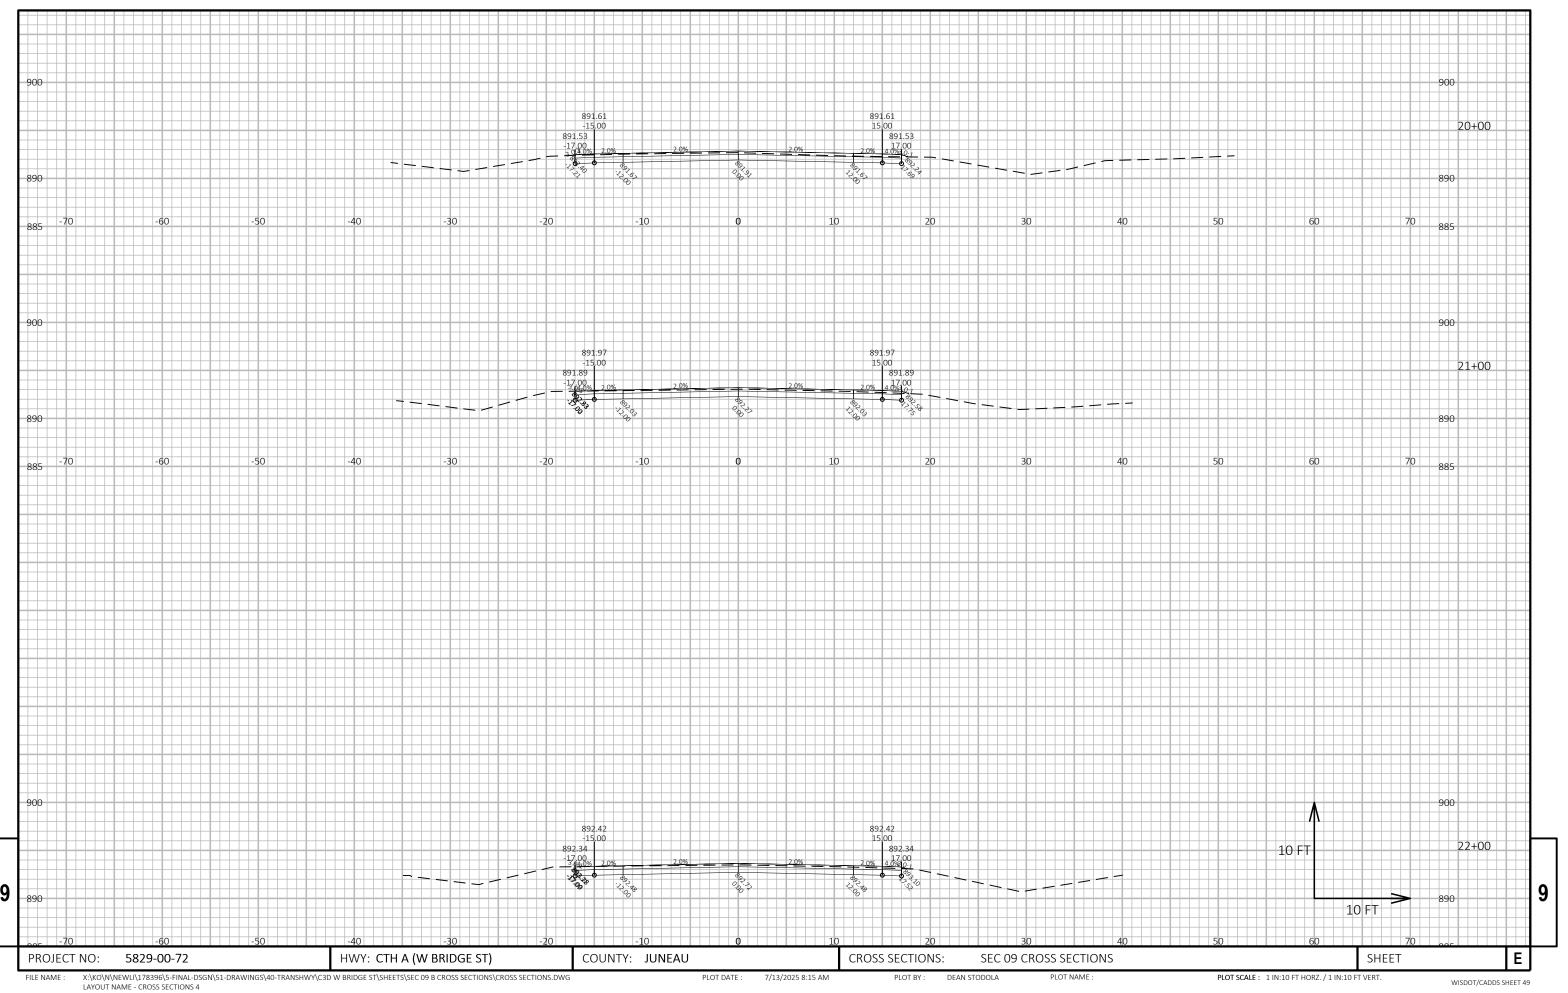

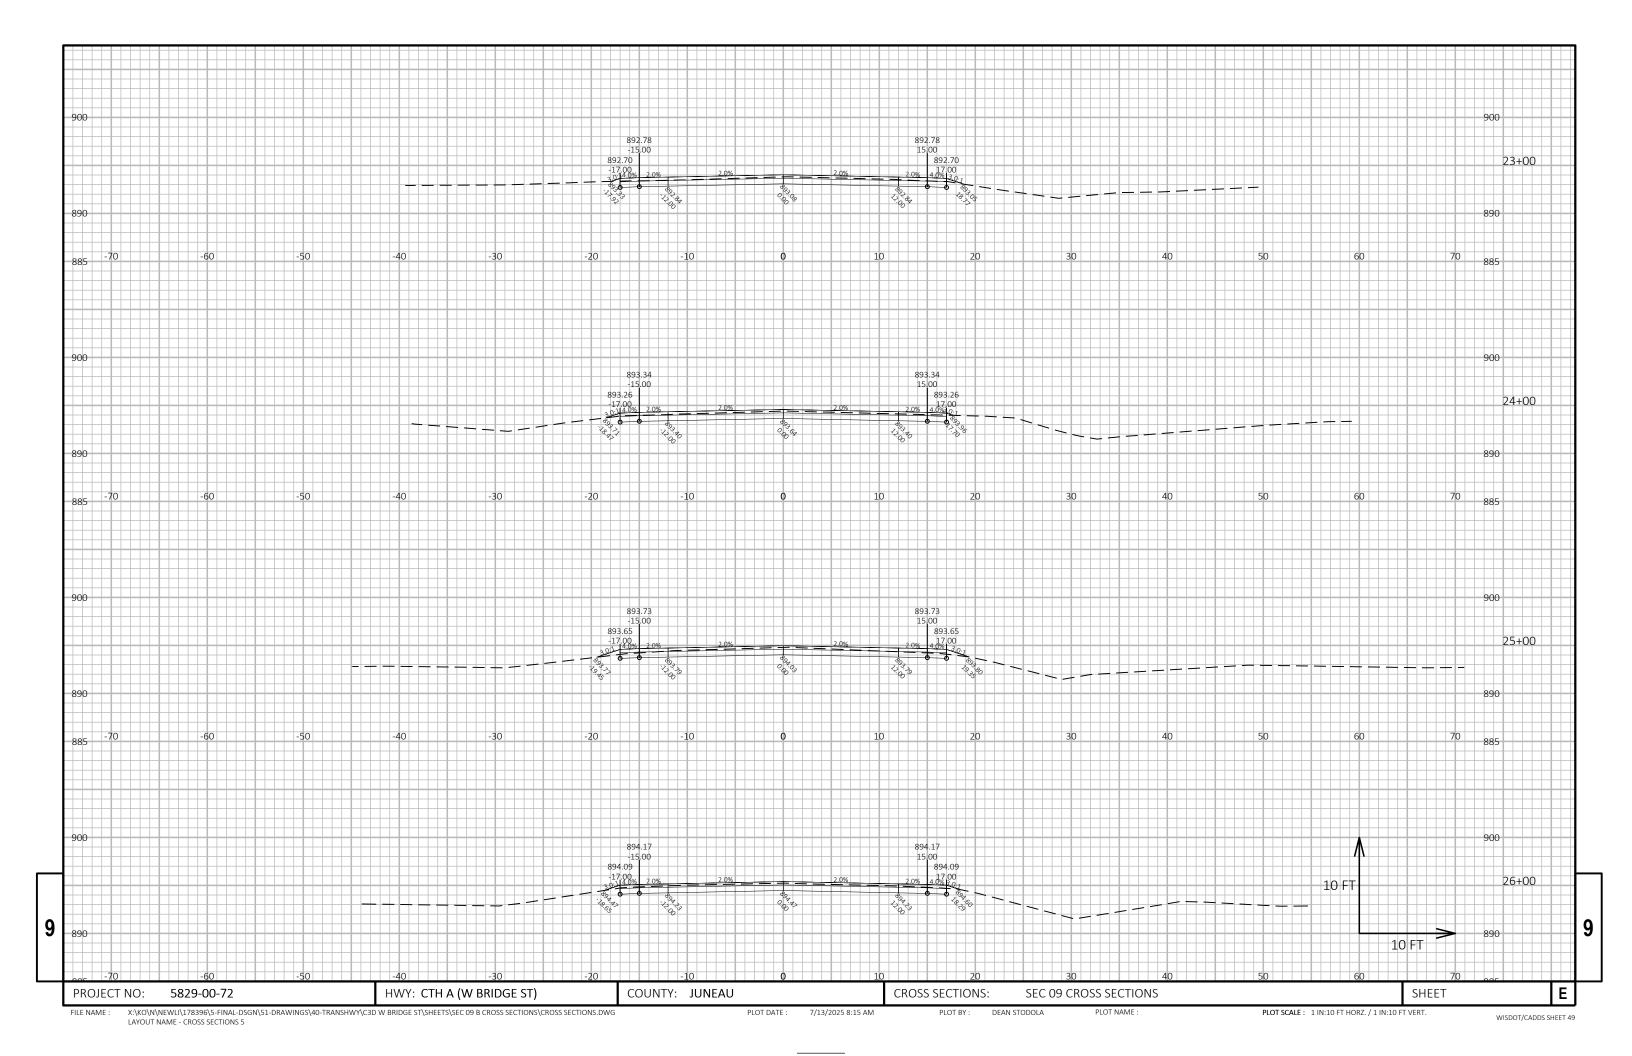

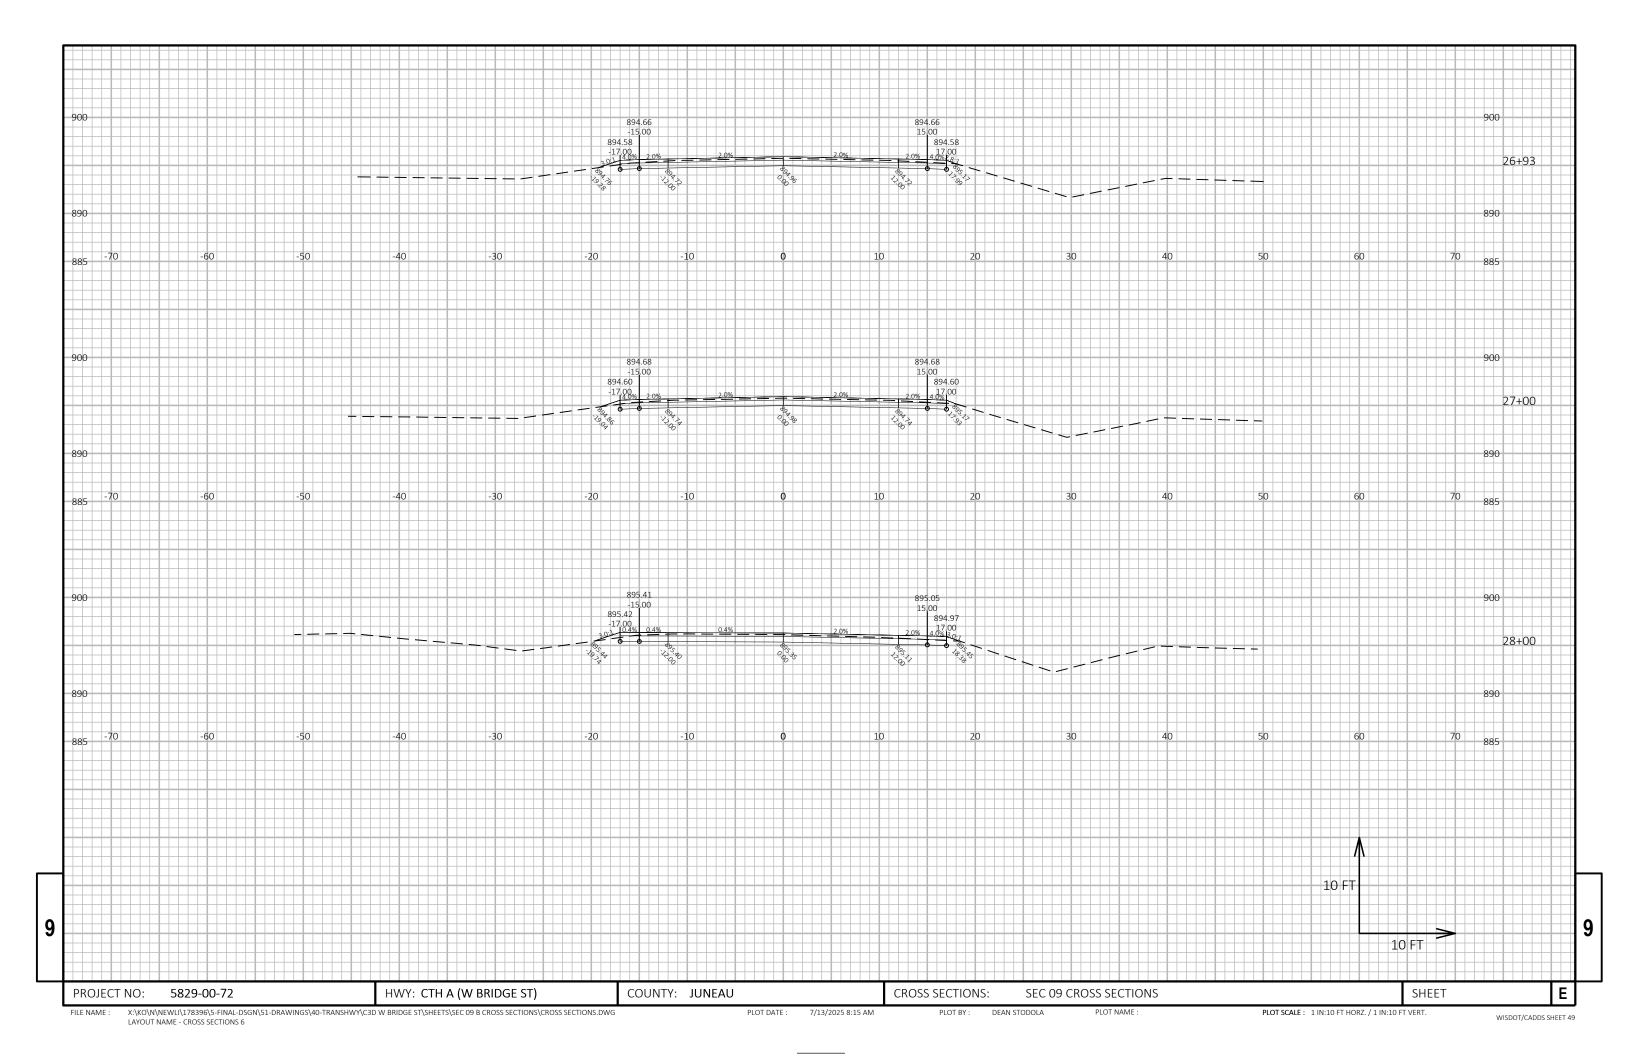

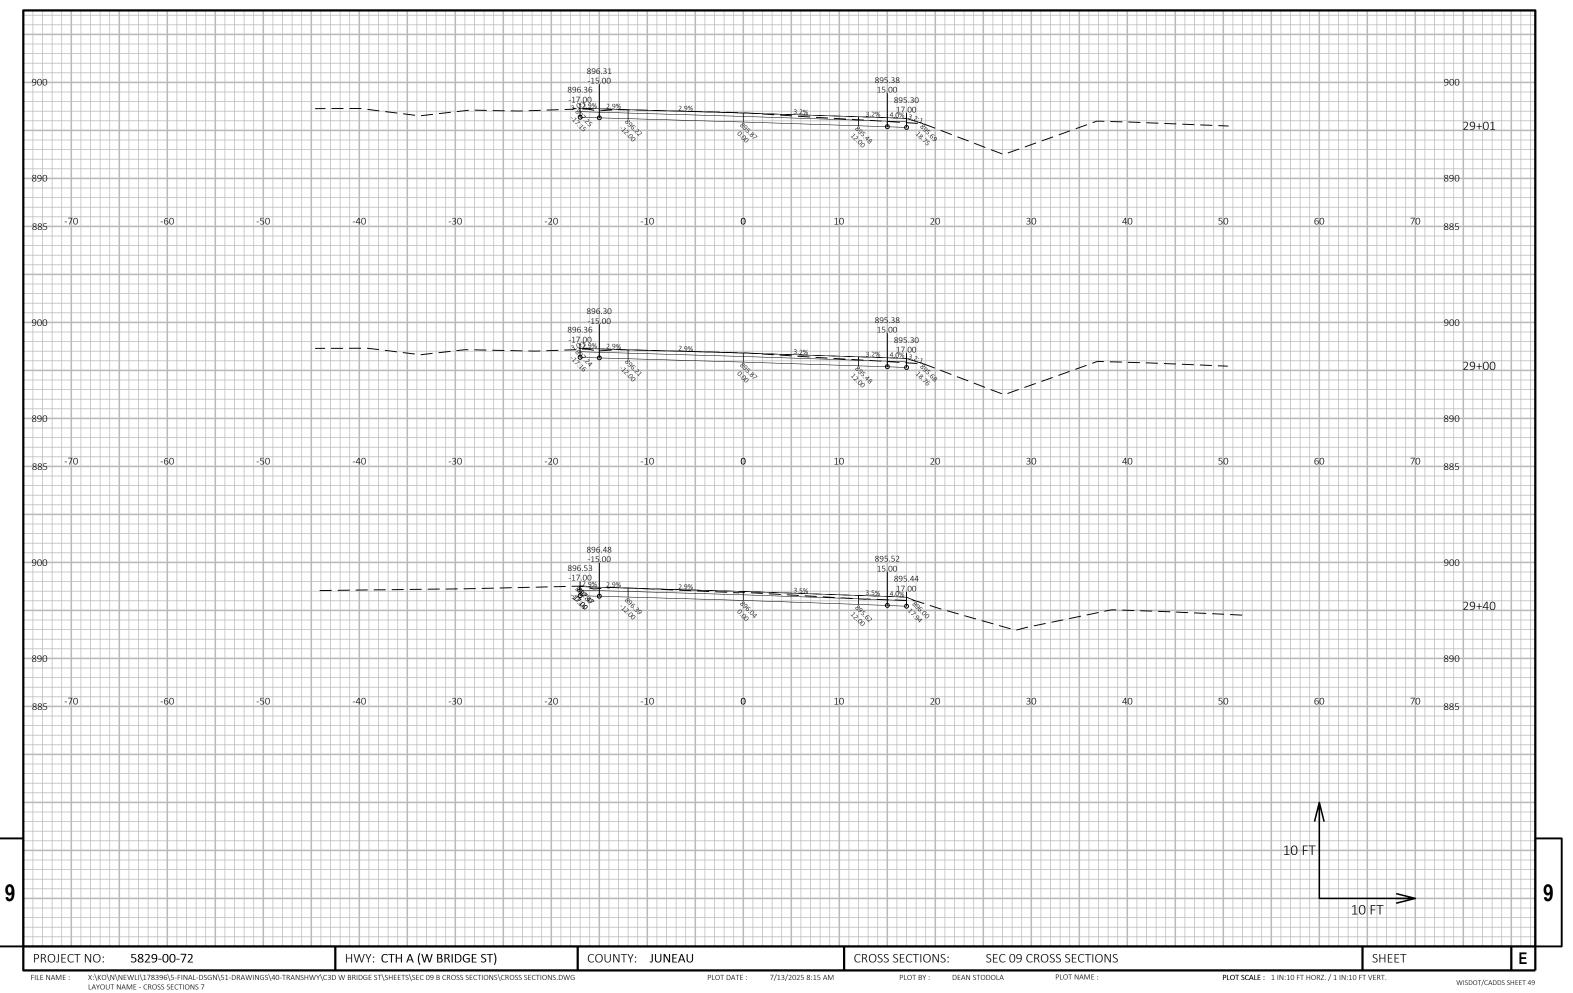

Notes



## Wisconsin Department of Transportation

Dedicated people creating transportation solutions through innovation and exceptional service.

http://www.dot.wisconsin.gov