WKE

Section No.

Section No.

Section No.

Section No.

TOTAL SHEETS = 112

DESIGN DESIGNATION

CONVENTIONAL SYMBOLS

2026 = 8.700

= 1,253

= 59/41

= 5.9%

= 40 MPH = 900,000

AADT

A.A.D.T.

DESIGN SPEED

CORPORATE LIMITS

LIMITED HIGHWAY EASEMENT

PROPOSED OR NEW R/W LINE

EXISTING RIGHT OF WAY

PROPERTY LINE

SLOPE INTERCEPT

REFERENCE LINE

EXISTING CULVERT

PROPOSED CULVERT

COMBUSTIBLE FLUIDS

WOODED OR SHRUB AREA

MARSH AREA

LOTLINE

D.H.V.

D.D.

Estimate of Quantities

Plan and Profile

Miscellaneous Quantities

Standard Detail Drawings

290-00-73

RACINE

JUNE 2025 **STATE OF WISCONSIN** ORDER OF SHEETS **DEPARTMENT OF TRANSPORTATION** Section No. Typical Sections and Details (Includes Erosion Control Plans)


PLAN OF PROPOSED IMPROVEMENT

FEDERAL PROJECT STATE PROJECT CONTRACT 2290-00-73

CITY RACINE, NORTHWESTERN AVENUE

GOLF AVENUE TO RAPIDS DRIVE

STH 038 RACINE COUNTY

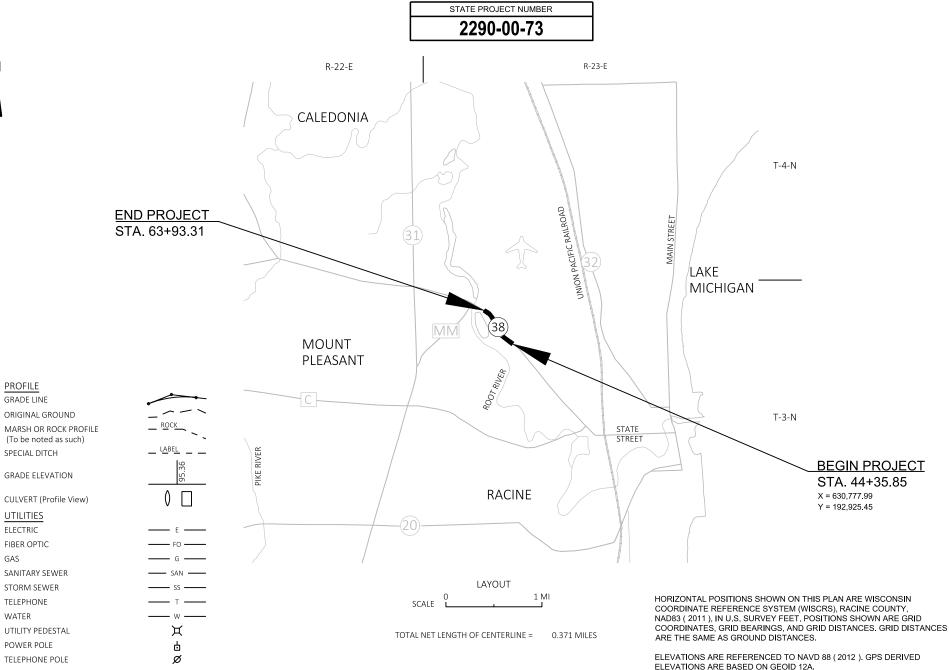



DEPARTMENT OF TRANSPORTATION

PREPARED BY	
Surveyor	STRAND ASSOCIATES, INC.
Designer	STRAND ASSOCIATES, INC.
Project Manager	MALATHI KARRI
Regional Examiner	WISDOT SE REGION
Regional Supervisor	JANET CANNON, P.E.
Negional supervisor	

PPROVED FOR THE DEPARTMENT

FILE NAME : S:\MIL\2000--2099\2089\019\DRAWINGS\CAD\AUTOCAD\22900303\SHEETSPLAN\010101-TI.DWG

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OVERSTREET, JOELY

GENERAL NOTES

DISTURBED AREAS WITHIN THE RIGHT OF WAY ARE TO BE TOPSOILED (SALVAGED), SODDED, AND FERTILIZED AS DIRECTED BY THE ENGINEER.

COMPLETE FINAL RESTORATION OF DISTURBED AREAS WITHIN 14 DAYS OF DISTURBANCE OR TEMPORARY SEED AND MULCH WITHIN 5 DAYS OF DISTURBANCE.

WHEN THE QUANTITY OF BASE AGGREGATE DENSE IS MEASURED FOR PAYMENT IN TONS, THE DEPTH OR THICKNESS AS SHOWN ON THE PLAN IS APPROXIMATE AND THE ACTUAL THICKNESS WILL DEPEND UPON THE DISTRIBUTION OF THE MATERIAL AS DIRECTED BY THE ENGINEER IN THE FIELD.

THE LOCATIONS OF EXISTING AND PROPOSED UTILITY INSTALLATIONS AS SHOWN ON THE PLANS ARE APPROXIMATE. THERE MAY BE OTHER UTILITY INSTALLATIONS WITHIN THE PROJECT AREA THAT ARE NOT SHOWN. COORDINATE CONSTRUCTION ACTIVITIES WITH A CALL TO DIGGERS HOTLINE AND/OR A DIRECT CALL TO THE UTILITIES THAT HAVE FACILITIES IN THE AREA.

ALL EXISTING SIGNS SHALL REMAIN IN PLACE UNTIL CONSTRUCTION OPERATIONS REQUIRE THEIR REMOVAL OR UNLESS THE ENGINEER APPROVES THEIR REMOVAL.

DO NOT REMOVE ANY TREES OR SHRUBS WITHOUT APPROVAL OF THE ENGINEER.

ALL SIGN LOCATIONS SHALL BE REVIEWED BY THE ENGINEER PRIOR TO INSTALLATION.

ELEVATIONS SHOWN ON THE PLANS ARE ALONG THE EDGE OF LANE AND EDGE OF PAVEMENT UNLESS OTHERWISE NOTED.

THE CONTRACTOR'S PAVING OPERATIONS SHALL BE CONSISTENT WITH THE PLAN TYPICAL SECTIONS AND CONSTRUCTED TO PREVENT HMA LONGITUDINAL JOINTS FROM BEING LOCATED WITHIN A DRIVING, TURNING, PASSING, OR PARKING LANE.

* AT&T WISCONSIN - COMMUNICATION LINE MICHAEL VANBOVEN
411 7TH STREET
RACINE, WI 53403
(262) 676-3958
MV3658@ATT.COM

CITY OF RACINE - SEWER
RICHARD FRAZIER
730 WASHINGTON AVENUE, ROOM 304
RACINE, WI 53403
(262) 636-9483
(414) 628-6974 (MOBILE)
RICHARD.FRAZIER@CITYOFRACINE.ORG

MIDWEST FIBER NETWORKS LLC - COMMUNICATION LINE CORY SCHMUK!
6070 NORTH FLINT ROAD
GLENDALE, WI 53209
(414) 459-3561
(414) 349-2764 (MOBILE)
CSCHMUKI@MIDWESTFIBERNETWORKS.COM

UTILITY CONTACTS

* PAETEC COMMNICATIONS LLC - COMMUNICATION LINE LORI KETTER 969 WAUBE LANE GREEN BAY, WI 54304 (920) 410-6902 LORI.KETTER@WINDSTREAM.COM

* RACINE WATER WORKS COMMISSION - WATER CHAD REGALIA 100 HUBBARD STREET RACINE, WI 53402 (262) 497-4611 CHAD.REGALIA@CITYOFRACINE.ORG

* SPECTRUM - COMMUNICATION LINE
JAY CHAPMAN
1320 NORTH DR. MARTIN LUTHER KING JR. DRIVE
MILWAUKEE, WI 53212
(414) 639-5296
JAY.CHAPMAN@CHARTER.COM

* WE ENERGIES - ELECTRICITY
JASON CHAPIN
7815 NORTHWESTERN AVENUE
RACINE, WI 53406
(262) 884-6706
(414) 587-0655 (MOBILE)
JASON.CHAPIN@WE-ENERGIES.COM

* WE ENERGIES - GAS/PETROLEUM
CHRIS DEGRAVE
7815 NORTHWESTERN AVENUE
RACINE, WI 53406
(262) 886-7018
(262) 939-9814 (MOBILE)
CHRIS.DEGRAVE@WE-ENERGIES.COM

* WINDSTREAM KDL, LLC - COMMUNICATION LINE LORI KETTER 969 WAUBE LANE GREEN BAY, WI 54304 (920) 410-6902 LORI.KETTER@WINDSTREAM.COM

SECTION 2 ORDER OF SHEETS

GENERAL NOTES
PROJECT OVERVIEW
TYPICAL SECTIONS
CONSTRUCTION DETAILS
INTERSECTION DETAILS
CURB RAMP DETAILS
EROSION CONTROL
PERMANENT SIGNING
PAVEMENT MARKING
TRAFFIC CONTROL
ALIGNMENT DETAIL
SURVEY CONTROL

* CITY OF RACINE - ROAD FACILITY
ARA MOLITOR
730 WASHINGTON AVENUE, ROOM 304
RACINE, WI 53403
(262) 636-9487
(262) 770-7242 (MOBILE)
ARA.MOLITOR@CITYOFRACINE.ORG

CITY OF RACINE - STREET LIGHTING ARA MOLITOR 730 WASHINGTON AVENUE, ROOM 304 RACINE, WI 53403 (262) 636-9487 (262) 770-7242 (MOBILE) ARA.MOLITOR@CITYOFRACINE.ORG

OTHER CONTACTS

* WISDOT - STREET LIGHTING ERIC PEREA 141 NW BARSTOW STREET WAUKESHA, WI 53187 (262) 574-5422 (414) 750-0935 (MOBILE) ERIC.PEREA@DOT.WI.GOV

WISDOT - WISCONSIN SIGNAL JARRETT GATES 141 NW BARSTOW STREET WAUKESHA, WI 53187 (262) 548-5894 JARRETT.GATES@DOT.WI.GOV



★ DENOTES DIGGERS HOTLINE MEMBERS

HMA PAVEMENT SUMMARY TABLE

4" HMA PAVEMENT (MAINLINE MILL AND OVERLAY)							
LAYER	THICKNESS	НМА ТҮРЕ					
UPPER LAYER	1 3/4"	4 LT 58-28 S					
LOWER LAYER	2 1/4"	3 LT 58-28 S					

DNR LIAISON

BENTON STELZEL DNR SERVICE CENTER 141 NW BARSTOW STREET ROOM 180 WAUKESHA, WI 53188 (262) 623-0194 BENTON.STELZEL@WISCONSIN.GOV CITY OF RACINE CONTACT

ARA MOLITOR, P.E. CITY OF RACINE DPW 730 WASHINGTON AVENUE RACINE, WI 53403 (262) 636-9487 ARA.MOLITOR@CITYOFRACINE.ORG WISDOT REGION CONTACT

MALATHI KARRI WISDOT SOUTHEAST REGION WAUKESHA OFFICE 141 NW BARSTOW STREET WAUKESHA, WI 53187 (262) 548-5847 MALATHI.KARRI@DOT.WI.GOV DESIGN CONSULTANT


BHUPENDRA BISTA, P.E.
STRAND ASSOCIATES, INC.
126 N. JEFFERSON STREET, SUITE 350
MILWAUKEE, WI 53202
(414) 271-0771
BHUPENDRA.BISTA@STRAND.COM

PROJECT NO: 2290-00-73 HWY: STH 38 COUNTY: RACINE GENERAL NOTES SHEET **E**

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S:\MIL\2000--2099\2089\019\DRAWINGS\CAD\AUTOCAD\22900303\SHEETSPLAN\020101-GN.DWG LAYOUT NAME - 020101-gn

PLOT BY: OVERSTREET, JOELY PLOT NAME: PLOT SCALE: ########## WISDOT/CADDS SHEET 42

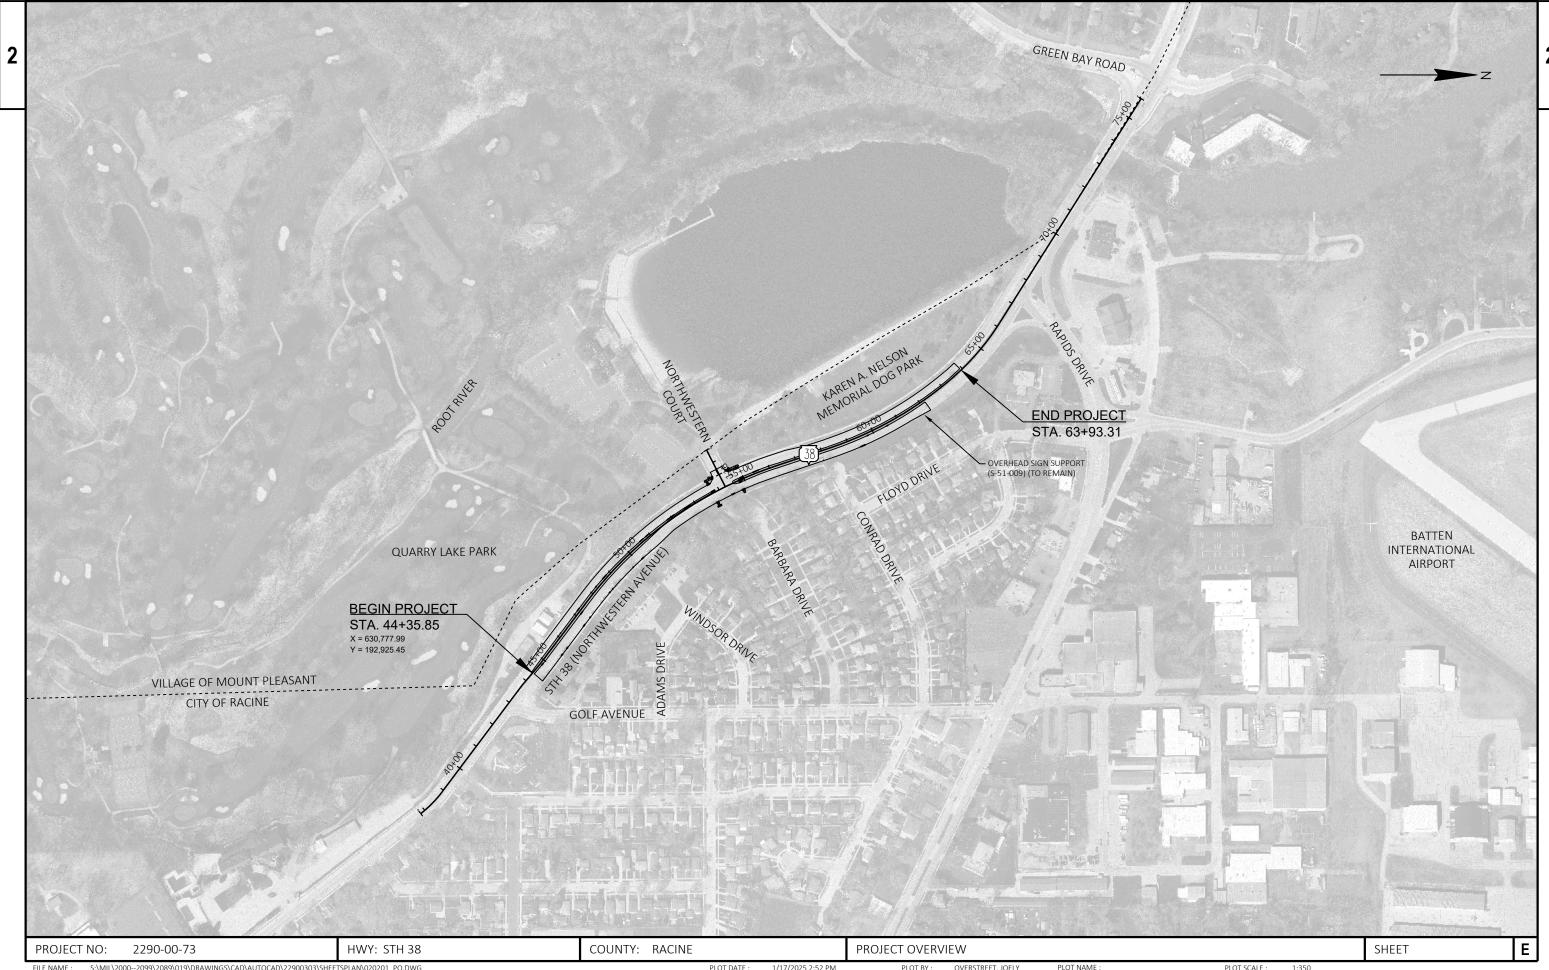

 LATERAL CLEARANCE ② STA. 44+36 TO STA. 50+98 = 12' STA. 50+98 TO STA. 51+80 = VARIES 12' TO 4' STA. 51+80 TO STA. 61+42 = 4' STA. 61+42 TO STA. 62+18 = 4' TO 12' ③ STA. 53+75 TO STA. 56+75 = 12' STA. 56+75 TO STA. 57+51 = VARIES 12' TO 4' R/W R/L R/W VARIES 60'-75' VARIES 60'-75' VARIES 5'-6' 5.5'-12.5' 12' BIKE 1 -2% TO 5% -2% TO 5% 6:1 2 % -2% TO 5% -2% TO <u>5</u>% - EXISTING CONCRETE CURB & GUTTER 18-INCH (TYP.) EXISTING 4-INCHES VARIES HMA PAVEMENT (TYP.) -23.5'-38.5' EXISTING CONCRETE SIDEWALK (TYP.) -EXISTING 7-INCHES RUBBLIZED CONCRETE PAVEMENT (TYP.) EXISTING CONCRETE CURB & 1 GUTTER 30-INCH (TYP.) -EXISTING 6-INCHES CRUSHED AGGREGATE BASE COURSE (TYP.) -VARIES VARIES 5'-16' 0'-11' R/W VARIES 47'-58' EXISTING CONCRETE CURB & GUTTER 30-INCH VARIES VARIES EXISTING 6-INCHES CRUSHED AGGREGATE BASE COURSE 4'-12' -2% TO 4% STA. 57+93 TO STA. 62+18 3 6:1 EXISTING CONCRETE CURB & GUTTER 18-INCH (TYP.) --2% TO <u>5</u>% R/W VARIES 40'-55' STA. 50+40 TO STA. 54+56 EXISTING 4-INCHES HMA PAVEMENT - EXISTING 7-INCHES RUBBLIZED CONCRETE PAVEMENT VARIES EXISTING 4-INCHES HMA PAVEMENT 4'-12' ► EXISTING 6-INCHES CRUSHED AGGREGATE EXISTING CONCRETE EXISTING 7-INCHES RUBBLIZED CONCRETE PAVEMENT BASE COURSE (TYP.) BIKE & PARKING 2 - EXISTING 6-INCHES CRUSHED AGGREGATE BASE COURSE EXISTING CONCRETE CURB STA. 53+75 TO STA. 57+51 & GUTTER 30-INCH --2<u>%</u> TO 5% R/W VARIES VARIES 5'-6' 0-5.5' 15' 12' - EXISTING CONCRETE SIDEWALK LANE & BIKE SHOULDER/LEFT TURN ACCOMMODATION LANE EXISTING CONCRETE EXISTING 4-INCHES HMA PAVEMENT -CURB & GUTTER 30-INCH EXISTING 7-INCHES RUBBLIZED CONCRETE PAVEMENT — -2% TO 4% -2% TO 4% EXISTING 6-INCHES CRUSHED AGGREGATE BASE COURSE -STA. 44+36 TO STA. 51+80 STA. 61+42 TO STA. 62+18 EXISTING CONCRETE SIDEWALK -- EXISTING CONCRETE CURB & GUTTER 18-INCH EXISTING CONCRETE CURB & GUTTER 30-INCH -EXISTING 4-INCHES HMA PAVEMENT -EXISTING 7-INCHES RUBBLIZED CONCRETE PAVEMENT EXISTING 6-INCHES CRUSHED AGGREGATE BASE COURSE -STA. 44+36 TO STA. 49+13 **EXISTING TYPICAL SECTION - STH 38** STA. 44+36 TO STA. 63+93

COUNTY: RACINE

PLOT DATE :

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HWY: STH 38

2290-00-73

PROJECT NO:

PLOT NAME

TYPICAL SECTIONS

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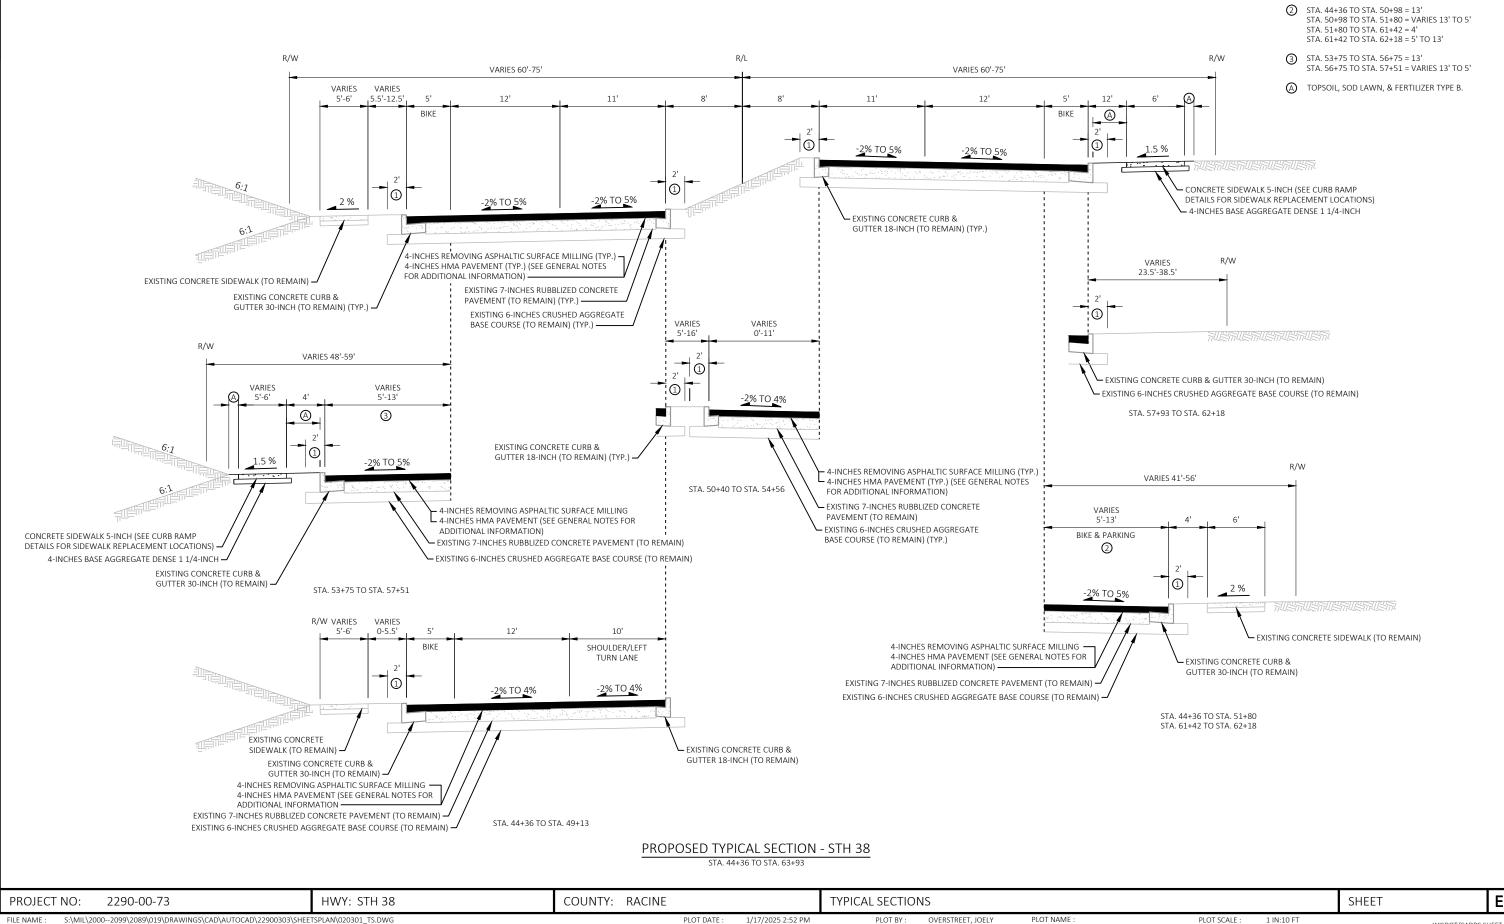
SHEET

PLOT SCALE :

1 IN:10 FT



1 LATERAL CLEARANCE



NOT TO SCALE

DRILLED TIE BARS (TIED INTO EXISTING CONCRETE CURB & GUTTER) (NO. 4 X 2' 0" TIE BARS; EMBEDMENT DEPTH = D/2; PLACED L/3 FROM THE BACK OF CURB AND FLANGE LINE) -

> CONCRETE CURB & GUTTER 30-INCH TYPE D (SEE INTERSECTION DETAIL FOR CURB AND

GUTTER TYPE AND LOCATION) -

- SAWING CONCRETE REQ'D (AFTER REMOVING ASPHALTIC SURFACE MILLING) 4" DEPTH (TYP.) 4-INCHES REMOVING ASPHALTIC SURFACE MILLING (TYP.) 6-INCHES BASE AGGREGATE DENSE 1 1/4-INCH -4-INCHES HMA PAVEMENT (TYP.) CONCRETE CURB & GUTTER 18-INCH TYPE D OR - EXISTING 7-INCHES RUBBLIZED CONCRETE PAVEMENT (TO REMAIN)

> CONCRETE CURB & GUTTER REPLACEMENT AT CURB RAMP OPENINGS

MATCH ADJACENT PAVEMENT SLOPE

② GRADE CHANGE BETWEEN OVERLAYED GUTTER FLAG SLOPE AND THE CURB RAMP SLOPE SHALL NOT EXCEED 11%. MAXIMUM OVERLAYED GUTTER FLAG SLOPE IS 4%. PROVIDE LONGITUDINAL DRAINAGE AROUND CURB AND AWAY FROM CURB RAMP. NO VERTICAL LIPS OR DISCONTINUITIES GREATER THAN 1/4-INCH ARE ALLOWED. SLOPE OF CURB HEAD OPENING SHALL MATCH THE RAMP SLOPE, MINIMALLY 1.5% AND NOT TO EXCEED 7%. WHEN ADJACENT TO 1.5% LANDING, CONSTRUCT CURB HEAD OPENING AT 1.5% IN THE DIRECTION OF PEDESTRIAN TRAVEL.

(1) MATCH ADJACENT PAVEMENT SLOPE

NOT TO SCALE

DRILLED TIE BARS (TIED INTO EXISTING CONCRETE CURB & GUTTER) (NO. 4 X 2' 0" TIE BARS; EMBEDMENT DEPTH = D/2; PLACED L/3 FROM THE BACK OF CURB AND FLANGE LINE) 3" DEPTH (TYP.) - SAWING CONCRETE REQ'D (AFTER REMOVING ASPHALTIC SURFACE MILLING) XXXXXXXX6-INCHES BASE AGGREGATE DENSE 1 1/4-INCH -CONCRETE CURB & GUTTER 18-INCH TYPE D OR CONCRETE CURB & GUTTER 30-INCH TYPE D - 4-INCHES REMOVING ASPHALTIC SURFACE MILLING (TYP.) (MATCH EXISTING CURB HEAD HEIGHT) 4-INCHES HMA PAVEMENT (TYP.) (SEE PLAN FOR CURB AND GUTTER TYPE AND LOCATION) -EXISTING 7-INCHES RUBBLIZED CONCRETE PAVEMENT (TO REMAIN)

CONCRETE CURB & GUTTER REPLACEMENT

PROJECT NO: 2290-00-73 HWY: STH 38 COUNTY: RACINE

CONSTRUCTION DETAILS

1 IN:10 FT

SHEET

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PLOT BY:

OVERSTREET, JOELY

LEXISTING 6-INCHES CRUSHED AGGREGATE BASE COURSE (TO REMAIN)

LEXISTING 6-INCHES CRUSHED AGGREGATE BASE COURSE (TO REMAIN)

PLOT NAME :

PLOT SCALE :

WISDOT/CADDS SHEET 42

NOT TO SCALE


RUNOFF COEFFICIENT TABLE

		HYDROLOGIC SOIL GROUP										
			А		В	3	С				D	
	SLOPE	RANGE	(PERCENT)	SLOI	PE RANG	GE (PERCENT)	SLOF	SLOPE RANGE (PERCENT)		SLOPE RANGE (PERCENT)		E (PERCENT)
LAND USE:	0-2	2-6	6 & OVER	0-2	2-6	6 & OVER	0-2	2-6	6 & OVER	0-2	2-6	6 & OVER
ROW CROPS	.08 .22	.16 .30	.22 .38	.12 .26	.20 .34	.27 .44	.15 .30	.24 .37	.33 .50	.19 .34	.28 .41	.38 .56
MEDIAN STRIP - TURF	.19 .24	.20 .26	.24 .30	.19 .25	.22 .28	.26 .33	.20 .26	.23 .30	.30 .37	.20 .27	.25 .32	.30 .40
SIDE SLOPE- TURF			.25 .32			.27 .34			.28 .36			.30 .38
PAVEMENT:												
ASPHALT						.7095						
CONCRETE						.8095						
BRICK						.7080						
DRIVES, WALKS						.7585						
ROOFS						.7595						
GRAVEL ROADS, SH	HOULDER	RS				.4060	·					

TOTAL PROJECT AREA = 4.36 ACRES TOTAL AREA EXPECTED TO BE DISTURBED BY CONSTRUCTION ACTIVITIES = 0.08 ACRES

COUNTY: RACINE

NOT TO SCALE

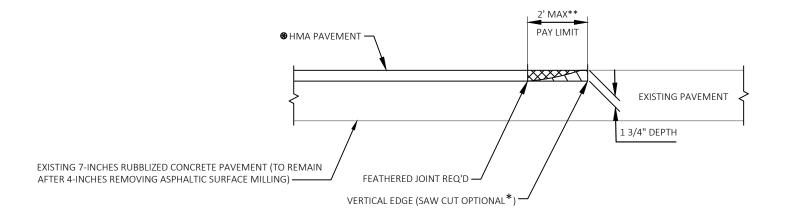

- REMOVE ASPHALTIC SURFACE WEDGE PRIOR TO PAVING UPPER PAVEMENT LAYER TO CREATE A VERTICAL FACE AT BUTT JOINT. CREATE BY SAWING, MILLING, OR OTHER ENGINEER-APPROVED METHODS. PAID FOR UNDER REMOVING ASPHALTIC SURFACE BUTT JOINTS.

NOT PAID FOR SEPARATELY

TRANSITION PAVEMENT CROSS SLOPE TO MATCH EXISTING CROSS SLOPE.

SEE HMA PAVEMENT SUMMARY TABLE ON GENERAL NOTES PLAN SHEET FOR PAVEMENT TYPE AND LAYER THICKNESS.

REMOVING ASPHALTIC SURFACE BUTT JOINTS

HMA PAVEMENT 3 MT 58-28 S (ASPHALTIC WEDGE)

REMOVING ASPHALTIC SURFACE BUTT JOINTS DETAIL (NO PROFILE CHANGE)

STA. 44+36 STA. 10+78 B STA. 62+18 NB STA. 63+93 SB

PROJECT NO: 2290-00-73 HWY: STH 38 S:\MIL\2000--2099\2089\019\DRAWINGS\CAD\AUTOCAD\22900303\SHEETSPLAN\021001-CD.DWG

CONSTRUCTION DETAILS

PLOT NAME :

SHEET PLOT SCALE : 1 IN:10 FT

LAYOUT NAME - 021002-cd

PLOT DATE : 1/31/2025 10:49 AM PLOT BY: WRIGHT, BRANDON

WISDOT/CADDS SHEET 42

NOT TO SCALE

REMOVING CURB AND GUTTER AND PAVEMENT TO THE LIMITS SHOWN, EXCAVATING, PREPARING THE FOUNDATION AND SHIMMING ARE INCIDENTAL TO THE ADJUSTING OR RECONSTRUCTING BID ITEMS.

THE DEPARTMENT WILL PAY SEPARATELY FOR SAWING CONCRETE, CONCRETE CURB & GUTTER AND

MONOLITHIC SHIM CONCRETE, CONCRETE PLACEMENT AND FINISHING IS INCIDENTAL TO THE CONCRETE CURB & GUTTER BID ITEM.


PREVENT CONCRETE AND OTHER DEBRIS FROM FALLING INTO STRUCTURE.


REFER TO MISCELLANEOUS QUANTITIES FOR ADDITIONAL INFORMATION.

SAWING CONCRETE

REMOVING CURB & GUTTER AND EXCAVATION COMMON


MONOLITHIC CONCRETE

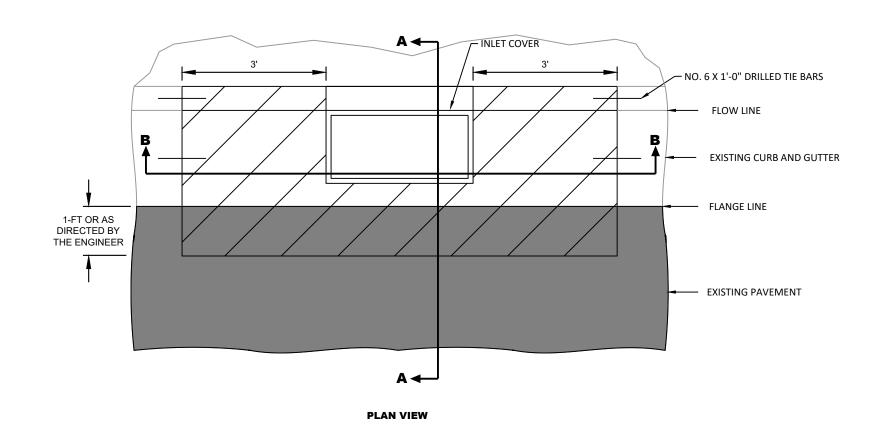


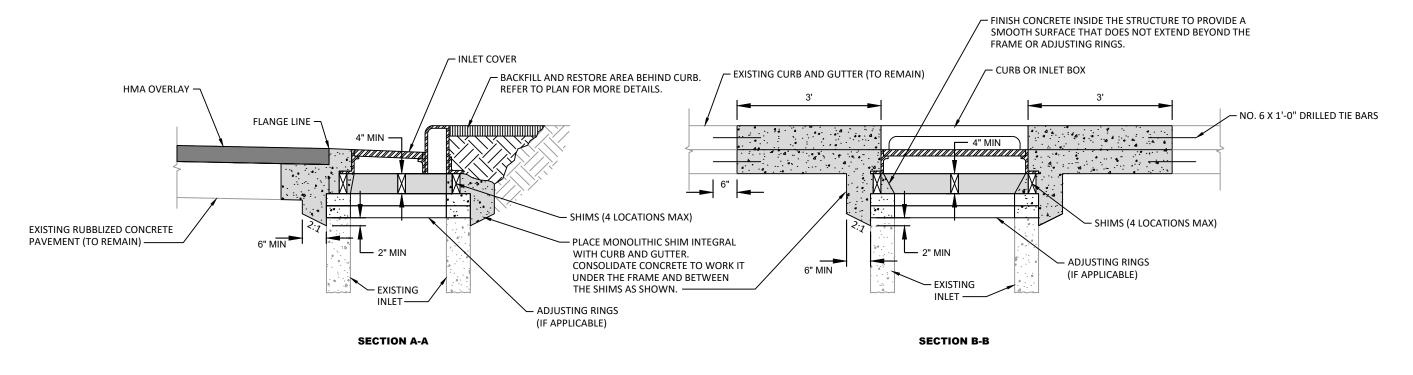

ADJUSTING / RECONSTRUCTING CATCH BASINS & INLETS - MONOLITHIC SHIM

PROJECT NO: 2290-00-73 HWY: STH 38 COUNTY: RACINE **CONSTRUCTION DETAILS** SHEET

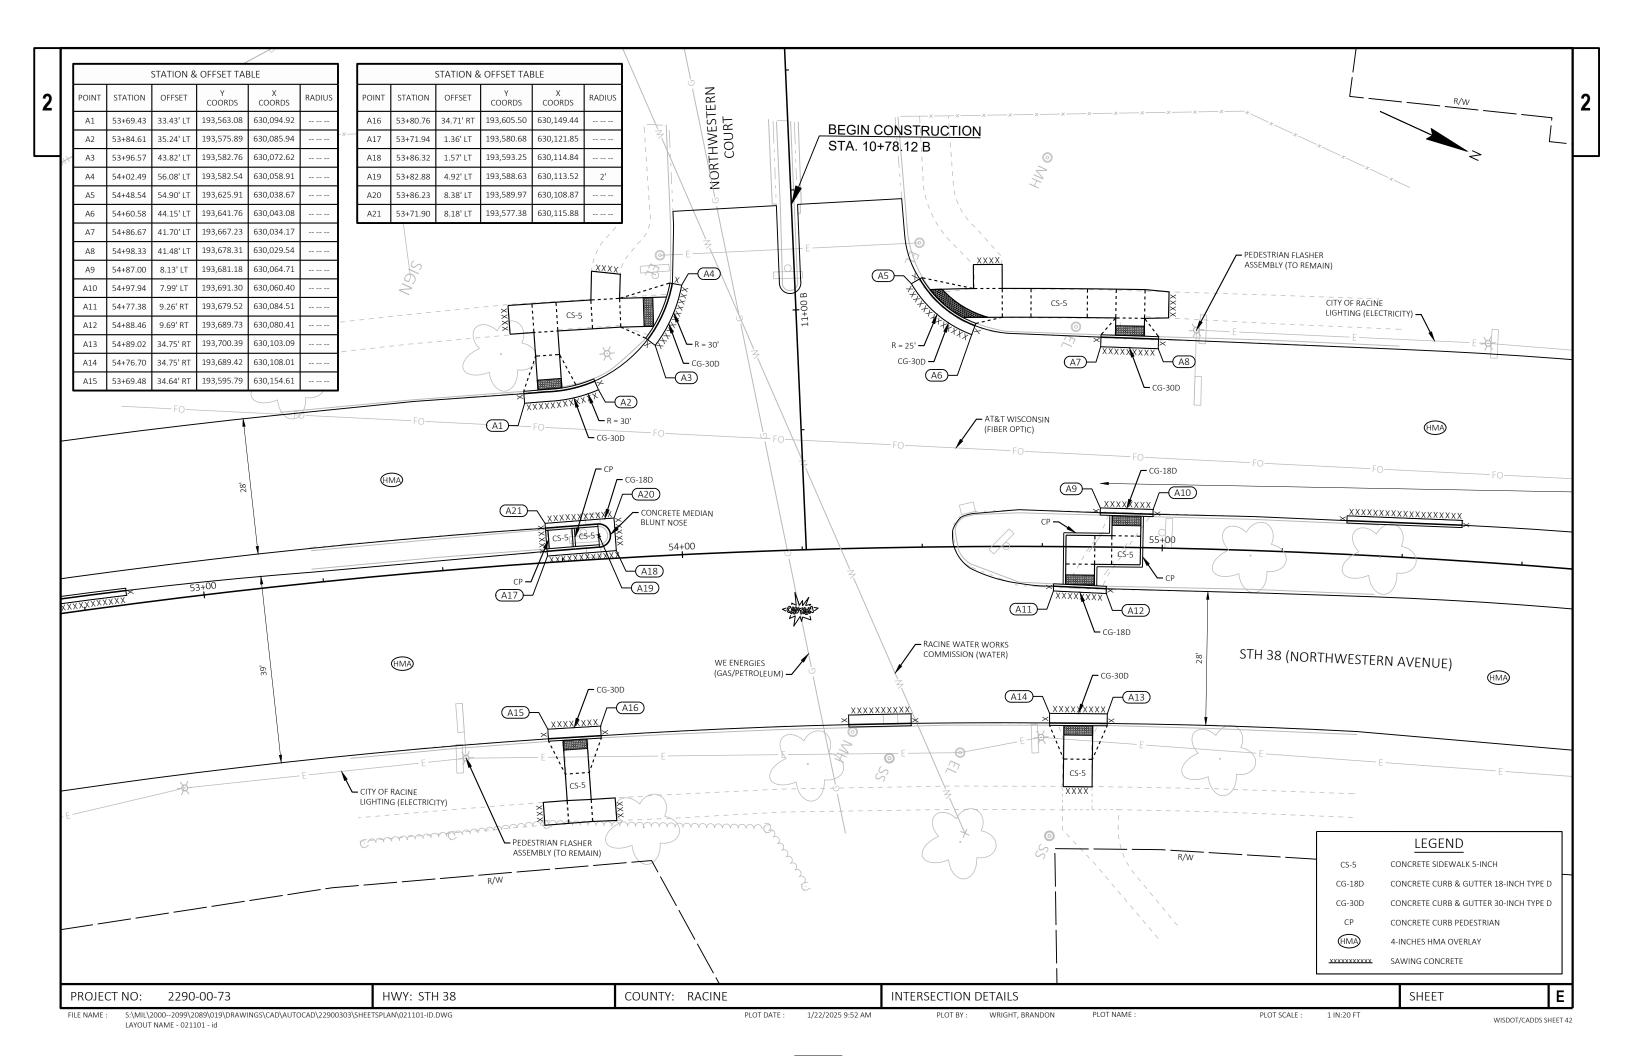

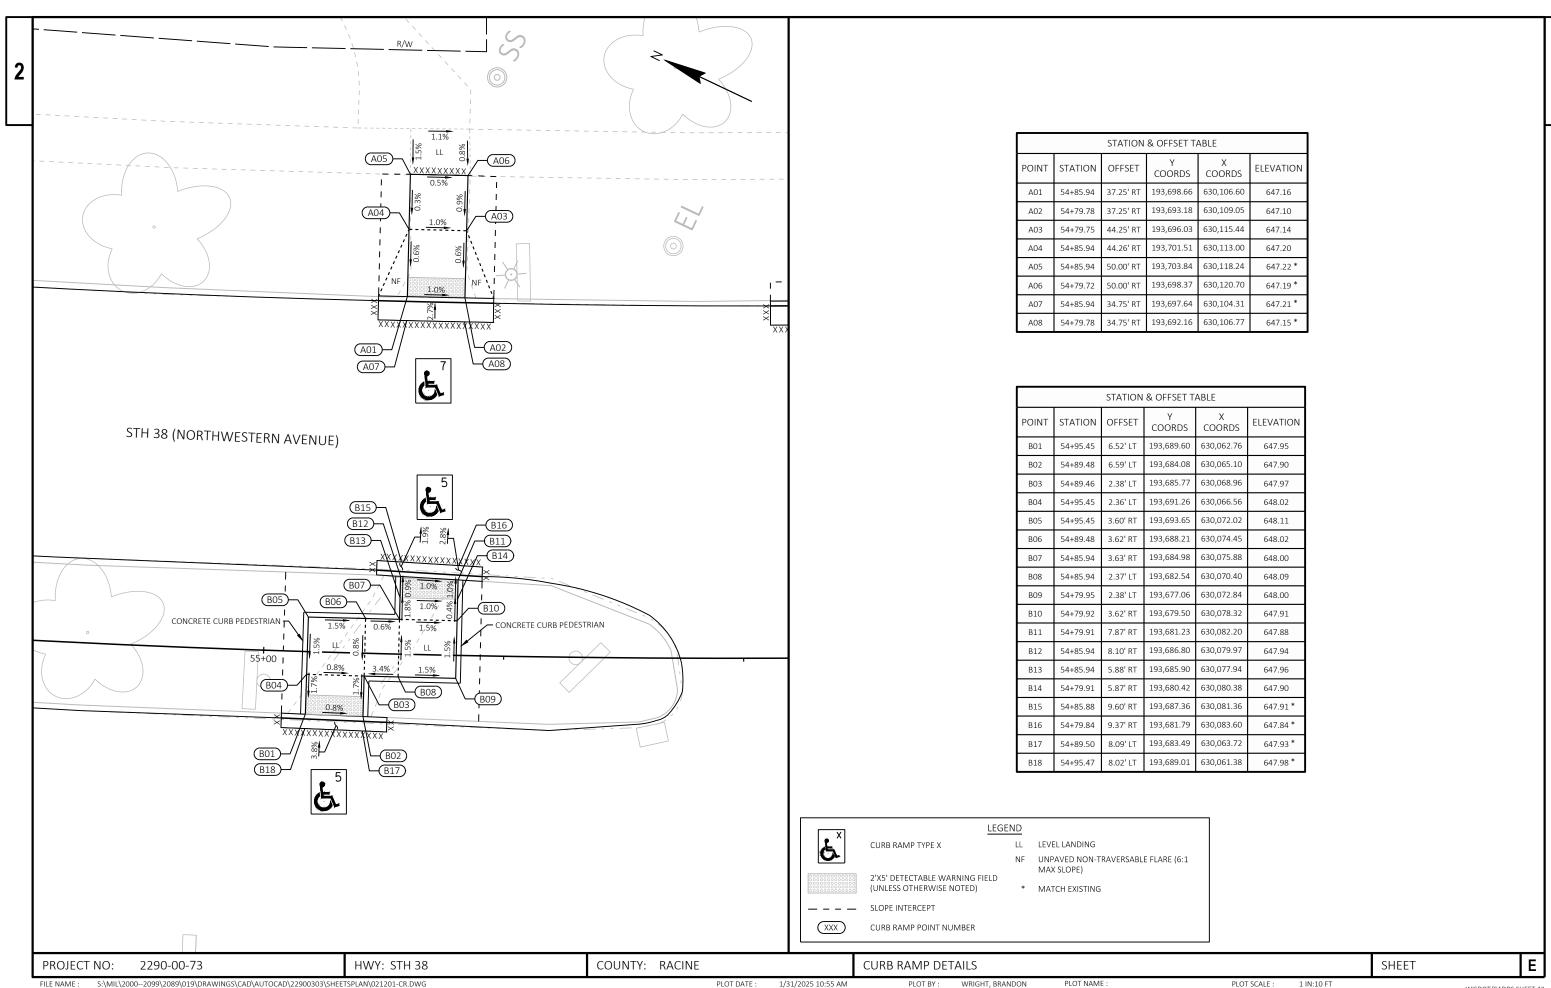


E NAME: S:\MIL\2000--2099\ZU89\\019\DKRAWINGS\CAD\AUTUCAD\Z2900303\SHEETSPLAN\\021201-CK.DWG PLOT DATE: 1/31/2025 10:55 AW PLOT BY: WRIGHT, BRANDON PLOT NAME: PLOT SCALE: 1 IN:10 FT WISDOT/CADDS SHEET 42

LAYOUT NAME - 021201-cr

EATOOT NAME - 021201-CI


	STATION & OFFSET TABLE								
POINT	STATION	OFFSET	Y COORDS	X COORDS	ELEVATION				
C01	54+58.81	47.74' LT	193,638.58	630,040.60	649.06				
C02	54+52.23	53.62' LT	193,629.91	630,038.19	648.81				
C03	54+61.01	53.75' LT	193,638.11	630,034.19	648.95				
C04	54+66.77	47.75' LT	193,646.04	630,037.12	649.14				
C05	54+66.77	53.75' LT	193,643.53	630,031.68	649.05				
C06	54+66.77	58.75' LT	193,641.44	630,027.14	648.91*				
C07	54+61.01	58.75' LT	193,635.99	630,029.66	648.86*				
C08	54+72.56	53.75' LT	193,648.98	630,029.17	649.14				
C09	54+72.56	47.75' LT	193,651.48	630,034.63	649.17				
C10	54+83.89	47.75' LT	193,662.15	630,029.81	649.30				
C11	54+83.89	53.75' LT	193,659.70	630,024.33	649.39				
C12	54+89.67	53.75' LT	193,665.18	630,021.89	649.30				
C13	54+89.65	47.75' LT	193,667.59	630,027.39	649.21				
C14	54+95.45	47.75' LT	193,673.08	630,024.98	649.30				
C15	54+95.45	53.75' LT	193,670.68	630,019.48	649.39				
C16	55+00.27	53.37' LT	193,675.41	630,017.83	649.35*				
C17	55+00.29	47.93' LT	193,677.59	630,022.81	649.37*				
C18	54+95.45	44.02' LT	193,674.57	630,028.39	649.20				
C19	54+89.63	44.13' LT	193,669.04	630,030.70	649.15				
C20	54+95.41	41.52' LT	193,675.54	630,030.70	649.13*				

	STATION & OFFSET TABLE									
POINT	STATION	OFFSET	Y COORDS	X COORDS	ELEVATION					
C21	54+89.58	41.64' LT	193,670.00	630,033.01	649.08*					
C22	54+57.59	45.58' LT	193,638.36	630,043.09	649.02*					
C23	54+50.31	52.11' LT	193,628.76	630,040.41	648.85 *					
C24	54+95.45	46.12' LT	193,673.73	630,026.47	649.24					
C25	54+89.64	46.13' LT	193,668.24	630,028.87	649.19					
C26	0+00.00	0.00'	193,643.36	630,038.36	649.11					
C27	0+00.00	0.00'	193,632.20	630,037.06	648.83					

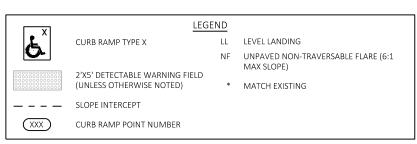

STATION & OFFSET TABLE								
POINT	STATION	OFFSET	Y COORDS	X COORDS	ELEVATION			
D01	53+99.33	53.76' LT	193,580.70	630,062.48	649.25			
D02	53+96.60	53.82' LT	193,578.15	630,063.73	649.29			
D03	53+96.46	47.83' LT	193,580.81	630,069.11	649.35			
D04	53+89.85	48.00' LT	193,574.67	630,072.14	649.41			
D05	53+89.93	54.00' LT	193,571.94	630,066.80	649.36			
D06	53+90.33	59.00' LT	193,569.98	630,062.18	649.43 *			
D07	53+84.62	59.99' LT	193,564.27	630,064.10	649.51 *			
D08	53+84.15	54.00' LT	193,566.64	630,069.61	649.45			
D09	53+84.15	48.00' LT	193,569.47	630,074.91	649.43			
D10	53+77.14	48.00' LT	193,563.09	630,078.33	649.65			
D11	53+77.14	54.00' LT	193,560.24	630,073.05	649.74			
D12	53+72.30	54.00' LT	193,555.82	630,075.45	649.81			
D13	53+72.30	48.00' LT	193,558.69	630,080.72	649.72			
D14	53+67.48	48.00' LT	193,554.32	630,083.10	649.89 *			
D15	53+67.48	54.00' LT	193,551.44	630,077.84	649.83 *			
D16	53+72.31	43.06' LT	193,561.06	630,085.05	649.65			
D17	53+77.17	43.08' LT	193,565.45	630,082.64	649.58			
D18	53+77.21	36.08' LT	193,568.81	630,088.78	649.28			
D19	53+72.33	35.97' LT	193,564.47	630,091.27	649.30			
D20	54+01.61	52.93' LT	193,583.18	630,062.13	649.25 *			

	STATION & OFFSET TABLE									
	POINT	STATION	OFFSET	Y COORDS	X COORDS	ELEVATION				
ĺ	D21	53+98.48	46.44' LT	193,583.29	630,069.38	649.34*				
	D22	53+77.42	33.59' LT	193,570.19	630,090.87	649.22*				
	D23	53+72.36	33.47' LT	193,565.70	630,093.45	649.24*				
	D24	53+77.20	38.08' LT	193,567.85	630,087.03	649.37				
	D25	53+72.33	38.06' LT	193,563.47	630,089.43	649.39				

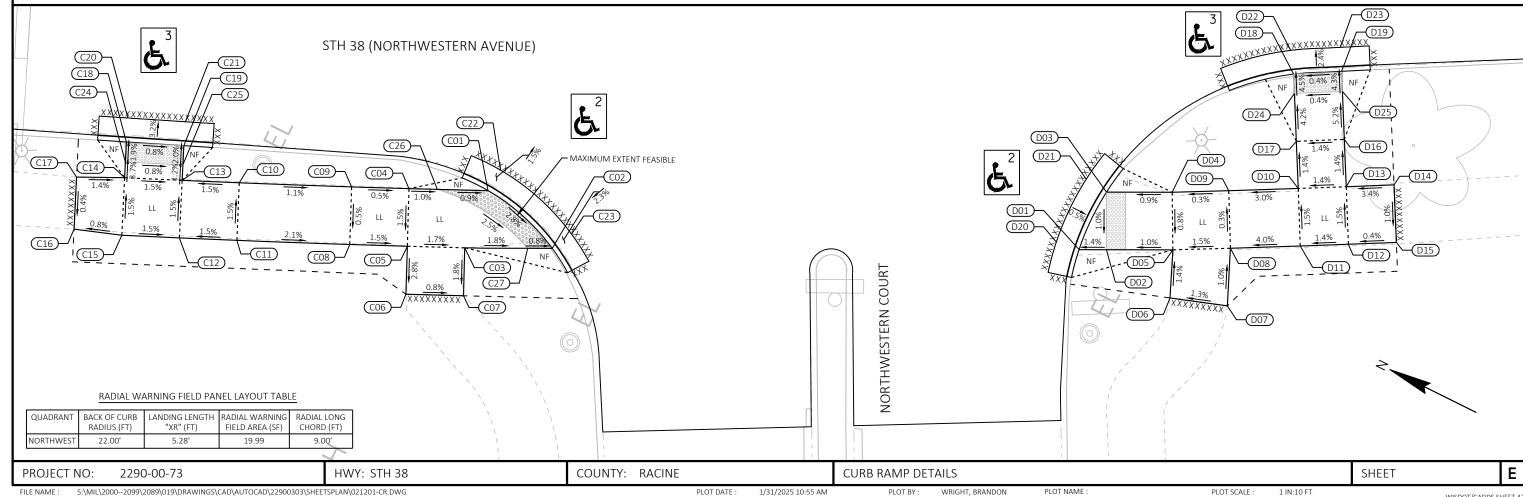

LAYOUT NAME - 021202-cr


WISDOT/CADDS SHEET 42

	STATION & OFFSET TABLE									
POINT	STATION	OFFSET	Y COORDS	X COORDS	ELEVATION					
F01	53+77.67	37.20' RT	193,604.03	630,153.05	647.33					
F02	53+72.54	37.17' RT	193,599.62	630,155.41	647.36					
F03	53+72.56	44.22' RT	193,603.01	630,161.59	647.39					
F04	53+77.72	44.20' RT	193,607.39	630,159.19	647.37					
F05	53+77.75	49.84' RT	193,610.10	630,164.14	647.40					
F06	53+72.57	49.74' RT	193,605.66	630,166.44	647.42					
F07	53+67.39	49.78' RT	193,601.29	630,168.87	647.31*					
F08	53+67.39	54.56' RT	193,603.59	630,173.06	647.43*					
F09	53+72.59	54.50' RT	193,607.94	630,170.61	647.46					
F10	53+77.79	54.44' RT	193,612.31	630,168.17	647.44					
F11	53+82.99	54.55' RT	193,616.77	630,165.91	647.29*					
F12	53+82.94	49.84' RT	193,614.51	630,161.78	647.16*					
F13	53+77.68	34.70' RT	193,602.85	630,150.85	647.40*					
F14	53+72.56	34.67' RT	193,598.44	630,153.20	647.43*					

STATION & OFFSET TABLE										
POINT	STATION	OFFSET	Y COORDS	X COORDS	ELEVATION					
E01	53+77.41	2.92' LT	193,584.75	630,117.86	648.05					
E02	53+72.42	2.86' LT	193,580.38	630,120.30	648.12					
E03	53+72.41	6.68' LT	193,578.55	630,116.95	648.32					
E04	53+77.39	6.74' LT	193,582.91	630,114.52	648.28					
E05	53+77.37	8.24' LT	193,582.18	630,113.21	648.32 *					
E06	53+72.40	8.18' LT	193,577.82	630,115.64	648.35 *					
E07	53+72.44	1.36' LT	193,581.11	630,121.61	648.12 *					
E08	53+77.43	1.42' LT	193,585.48	630,119.18	648.05 *					

(XXX)

HWY: STH 38

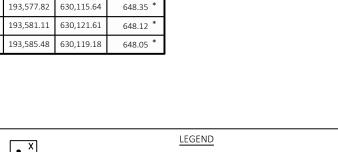

CURB RAMP POINT NUMBER


CURB RAMP TYPE X LL LEVEL LANDING NF UNPAVED NON-TRAVERSABLE FLARE (6:1 MAX SLOPE) 2'X5' DETECTABLE WARNING FIELD (UNLESS OTHERWISE NOTED) * MATCH EXISTING SLOPE INTERCEPT


COUNTY: RACINE


STH 38 (NORTHWESTERN AVENUE) CONCRETE CURB PEDESTRIAN -54+00 CONCRETE CURB PEDESTRIAN CURB RAMP DETAILS SHEET

2290-00-73


PROJECT NO:

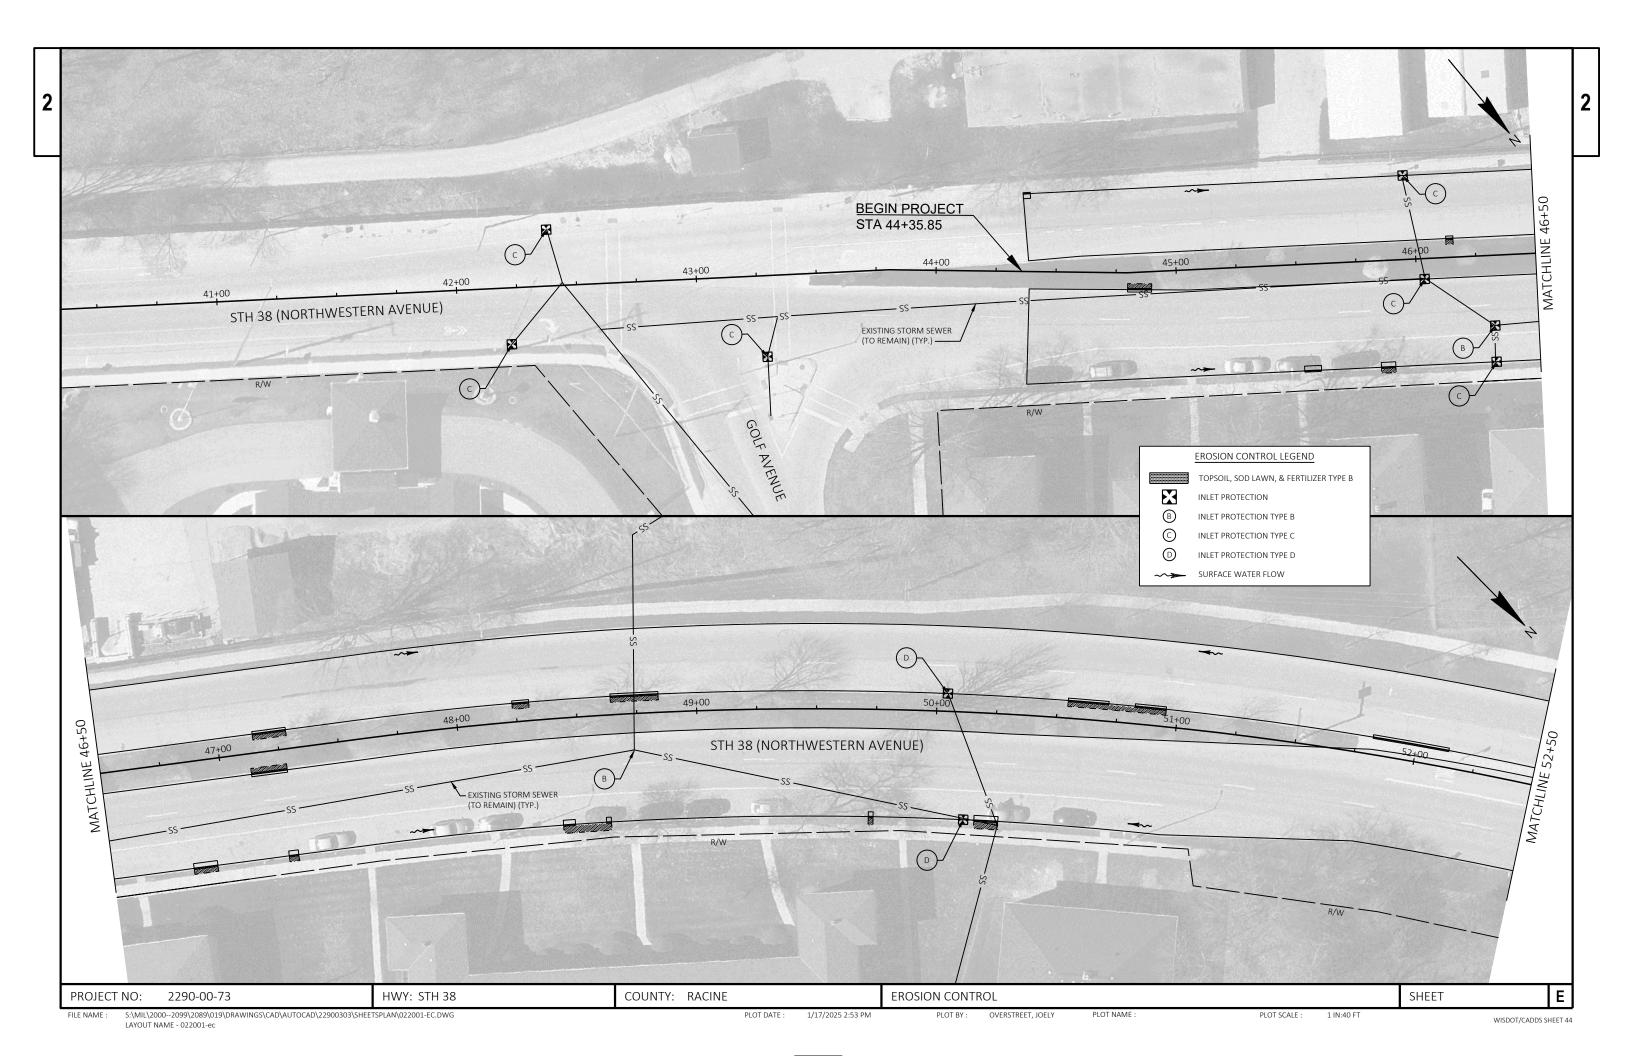

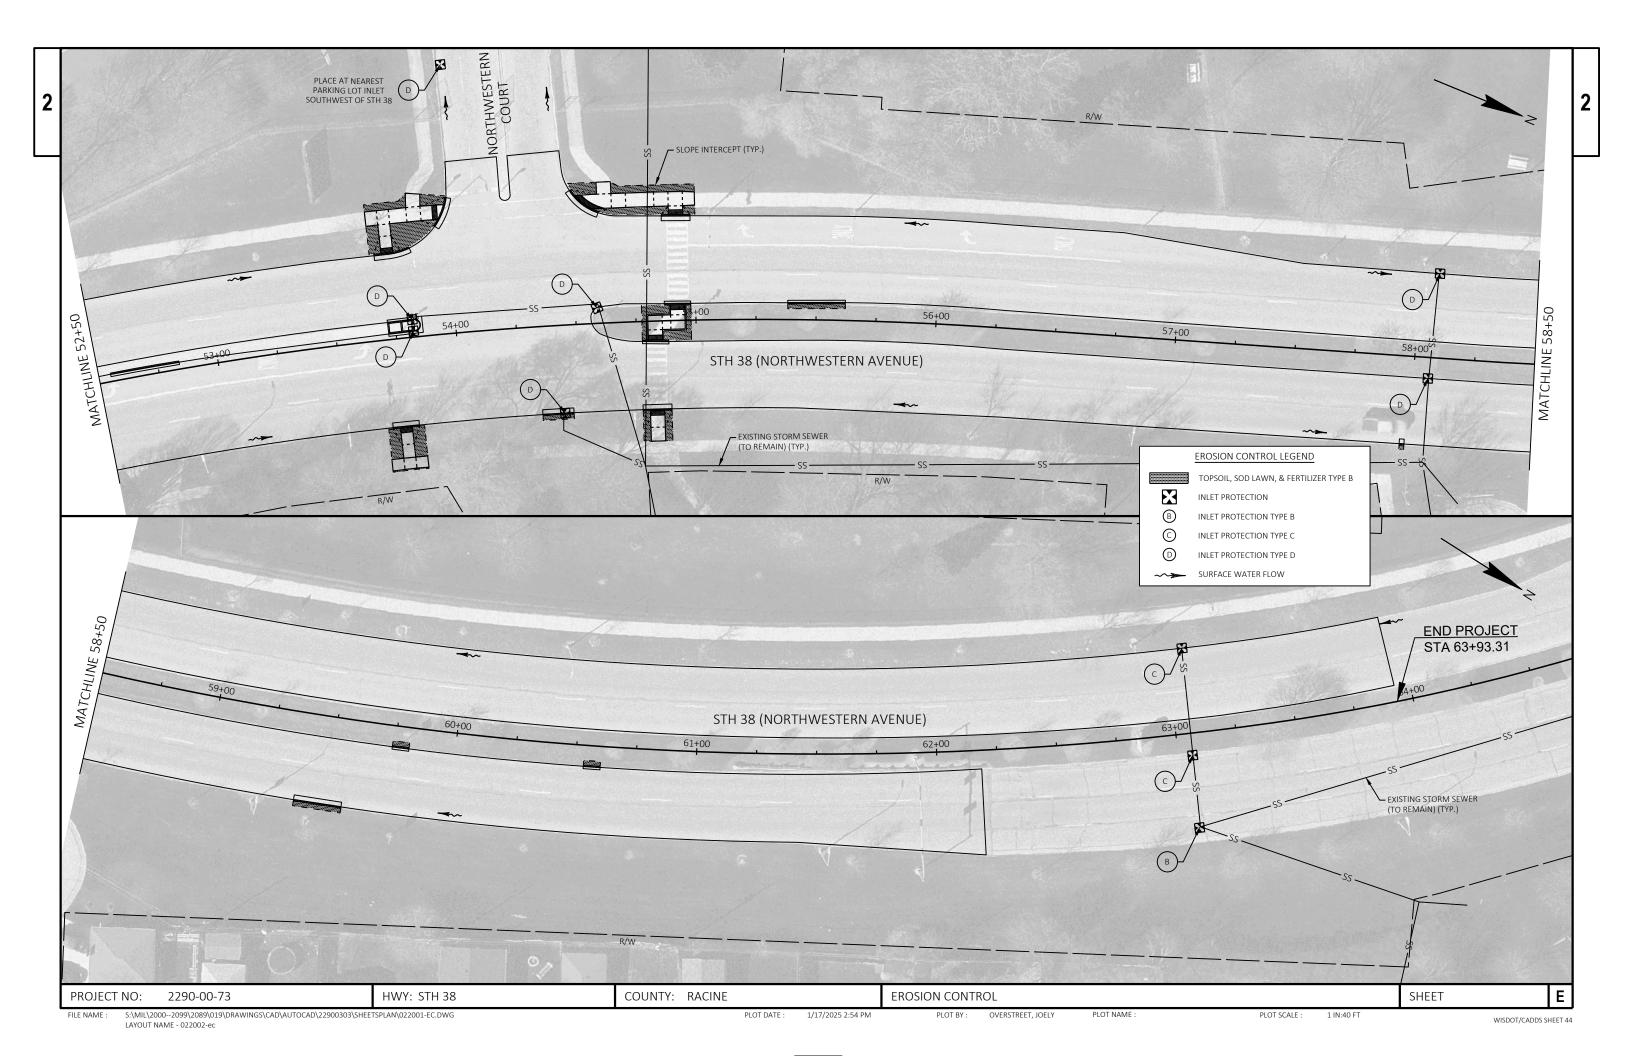


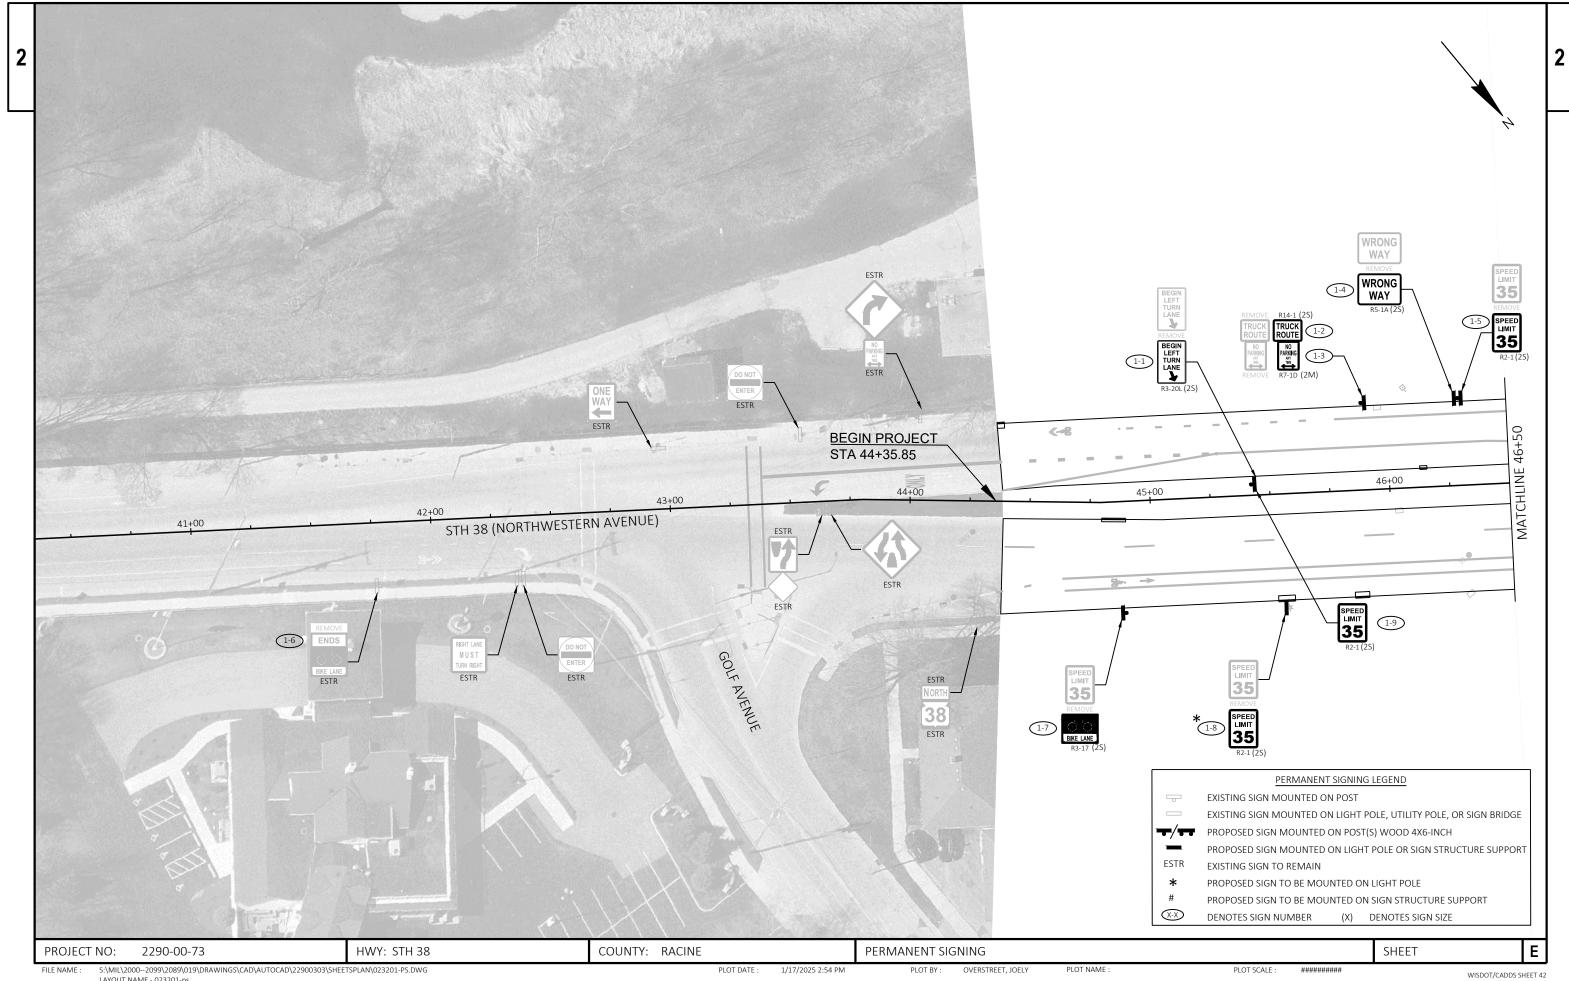

LAYOUT NAME - 023201-ps

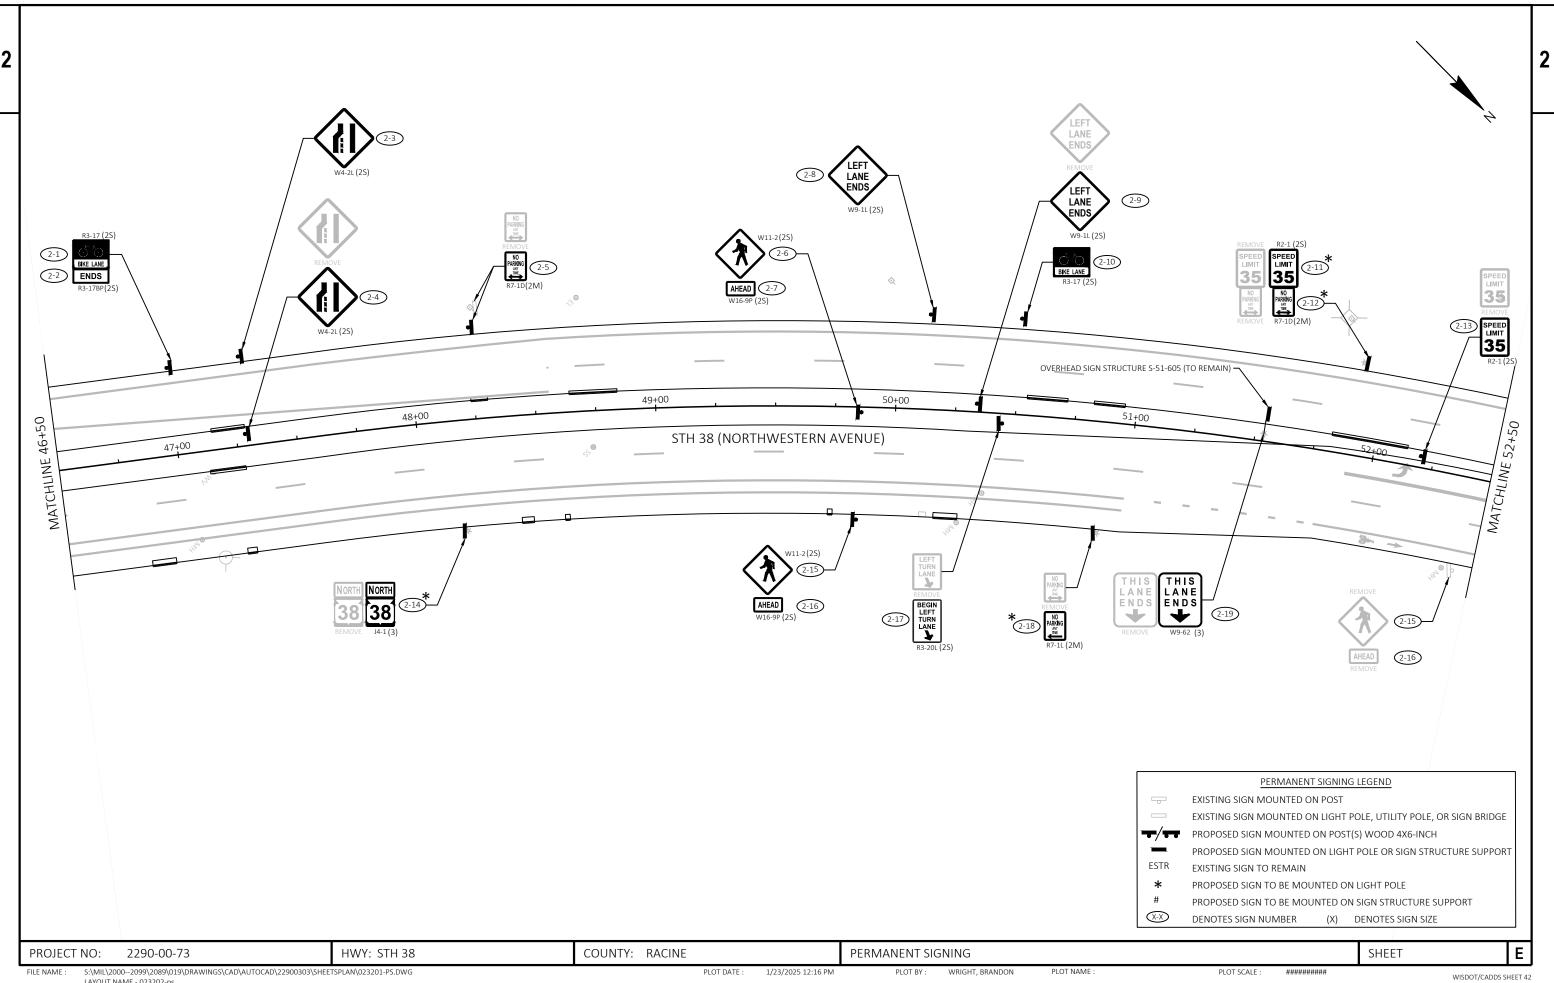

FILE NAME : S:\MIL\2000--2099\2089\019\DRAWINGS\CAD\AUTOCAD\22900303\SHEETSPLAN\023201-PS.DWG PLOT DATE : 1/23/2025 12:16 PM PLOT BY: WRIGHT, BRANDON PLOT NAME : PLOT SCALE : LAYOUT NAME - 023202-ps

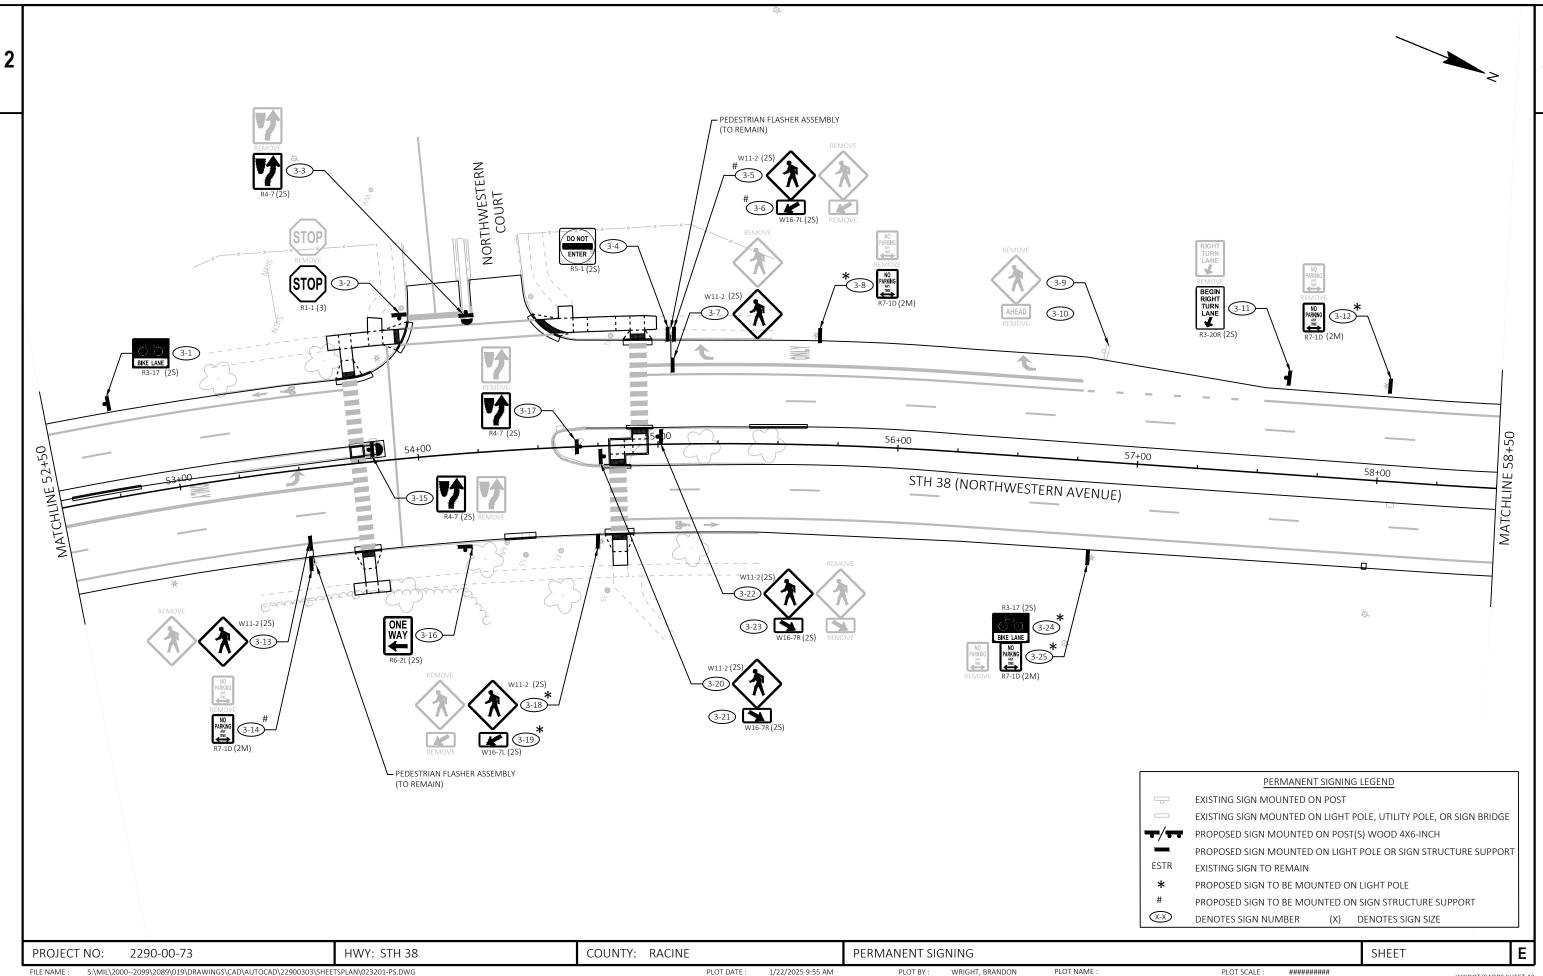


FILE NAME : S:\MIL\2000--2099\2089\019\DRAWINGS\CAD\AUTOCAD\22900303\SHEETSPLAN\023201-PS.DWG PLOT DATE : LAYOUT NAME - 023203-ps

PLOT BY: WRIGHT, BRANDON


PLOT NAME :


PLOT SCALE :

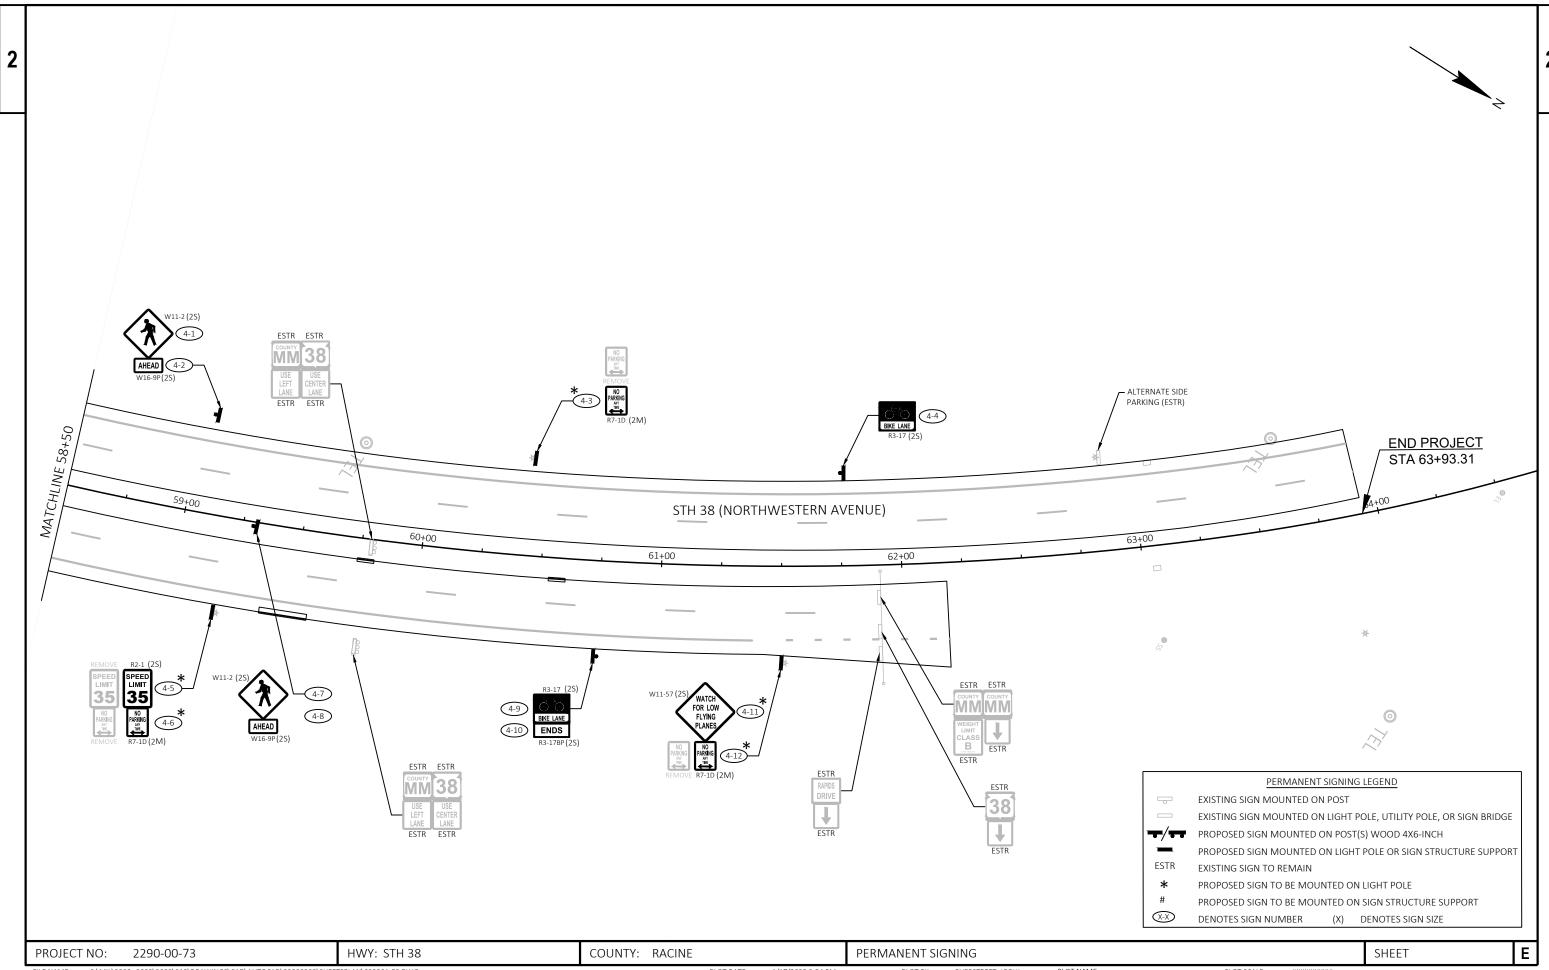



FILE NAME : \$\(\frac{1}{1}\) \(\frac{1}{2}\) \

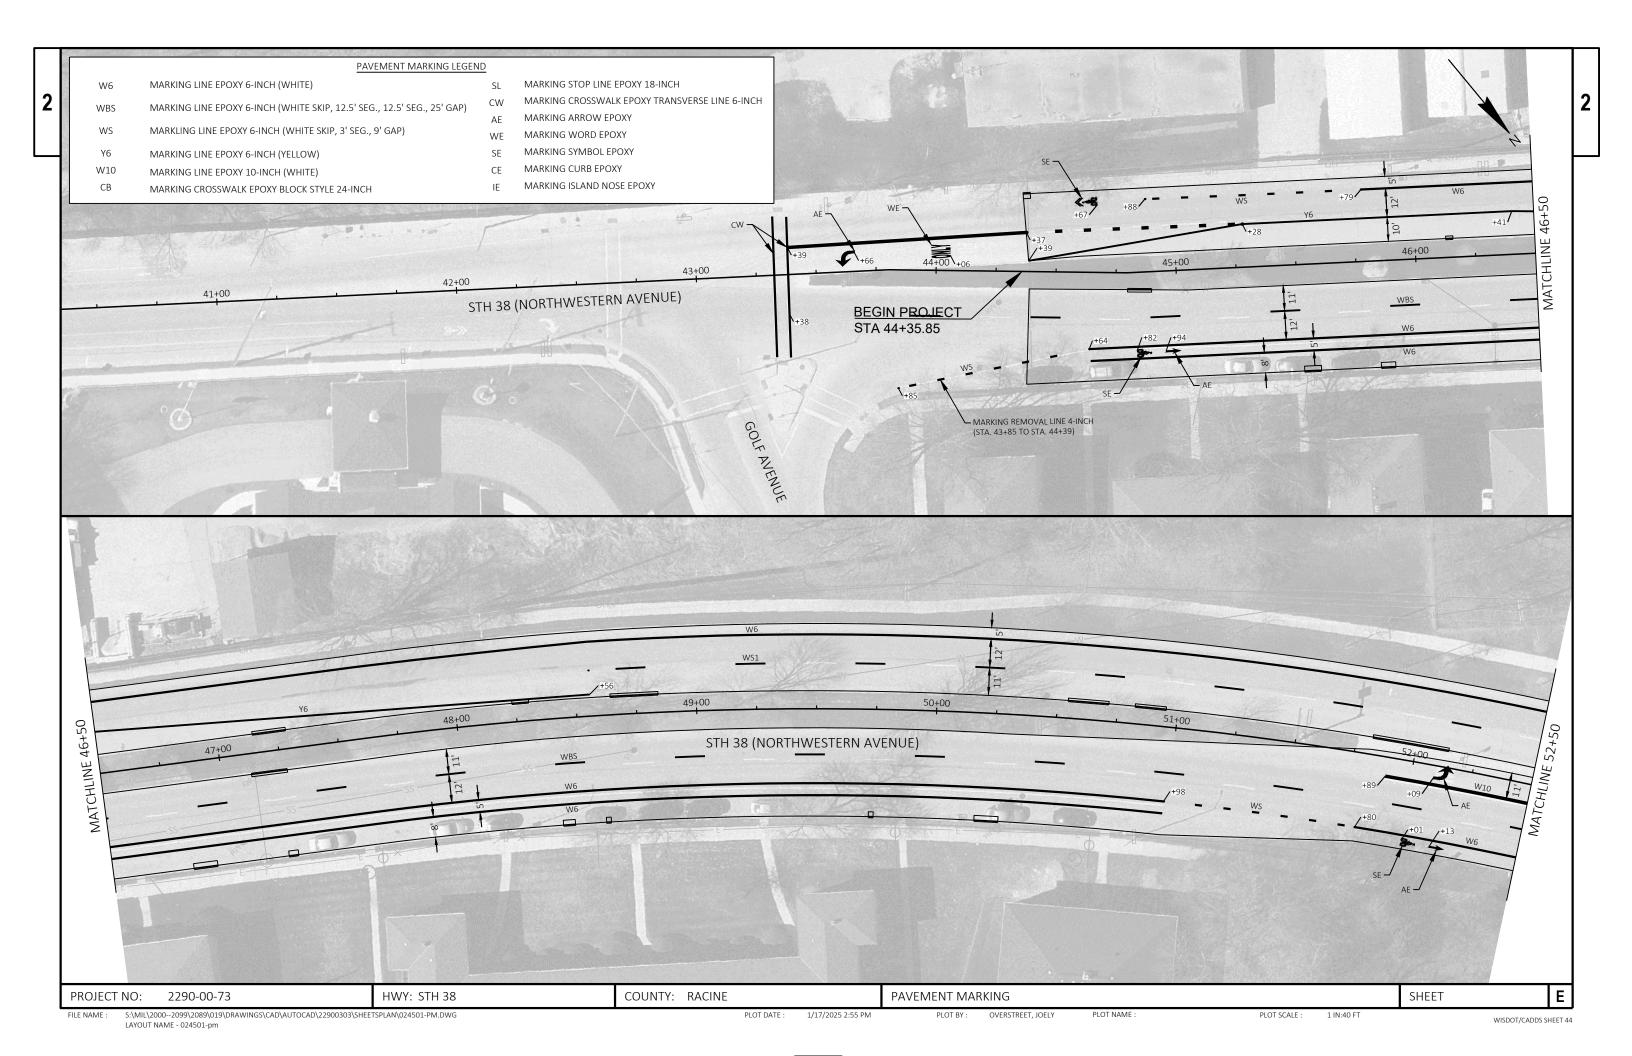

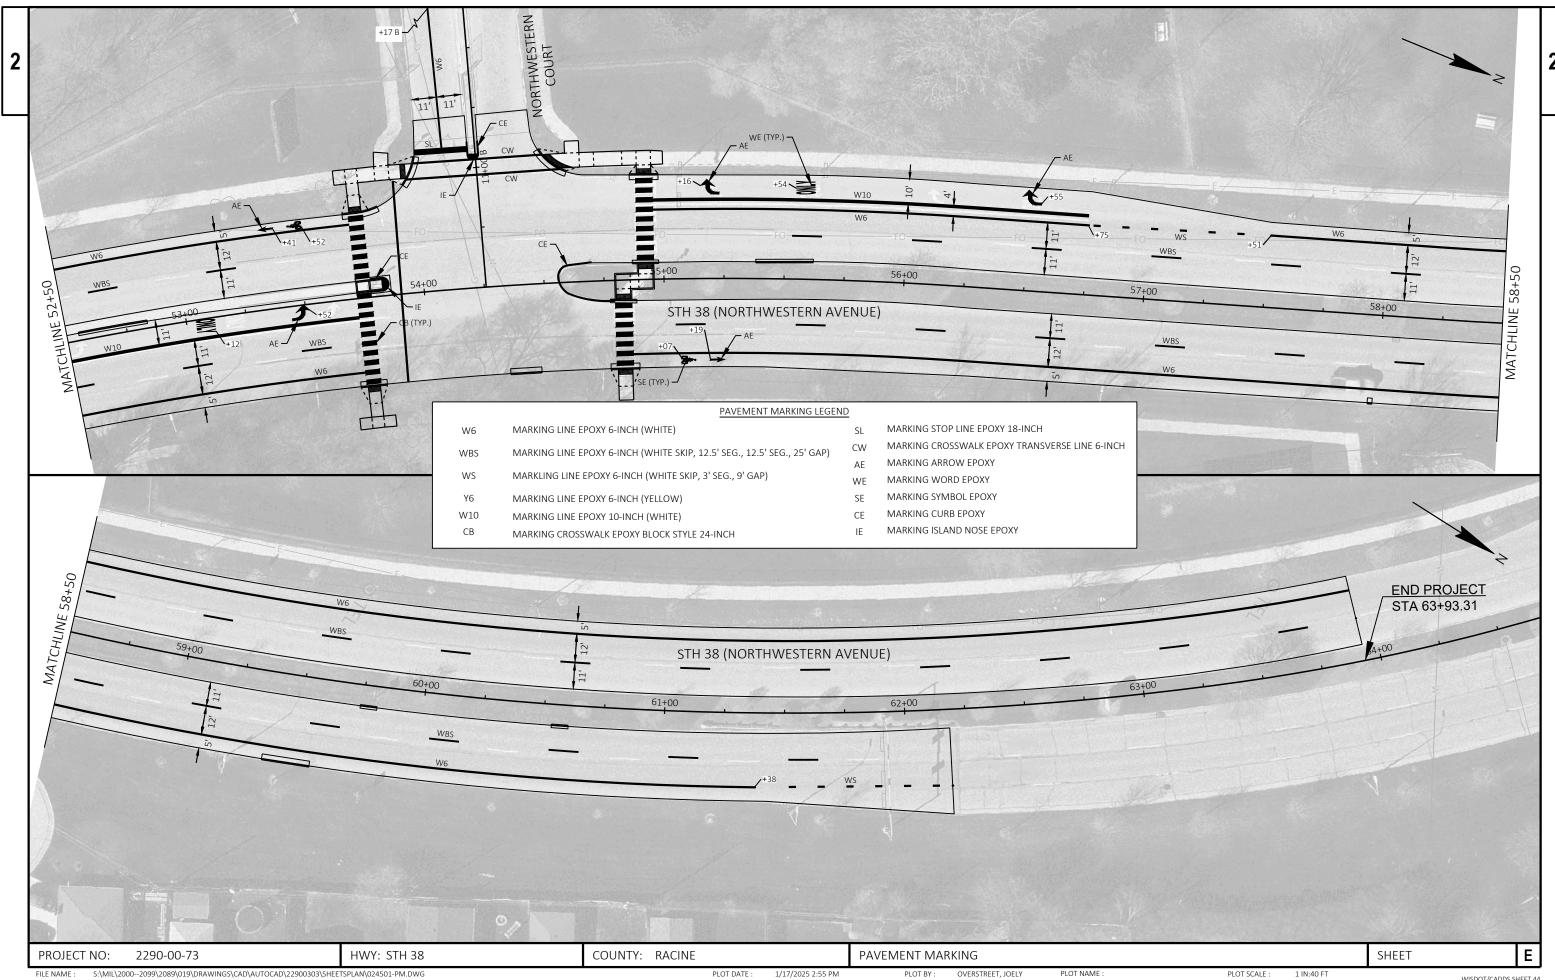

LAYOUT NAME - 024502-pm

PLOT BY: OVERSTREET, JOELY

PLOT NAME :

PLOT SCALE :



GENERAL NOTES FOR TRAFFIC CONTROL THE EXACT NUMBER, LOCATION, AND SPACING OF ALL SIGNS AND DEVICES SHALL BE ADJUSTED *RAII ROAD · TO FIT FIELD CONDITIONS AS APPROVED BY THE ENGINEER. THE SPACING BETWEEN SIGNS SHOULD BE ADJUSTED TO NOT CONFLICT WITH AND TO PROVIDE A MINIMUM OF 200 FEET (500 FEET DESIRABLE) DISTANCE TO EXISTING SIGNS. ROAD CLOSED ALL SIGNS ARE 48" X 48" UNLESS OTHERWISE NOTED. TO THRU TRAFFIC 3/4 MILE AHEAD "WO" SERIES SIGNS ARE "W" SERIES EXCEPT THE BACKGROUND IS ORANGE. ANY SIGNS, TEMPORARY OR EXISTING, WHICH CONFLICT WITH THE TRAFFIC CONTROL "IN USE" SHALL BE REMOVED OR COVERED AS NEEDED AND AS APPROVED BY THE ENGINEER. DETAILS OF TRAFFIC CONTROL NOT SHOWN ON THIS DRAWING SHALL CONFORM TO THE PCMS PERTINENT REQUIREMENTS OF THE STANDARD SPECIFICATIONS, APPLICABLE SPECIAL PROVISIONS, AND THE WISCONSIN MANUAL ON UNIFORM TRAFFIC CONTROL DEVICES (WMUTCD). FOR ADDITIONAL INFORMATION SEE STANDARD DETAIL DRAWINGS: "BARRICADES AND SIGNS FOR MAINLINE CLOSURES" "BARRICADES AND SIGNS FOR SIDEROAD CLOSURES" (A) $^{\mathbb{B}}$ GOOLD STREET ROAD ROAD ROAD CLOSED CLOSED CLOSED 1000 FT 500 FT E F G ROAD CLOSED LANE END TO THRU TRAFFIC ROAD WORK **CLOSED** ► DETAIL A 38 DETAIL A PCMS ROAD CLOSED MILE AHEAD R11-3 60"X30" NOTE: COORDINATE TRAFFIC CONTROL WITH PROJECT ID 2290-03-73, STH 38 ROOT RIVER BRIDGE. ADDITIONAL MOBILIZATIONS WILL NOT BE PAID TO ADJUST TRAFFIC CONTROL DEVICES TO COORDINATE WITH THE 2290-03-73 PROJECT. PROVIDE OFFSET TYPE III BARRICADES -*DO NOT PLACE ANY ITEMS WITHIN 50-FEET OF RAILROAD RIGHT-OF-WAY ON BOTH SIDES OF THE MEDIAN YOUT STREET LEGEND ■/___ SIGNS MOUNTED ON PERMANENT SUPPORT/TEMPORARY SUPPORT WORK ZONE TRAFFIC CONTROL DRUMS PCMS TRAFFIC CONTROL SIGNS PCMS PANEL 1 HWY 38 PCMS MESSAGE 7 DAYS PRIOR TO BEGINNING [START DATE/TIME] CONSTRUCTION TO CLOSE

2290-00-73

PROJECT NO:

PLOT DATE : 1/20/2025 4:39 PM PLOT BY: WRIGHT, BRANDON

TRAFFIC CONTROL - ADVANCED WARNING


PLOT SCALE : 1 IN:2000 FT


SHEET


Ε

HWY: STH 38

COUNTY: RACINE

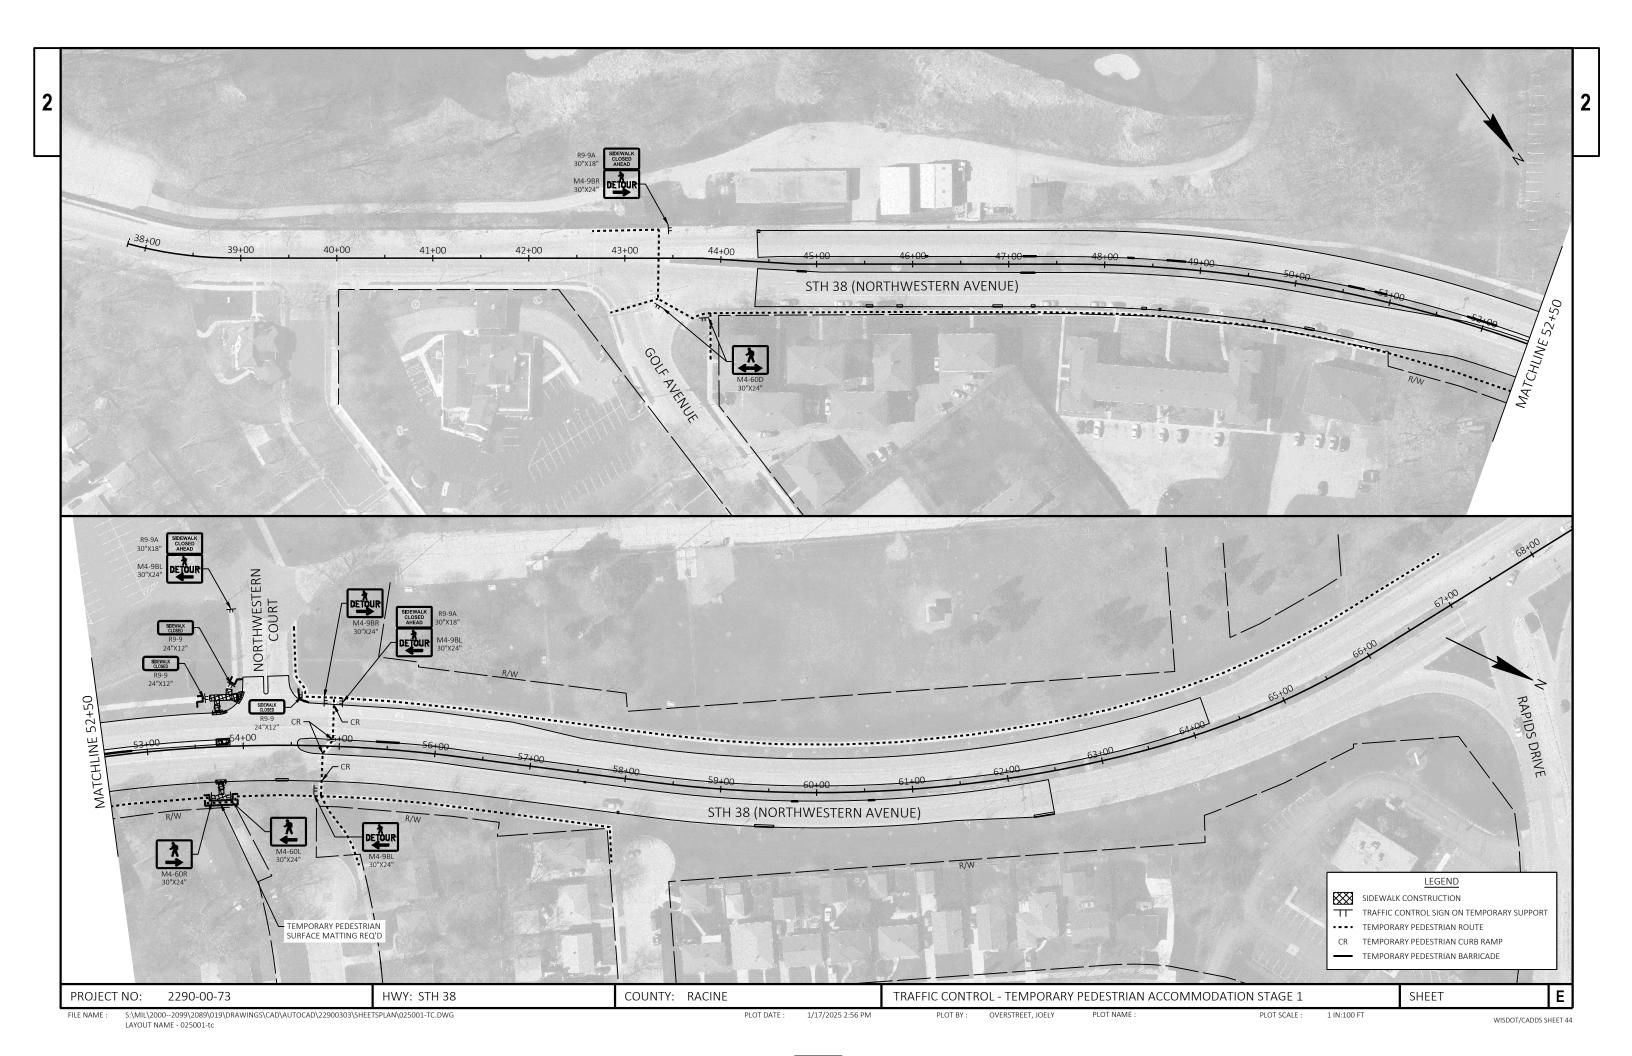

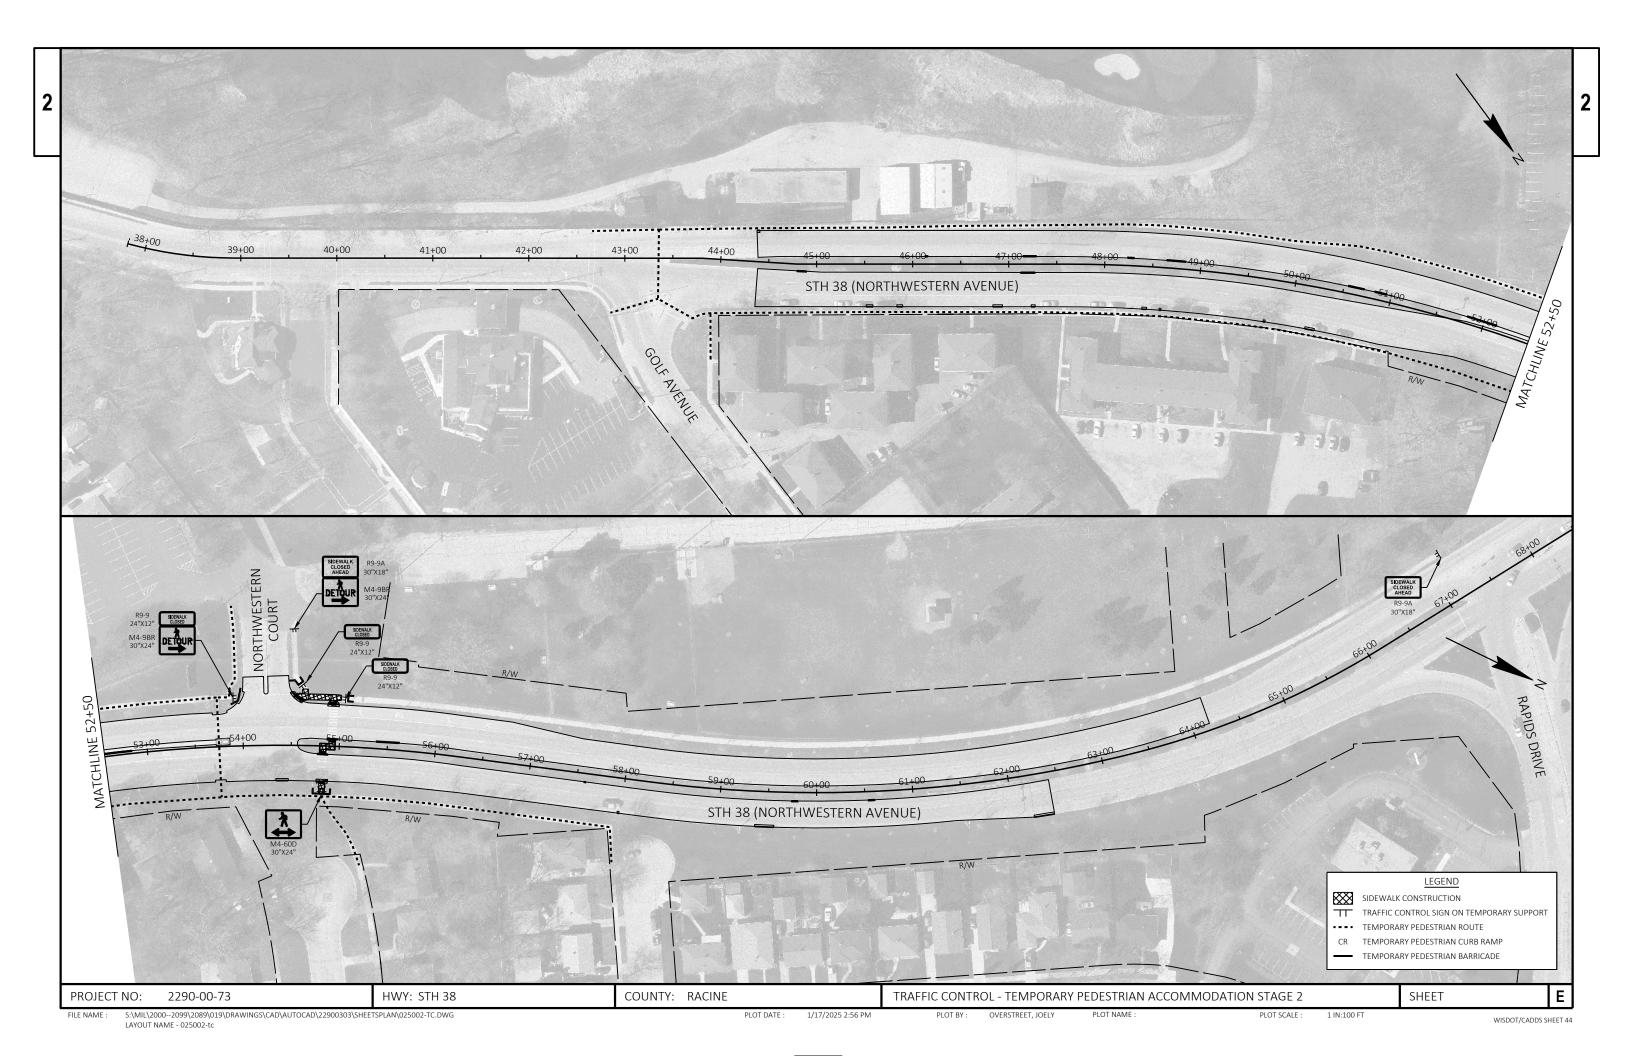

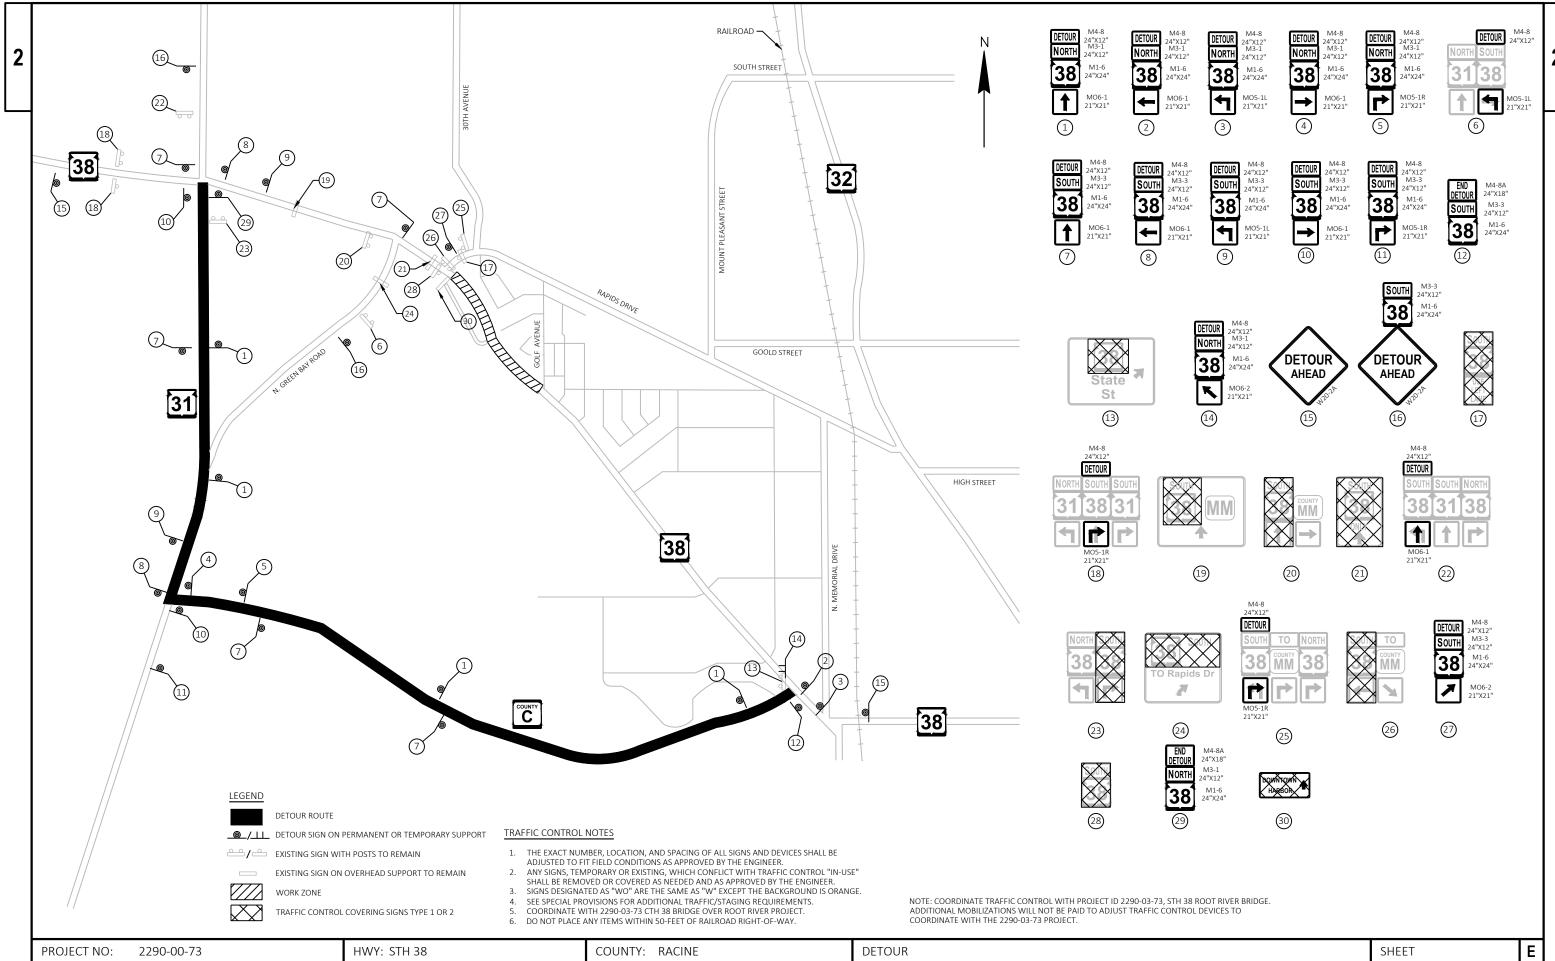

FILE NAME


PLOT DATE :

1/20/2025 4:41 PM

PLOT BY:


PLOT NAME

PLOT SCALE : 1:1500

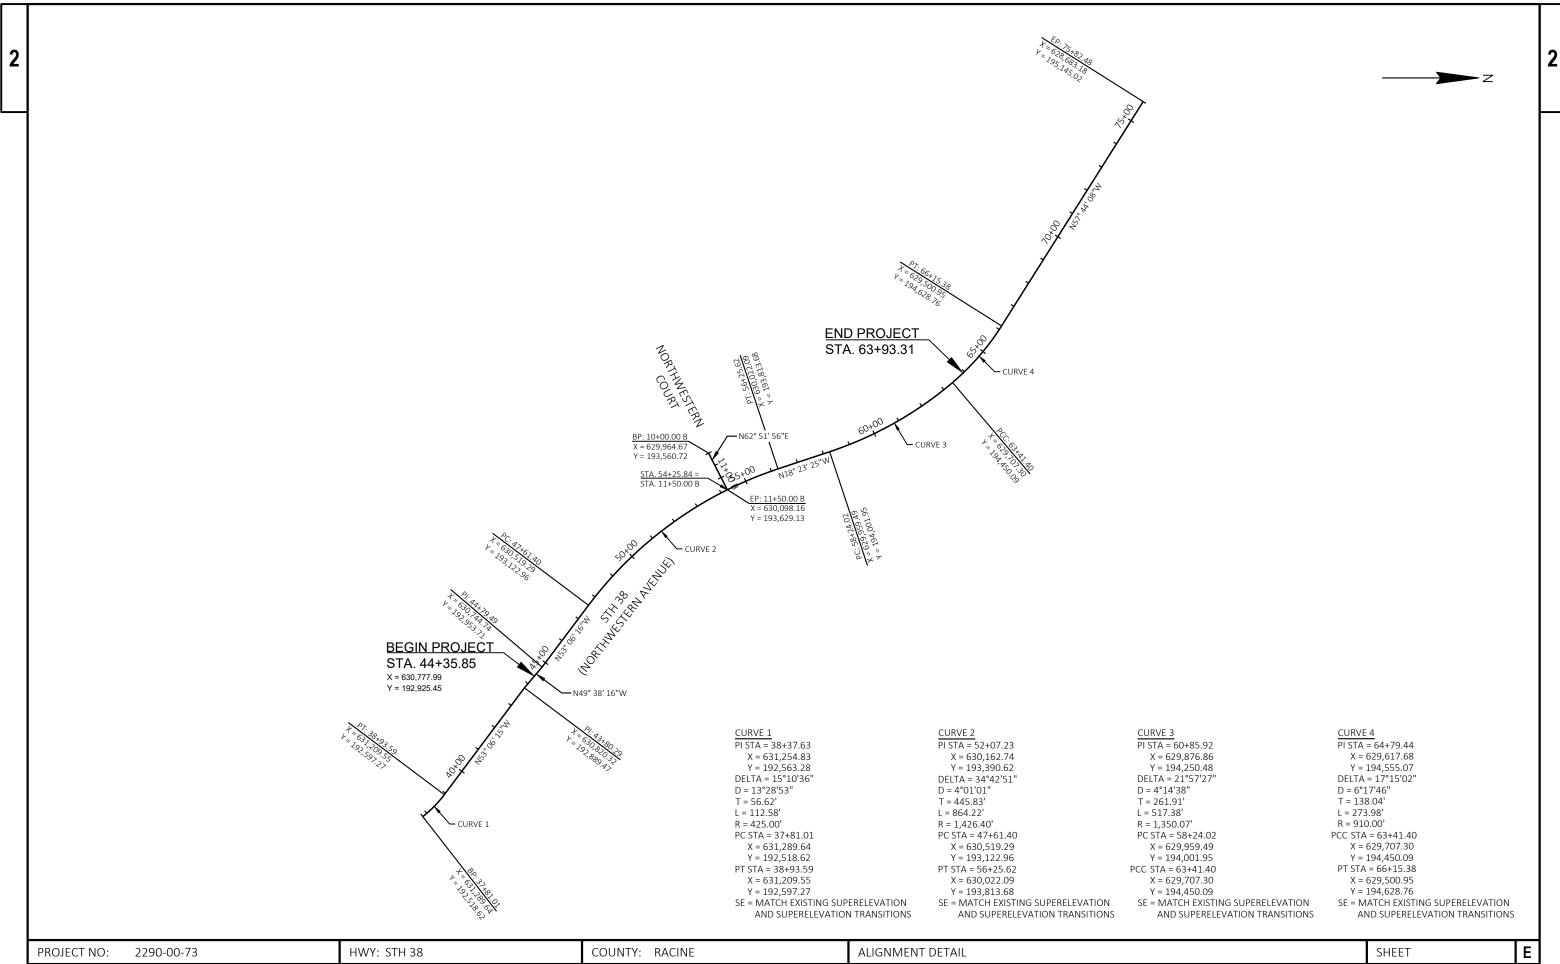

FILE NAME: S:\\MIL\\2000--2099\\2089\\019\\DATE: 1/17/2025 2:57 PM PLOT BY: OVERSTREET, JOELY PLOT NAME: 1:350 WISDOT/CADDS SHEET 42

LAYOUT NAME - 027201-ad

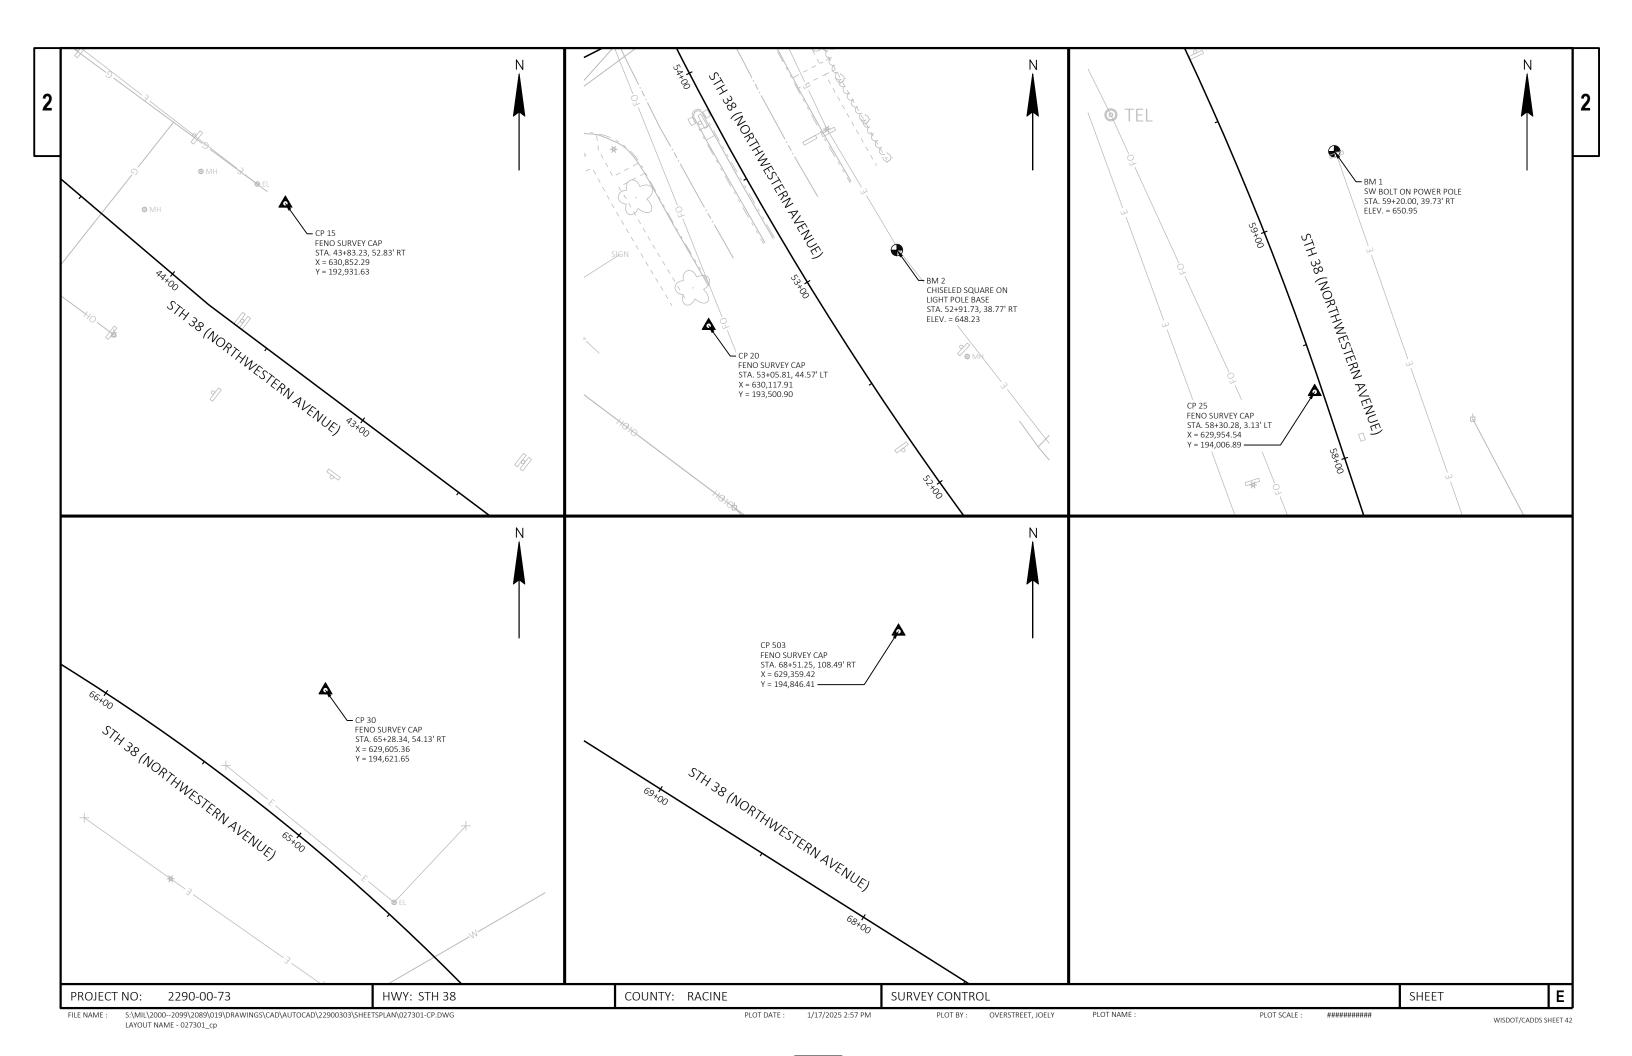

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2290	-00-	·/ O

					2290-00-73	
Line	Item	Item Description	Unit	Total	Qty	
0002	204.0115	Removing Asphaltic Surface Butt Joints	SY	40.000	40.000	
0004	204.0120	Removing Asphaltic Surface Milling	SY	13,250.000	13,250.000	
0006	204.0150	Removing Curb & Gutter	LF	510.000	510.000	
8000	204.0155	Removing Concrete Sidewalk	SY	109.000	109.000	
0010	211.0101	Prepare Foundation for Asphaltic Paving (project) 01. 2290-00-73	EACH	1.000	1.000	
0012	213.0100	Finishing Roadway (project) 01. 2290-00-73	EACH	1.000	1.000	
0014	416.0610	Drilled Tie Bars	EACH	143.000	143.000	
0016	450.4000	HMA Cold Weather Paving	TON	800.000	800.000	
0018	455.0605	Tack Coat	GAL	1,850.000	1,850.000	
0020	460.2000	Incentive Density HMA Pavement	DOL	1,990.000	1,990.000	
0022	460.5223	HMA Pavement 3 LT 58-28 S	TON	1,750.000	1,750.000	
0024	460.5224	HMA Pavement 4 LT 58-28 S	TON	1,360.000	1,360.000	
0026	601.0407	Concrete Curb & Gutter 18-Inch Type D	LF	290.000	290.000	
0028	601.0411	Concrete Curb & Gutter 30-Inch Type D	LF	210.000	210.000	
0030	601.0600	Concrete Curb Pedestrian	LF	58.000	58.000	
0032	602.0410	Concrete Sidewalk 5-Inch	SF	988.000	988.000	
0034	602.0505	Curb Ramp Detectable Warning Field Yellow	SF	80.000	80.000	
0036	602.0605	Curb Ramp Detectable Warning Field Radial Yellow	SF	20.000	20.000	
0038	611.8115	Adjusting Inlet Covers	EACH	3.000	3.000	
0040	619.1000	Mobilization	EACH	1.000	1.000	
0042	620.0200	Concrete Median Blunt Nose	SF	24.000	24.000	
0044	624.0100	Water	MGAL	1.000	1.000	
0046	625.0100	Topsoil	SY	192.000	192.000	
0048	628.1905	Mobilizations Erosion Control	EACH	2.000	2.000	
0050	628.1910	Mobilizations Emergency Erosion Control	EACH	2.000	2.000	
0052	628.7010	Inlet Protection Type B	EACH	3.000	3.000	
0054	628.7015	Inlet Protection Type C	EACH	8.000	8.000	
0056	628.7020	Inlet Protection Type D	EACH	9.000	9.000	
0058	629.0210	Fertilizer Type B	CWT	0.300	0.300	
0060	630.0200	Seeding Temporary	LB	5.000	5.000	
0062	631.0300	Sod Water	MGAL	5.000	5.000	
0064	631.1000	Sod Lawn	SY	192.000	192.000	
0066	634.0614	Posts Wood 4x6-Inch X 14-FT	EACH	15.000	15.000	
0068	634.0616	Posts Wood 4x6-Inch X 16-FT	EACH	14.000	14.000	
0070	634.0814	Posts Tubular Steel 2x2-Inch X 14-FT	EACH	1.000	1.000	
0072	637.2210	Signs Type II Reflective H	SF	327.600	327.600	
0074		Removing Signs Type II	EACH	41.000	41.000	
0076	638.3000	Removing Small Sign Supports	EACH	17.000	17.000	
0078	642.5001	Field Office Type B	EACH	1.000	1.000	
0800	643.0300	Traffic Control Drums	DAY	616.000	616.000	
0082	643.0420	Traffic Control Barricades Type III	DAY	528.000	528.000	
0084	643.0705	Traffic Control Warning Lights Type A	DAY	1,056.000	1,056.000	
0086	643.0900	Traffic Control Signs	DAY	6,600.000	6,600.000	
0088	643.0910	Traffic Control Covering Signs Type I	EACH	3.000	3.000	
0090	643.0920	Traffic Control Covering Signs Type II	EACH	15.000	15.000	
0092	643.1050	Traffic Control Signs PCMS	DAY	14.000	14.000	
0094	643.5000	Traffic Control	EACH	1.000	1.000	
0096	644.1440	Temporary Pedestrian Surface Matting	SF	180.000	180.000	
0098	644.1601	Temporary Pedestrian Curb Ramp	DAY	83.000	83.000	
		1 1 1 2	_,	-0.000	30.000	

0132 0134

0136

0138

0140

650.9911

690.0250

740.0440

2290-00-73

1.000

1.000

602.000

2,965.000

1.000

Line	Item	Item Description	Unit	Total	Qty	
0100	644.1810	Temporary Pedestrian Barricade	LF	260.000	260.000	
0102	646.2020	Marking Line Epoxy 6-Inch	LF	5,103.000	5,103.000	
0104	646.2040	Marking Line Grooved Wet Ref Epoxy 6-Inch	LF	769.000	769.000	
0106	646.4020	Marking Line Epoxy 10-Inch	LF	464.000	464.000	
0108	646.5020	Marking Arrow Epoxy	EACH	9.000	9.000	
0110	646.5120	Marking Word Epoxy	EACH	3.000	3.000	
0112	646.5220	Marking Symbol Epoxy	EACH	4.000	4.000	
0114	646.6120	Marking Stop Line Epoxy 18-Inch	LF	22.000	22.000	
0116	646.6466	Cold Weather Marking Epoxy 6-Inch	LF	1,280.000	1,280.000	
0118	646.7420	Marking Crosswalk Epoxy Transverse Line 6-Inch	LF	236.000	236.000	
0120	646.7520	Marking Crosswalk Epoxy Block Style 24-Inch	LF	214.000	214.000	
0122	646.8120	Marking Curb Epoxy	LF	81.000	81.000	
0124	646.8220	Marking Island Nose Epoxy	EACH	2.000	2.000	
0126	646.9000	Marking Removal Line 4-Inch	LF	55.000	55.000	
0128	650.8000	Construction Staking Resurfacing Reference	LF	1,955.000	1,955.000	
0130	650.9000	Construction Staking Curb Ramps	EACH	8.000	8.000	

EACH

EACH

LF

DOL

EACH

1.000

1.000

602.000

1.000

2,965.000

650.9500 Construction Staking Sidewalk (project) 01. 2290-00-73

SPV.0060 Special 01. Adjusting Sanitary Sewer Manhole Covers

Sawing Concrete

Incentive IRI Ride

Construction Staking Supplemental Control (project) 01. 2290-00-73

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REMOVING ASPHALTIC SURFACE REMOVING ASPHALTIC SURFACE HMA PAVEMENT 460.5223 460.5224 450.4000 455.0605 HMA PAVEMENT **HMA PAVEMENT** HMA COLD TACK 204.0115 204.0120 3 LT 58-28 S 4 LT 58-28 S WEATHER PAVING COAT BUTT JOINTS MILLING STATION - STATION CATEGORY TON TON TON GAL CATEGORY STATION - STATION LOCATION CATEGORY STATION - STATION LOCATION SY 0020 44+36 - 53+00 820 640 850 15 25 44+36 - 53+00 LT/RT 44+36 - 53+00 6,200 53+00 - 63+93 930 720 1,000 53+00 - 63+93 LT/RT 53+00 - 63+93 7,050 UNDISTRIBUTED 800 TOTALS TOTALS 40 13,250 TOTALS 1,750 800 1,850

NOTE: HMA PAVEMENT WEIGHT CALCULATIONS BASED ON 112 LB/SY/IN.
TACK COAT QUANTITY IS BASED ON AN APPLICATION RATE OF 0.07 GAL/SY.

PREPARE FOUNDATION FOR ASPHALTIC PAVING

		211.0101 01.2290-00-73
CATEGORY	PROJECT	EACH
0020	2290-00-73	1

SIDEWALK ITEMS

		204.0155	(02.0410	602.0505	602.0605	/F0 0000	650.9500
		204.0155	602.0410	CURB RAMP	CURB RAMP	650.9000	CONSTRUCTION
		REMOVING	CONCRETE	DETECTABLE	DETECTABLE	CONSTRUCTION	STAKING
		CONCRETE	SIDEWALK	WARNING FIELD	WARNING FIELD	STAKING	SIDEWALK
		SIDEWALK	5-INCH	YELLOW	RADIAL YELLOW	CURB RAMPS	01. 2290-00-73
CATEGORY	LOCATION	SY	SF	SF	SF	EACH	EACH
0010	NORTHWESTERN COURT	109	988	80	20	8	1

PAVEMENT BARS

			416.0610 DRILLED
CATEGORY	STATION - STATION	LOCATION	TIE BARS EACH
CATEGORI	SIATION - SIATION	LOCATION	LACIT
0010	44+36 - 53+00	LT/RT	80
	53+00 - 63+93	LT/RT	63
_			
•	TOTALS	143	

CONCRETE CURB & GUTTER

		204.0150	601.0407	601.0411	601.0600
		REMOVING	18-INCH	30-INCH	CONCRETE CURB
		CURB & GUTTER	TYPE D	TYPE D	PEDESTRIAN
CATEGORY	STATION - STATION	LF	LF	LF	LF
0010	44+36 - 53+00	210	160	50	8
	53+00 - 63+93	200	80	110	50
	UNDISTRIBUTED	100	50	50	
	TOTALS	510	290	210	58

ADJUSTING INLET COVERS

_	CATEGORY	STATION	LOCATION	611.8115 EACH
	0010	53+82 53+82 54+42	8'LT 2'RT 36'RT	1 1 1
		TOTALS		3

PROJECT NO: 2290-00-73 HWY: STH 38 COUNTY: RACINE MISCELLANEOUS QUANTITIES SHEET E

FINISHING ITEMS 629.0210 630.0200 631.0300 625.0100 631.1000 FERTILIZER SEEDING SOD TOPSOIL TYPE B TEMPORARY WATER SOD LAWN CATEGORY STATION - STATION SY CWT MGAL SY LB 0010 40 40 44+36 - 53+00 0.1 53+00 - 63+93 120 0.1 120 UNDISTRIBUTED 32 32 0.1 TOTALS 192 0.3 192

628.7010 628.7015 628.7020 TYPE B TYPE C TYPE D CATEGORY STATION - STATION EACH EACH EACH 0010 42+00 - 53+00 53+00 - 63+93 2

INLET PROTECTION

WATER 624.0100 CATEGORY STATION - STATION LOCATION MGAL 44+36 - 63+93 RT/LT 1.0

0010

MOBILIZATIONS EROSION CONTROL 628.1905 CATEGORY PROJECT EACH 2 0010 2290-00-73

MOBILIZATIONS EMERGENCY EROSION CONTROL 628.1910 CATEGORY PROJECT EACH 0010 2290-00-73 2

CONCRETE MEDIAN BLUNT NOSE 620.0200 CATEGORY STATION LOCATION SF 0010 53+83 LT 24

MARKING REMOVAL LINE 4-INCH 646.9000 CATEGORY STATION - STATION 42+00 - 53+00 55 53+00 - 63+93 TOTAL 55

TRAFFIC CONTROL AND DETOUR ITEMS

					643	.0420	643	3.0705				643.0910 TR	AFFIC CONTR	OL COVERING SIGN	643.0920 NS		643.1050 TRAFFIC	644.1440 TEMPORARY	644.1601 TEMPORARY	644.1810 TEMPORARY
				0300		CONTROL		CONTROL		0900		TYPE I			TYPE II		_ CONTROL SIGNS	PEDESTRIAN	PEDESTRIAN	PEDESTRIAN
			TRAFFIC CON	TROL DRUMS	BARRICA	DES TYPE III	WARNING	LIGHTS TYPE A	TRAFFIC CO	NTROL SIGNS	NUMBER OF	NUMBER OF		NUMBER OF	NUMBER OF		PCMS	SURFACE MATTING	CURB RAMP	BARRICADE
CATEGORY	STATION	DAYS	EACH	DAY	EACH	DAY	EACH	DAY	EACH	DAY	CYCLES	SIGNS	EACH	CYCLES	SIGNS	EACH	DAY	SF	DAY	LF
0010	DETOUR	40							112	4,480	1	3	3	1	15	15				
	ADVANCED WARNING	40	14	560	12	480	24	960	23	920							14			
	PEDESTRIAN ACCOMMODATION	40							15	600								180	76	260
	UNDISTRIBUTED			56		48		96		600									8	
	TOTALS			616		528		1,056		6,600			3			15	14	180	83	260

SHEET PROJECT NO: 2290-00-73 HWY: STH 38 COUNTY: RACINE MISCELLANEOUS QUANTITIES

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SHEET

PERMANENT SIGNING ITEMS

							637.2210	634.0614	634.0616	634.0814		638.3000 REMOVING	
							SIGNS TYPE II	POSTS WOOD	POSTS WOOD	POSTS TUBULAR STEEL	SIGNS	SMALL SIGN	
SIGN NO.	LOCATION	N SIGN CODE	SIZE CODE	SIGN MESSAGE	W [IN.]	X H [IN.]	REFLECTIVE H SF	4X6-INCH X 14-FT EACH	4X6-INCH X 16-FT EACH	2X2-INCH X 14-FT EACH	TYPE II EACH	SUPPORTS EACH	RFMARKS
1-1	LT	R3-20L	2S	BEGIN LEFT TURN LANE	24	X 36	6.00		1		1	1	MOUNT BELOW SIGN 1-9
1-2 1-3	LT LT	R14-1 R7-1D	2S 2M	TRUCK ROUTE NO PARKING ANY TIME (BOTH SIDES)		X 18 X 24	3.00 3.00		1		1 1	1	 MOUNT BELOW SIGN 1-2
1-3	LT	R5-1A	2S	WRONG WAY		X 30	8.75	1			1	1	
1-5	LT	R2-1	2S	SPEED LIMIT 35		X 30	5.00				1		MOUNT BACK-TO-BACK WITH SIGN 1-4
1-6 1-7	 RT	R3-17BP R3-17	 2S	ENDS BIKE LANE		X X 24	5.00	 1			1 1	 1	
1-8	RT LT	R2-1	2S	SPEED LIMIT 35		X 30	5.00	 1			1		MOUNT ON LIGHT POLE
1-9 2-1	LT LT	R2-1 R3-17	2S 2S	SPEED LIMIT 35 BIKE LANE		X 30 X 24	5.00 5.00		 1				
2-2	LT	R3-17BP	2S	ENDS		X 12	2.50		 1				MOUNT BELOW SIGN 2-1
2-3 2-4	lt Lt	W4-2L W4-2L	2S 2S	LEFT LANE ENDS LEFT LANE ENDS		X 36 X 36	9.00 9.00		1 1		1	1	
2-5	LT	R7-1D	2M	NO PARKING ANY TIME (BOTH SIDES)	18	X 24	3.00	1		1			
<u>2-6</u> 2-7	LT LT	W11-2 W16-9P	2S 2S	PEDESTRIAN CROSSING AHEAD		X 30	6.25 1.33		1				MOUNT BELOW SIGN 2-6
2- <i>1</i> 2-8	LT LT	W9-1L	2S	LEFT LANE ENDS		X 36	9.00		 1		 1	 1	INIOUNT BELOW SIGN 2-0
2-9	LT	W9-1L	2S	LEFT LANE ENDS	36	X 36	9.00						
2-10 2-11	LT LT	R3-17 R2-1	2S 2S	BIKE LANE SPEED LIMIT 35		X 24 X 30	5.00 5.00	1 			 1		 MOUNT ON LIGHT POLE
2-11	LT	R7-1D	2S 2M			X 24	3.00				1		MOUNT BELOW SIGN 2-7
2-13	LT	R2-1	2S	SPEED LIMIT 35	24	X 30	5.00	1			1	1	
2-14 2-15	RT RT	J4-1 W11-2	3 2S	NORTH 38 PEDESTRIAN CROSSING		X 36 X 30	6.00 6.25		 1		1 1	 1	MOUNT ON LIGHT POLE
2-15	RT	W16-9P	2S	AHEAD		X 8	1.33				1		MOUNT BELOW SIGN 2-15
2-17	RT	R3-20L	2S	BEGIN LEFT TURN LANE		X 36	6.00	1			1	1	
2-18 2-19	RT LT	R7-1L W9-62	2M 3	NO PARKING ANY TIME (LEFT SIDE) THIS LANE ENDS		X 24 X 60	3.00 20.00				1 1		MOUNT ON LIGHT POLE MOUNT ON OVERHEAD SIGN STRUCTURE S-51-605
3-1	LT	R3-17	2S	BIKE LANE		X 24	5.00	1					
3-2	LT	R1-1	3	STOP		X 30	5.18	1			11	1	
3-3 3-4	lt Lt	R4-7 R5-1	2S 2S	KEEP RIGHT Do not enter		X 30 X 30	5.00 6.25	1			1	1	 Mount on overhead sign structure pole
3-5	LT	W11-2	2S	PEDESTRIAN CROSSING		X 30	6.25				1		MOUNT ON OVERHEAD SIGN STRUCTURE POLE
3-6	LT	W16-7L	2S	DOWNWARD LEFT ARROW		X 12	2.00				1		MOUNT BELOW SIGN 3-4
3-7	<u>L</u> T LT	W11-2 R7-1D	2S 2M	PEDESTRIAN CROSSING NO PARKING ANY TIME (BOTH SIDES)		X 30 X 24	6.25 3.00				<u>1</u> 1		MOUNT ONOVERHEAD SIGN STRUCTURE MOUNT ON LIGHT POLE
3-9	LT	W11-2		PEDESTRIAN CROSSING		X 30	6.25				1	1	
3-10	LT	W16-9P		AHEAD		X 8	1.33	 1			1		
3-11 3-12	lt Lt	R3-20R R7-1D	2S 2M	BEGIN RIGHT TURN LANE NO PARKING ANY TIME (BOTH SIDES)		X 36 X 24	6.00 3.00			 	1 1	1	 MOUNT ON LIGHT POLE
3-13	RT	W11-2	2S	PEDESTRIAN CROSSING		X 30	6.25				1		MOUNT ON OVERHEAD SIGN STRUCTURE
3-14	RT	R7-1D	2M	NO PARKING ANY TIME (BOTH SIDES)			3.00	 1			1 1	 1	MOUNT ON OVERHEAD SIGN STRUCTURE POLE
3-15 3-16	LT RT	R4-7 R6-2L	2S 2S	KEEP RIGHT ONE WAY (LEFT)		X 30 X 30	5.00 5.00	1				1 	
3-17	LT	R4-7	2S	KEEP RIGHT	24	X 30	5.00	1			1	1	
3-18	RT	W11-2	2S	PEDESTRIAN CROSSING		X 30	6.25				1	1	MOUNT ON LIGHT POLE
3-19 3-20	RT RT	W16-7L W11-2	2S 2S	DOWNWARD LEFT ARROW PEDESTRIAN CROSSING		X 12 X 30	2.00 6.25		1		1 		MOUNT BELOW SIGN 3-18
3-21	RT	W16-7R	2S	DOWNWARD RIGHT ARROW	24	X 12	2.00						MOUNT BELOW SIGN 3-21
3-22	LT LT	W11-2 W16-7R	2S 2S	PEDESTRIAN CROSSING DOWNWARD RIGHT ARROW		X 30 X 12	6.25 2.00		<u> </u>		<u>1</u>	<u>1</u>	MOUNT BELOW SIGN 3-22
3-23 3-24	RT	W16-7R R3-17	2S 2S	BIKE LANE		X 12 X 24	2.00 5.00			 			MOUNT ON LIGHT POLE
3-25	RT	R7-1D	2M	NO PARKING ANY TIME (BOTH SIDES)	18	X 24	3.00				1		MOUNT BELOW SIGN 3-24
4-1 4-2	lt Lt	W11-2 W16-9P	2S 2S	PEDESTRIAN CROSSING AHEAD		X 30 X 8	6.25 1.33		1			 	 MOUNT BELOW SIGN 4-2
4-2	LT	R7-1D	2S 2M	NO PARKING ANY TIME (BOTH SIDES)			3.00				1		MOUNT ON LIGHT POLE
4-4	LT	R3-17	2S	BIKE LANE	30	X 24	5.00	1					
4-5 4-6	RT RT	R2-1 R7-1D	2S 2M	SPEED LIMIT 35 NO PARKING ANY TIME (BOTH SIDES)		X 30 X 24	5.00 3.00				1 1		MOUNT ON LIGHT POLE MOUNT BELOW SIGN 4-5
4-0	RT	W11-2	2S	PEDESTRIAN CROSSING		X 30	6.25		1				
4-8	RT	W16-9P	2S	AHEAD	24	X 8	1.33						MOUNT BELOW SIGN 4-7
4-9 4-10	RT RT	R3-17 R3-17BP	2S 2S	BIKE LANE ENDS		X 24 X 12	5.00 2.50		1				 MOUNT BELOW SIGN 4-9
4-10	RT	W11-57	2S	WATCH FOR LOW FLYING PLANES		X 36	9.00						MOUNT ON LIGHT POLE
4-12	RT	R7-1D	2M	NO PARKING ANY TIME (BOTH SIDES)			3.00				1		MOUNT BELOW SIGN 4-12
5-1		W11-57	2\$	WATCH FOR LOW FLYING PLANES	36	X 36	9.00		1				
			-	TOTALS			327.60	15	14	1	41	17	_
									•				

MISCELLANEOUS QUANTITIES

FILE NAME : PLOT DATE : PLOT BY : PLOT NAME : PLOT SCALE : 1:1

COUNTY: RACINE

PROJECT NO: 2290-00-73

HWY: STH 38

3

PAVEMENT MARKING ITEMS

				16.2020 NE EPOXY 6-INCH		646.2040 Marking Line Grooved Wet reflective Epoxy 6-inch	646.4020 MARKING LINE	646.5020	646.5120	646.5220	646.6120	646.6466	646.7420	646.7520		646.8220
		SOLID WHITE	SOLID YELLOW	DASHED WHITE 12.5-FOOT SEG., 37.5-FOOT GAP	DASHED WHITE 3-FOOT SEG., 9-FOOT GAP	DASHED BLACK 12.5-FOOT SEG., 37.5-FOOT GAP	EPOXY 10-INCH SOLID WHITE	MARKING ARROW EPOXY	MARKING WORD EPOXY	MARKING SYMBOL EPOXY	MARKING STOP LINE EPOXY 18-INCH	COLD WEATHER MARKING EPOXY 6-INCH	MARKING CROSSWALK EPOXY TRANSVERSE LINE 6-INCH	MARKING CROSSWALK EPOXY BLOCK STYLE 24-INCH	646.8120 MARKING CURB EPOXY	MARKING ISLAND NOSE EPOXY
CATEGORY	STATION - STATION	<u>L</u> F	<u>L</u> t	<u>L</u> F	<u>L</u> t	Lŀ	<u>L</u> F	EACH	EACH	EACH	Lŀ	<u>L</u> F	<u>L</u> F	<u>L</u> F	<u>L</u> F	EACH
0010	44+36 - 53+90 53+90 - 63+93	2,250 1.540	419	362 407	86 40	362 407	282 182	6	2 1	3 1	 22		118 118	102 112	18 63	1 1
	UNDISTRIBUTED															
	SUBTOTALS	3,790	419	769	125	769	464	9	3	4	22	1,280	236	214	81	2
	TOTALS		Į	5,103		769	464	9	3	4	22	1,280	236	214	81	2

CONSTRUCTION STAKING RESURFACING REFERENCE

		650.8000
CATEGORY	STATION - STATION	LF
0010	44+36 - 53+00	865
	53+00 - 63+93	1,090
	TOTAL	1 955

CONSTRUCTION STAKING SUPPLEMENTAL CONTROL

		650.9911 01. 2290-00-73
CATEGORY	PROJECT	EACH
0010	2290-00-73	1


ADJUSTING SANITARY SEWER MANHOLE COVERS

			SPV.0060.01
CATEGORY	STATION	LOCATION	EACH
0030	50+38	RT	1

SAWING CONCRETE

CATEGORY	STATION - STATION	LOCATION	690.0250 LF
0010	44+36 - 53+00 53+00 - 63+93	LT/RT LT/RT	284 318
	TOTAL		602


PROJECT NO: 2290-00-73 HWY: STH 38 COUNTY: RACINE MISCELLANEOUS QUANTITIES SHEET E

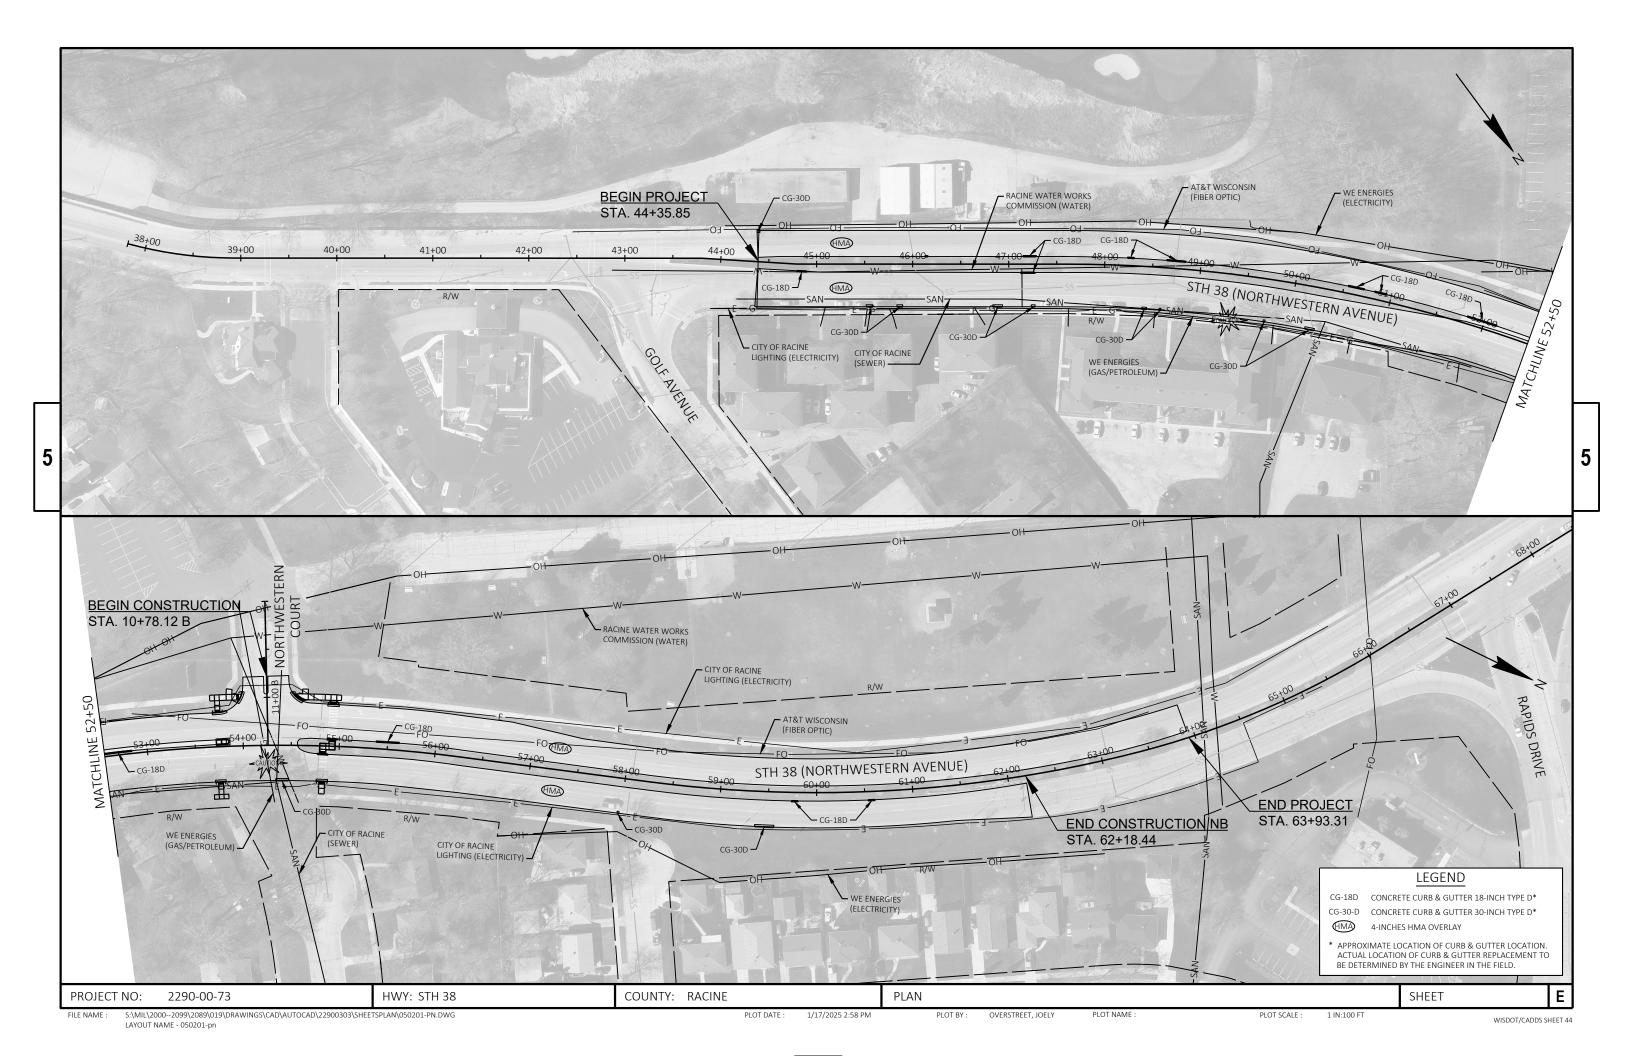



Standard Detail Drawing List

08D01-23A	CONCRETE CURB & GUTTER
08D01-23B	CONCRETE CURB, TIES AND CURB AND GUTTER APPLICATIONS
08D05-21A	CURB RAMPS TYPES 1 AND 1-A
08D05-21B	CURB RAMPS TYPES 2 AND 3
08D05-21C	CURB RAMPS TYPES 4A AND 4A1
08D05-21D	CURB RAMPS TYPE 4B AND 4B1
08D05-21E	CURB RAMPS TYPES 5, 6, 7A, 7B & 8
08D05-21F	CURB RAMPS RADIAL DETECTABLE WARNING FIELD APPLICATIONS
08D05-21G	CURB RAMPS RECTANGULAR AND RADIAL DETECTABLE WARNING PLATES
08E10-02	INLET PROTECTION TYPE A, B, C AND D
11B02-02	CONCRETE MEDIAN NOSE
13C19-03	HMA LONGITUDINAL JOINTS
15C02-09A	BARRICADES AND SIGNS FOR MAINLINE CLOSURES
15C02-09B	BARRICADES AND SIGNS FOR VARIOUS CLOSURES
15C02-09C	DETOUR SIGNING FOR MAINLINE CLOSURES
15C02-09H	MODIFIED ROUTE ASSEMBLY FOR DETOUR SIGNING
15C03-05	BARRICADES AND SIGNS FOR SIDEROAD CLOSURES
15C07-15A	PAVEMENT MARKING SYMBOLS
15C07-15B	PAVEMENT MARKING WORDS
15C07-15C	PAVEMENT MARKING ARROWS
15C07-15E	PAVEMENT MARKING FOR BIKE LANES
15C08-23A	PERMANENT LONGITUDINAL PAVEMENT MARKINGS
15C08-23D	PAVEMENT MARKING (TURN LANES)
15C11-10B	CHANNELIZING DEVICES DRUMS, CONES, BARRICADES AND VERTICAL PANELS
15С18-09В	PAVEMENT MARKINGS, MEDIAN ISLAND NOSE
15C29-08A	BICYCLE LANE MARKING
15C33-05	STOP LINE AND CROSSWALK PAVEMENT MARKING
15D30-09A	TRAFFIC CONTROL, PEDESTRIAN ACCOMMODATION
15D30-09B	TRAFFIC CONTROL, PEDESTRIAN ACCOMMODATION
15D30-09C	TRAFFIC CONTROL, PEDESTRIAN ACCOMMODATION
15D30-09D	TRAFFIC CONTROL, PEDESTRIAN ACCOMMODATION
15D30-09F	TRAFFIC CONTROL, PEDESTRIAN ACCOMMODATION
15D30-09G	TRAFFIC CONTROL, PEDESTRIAN ACCOMMODATION

6

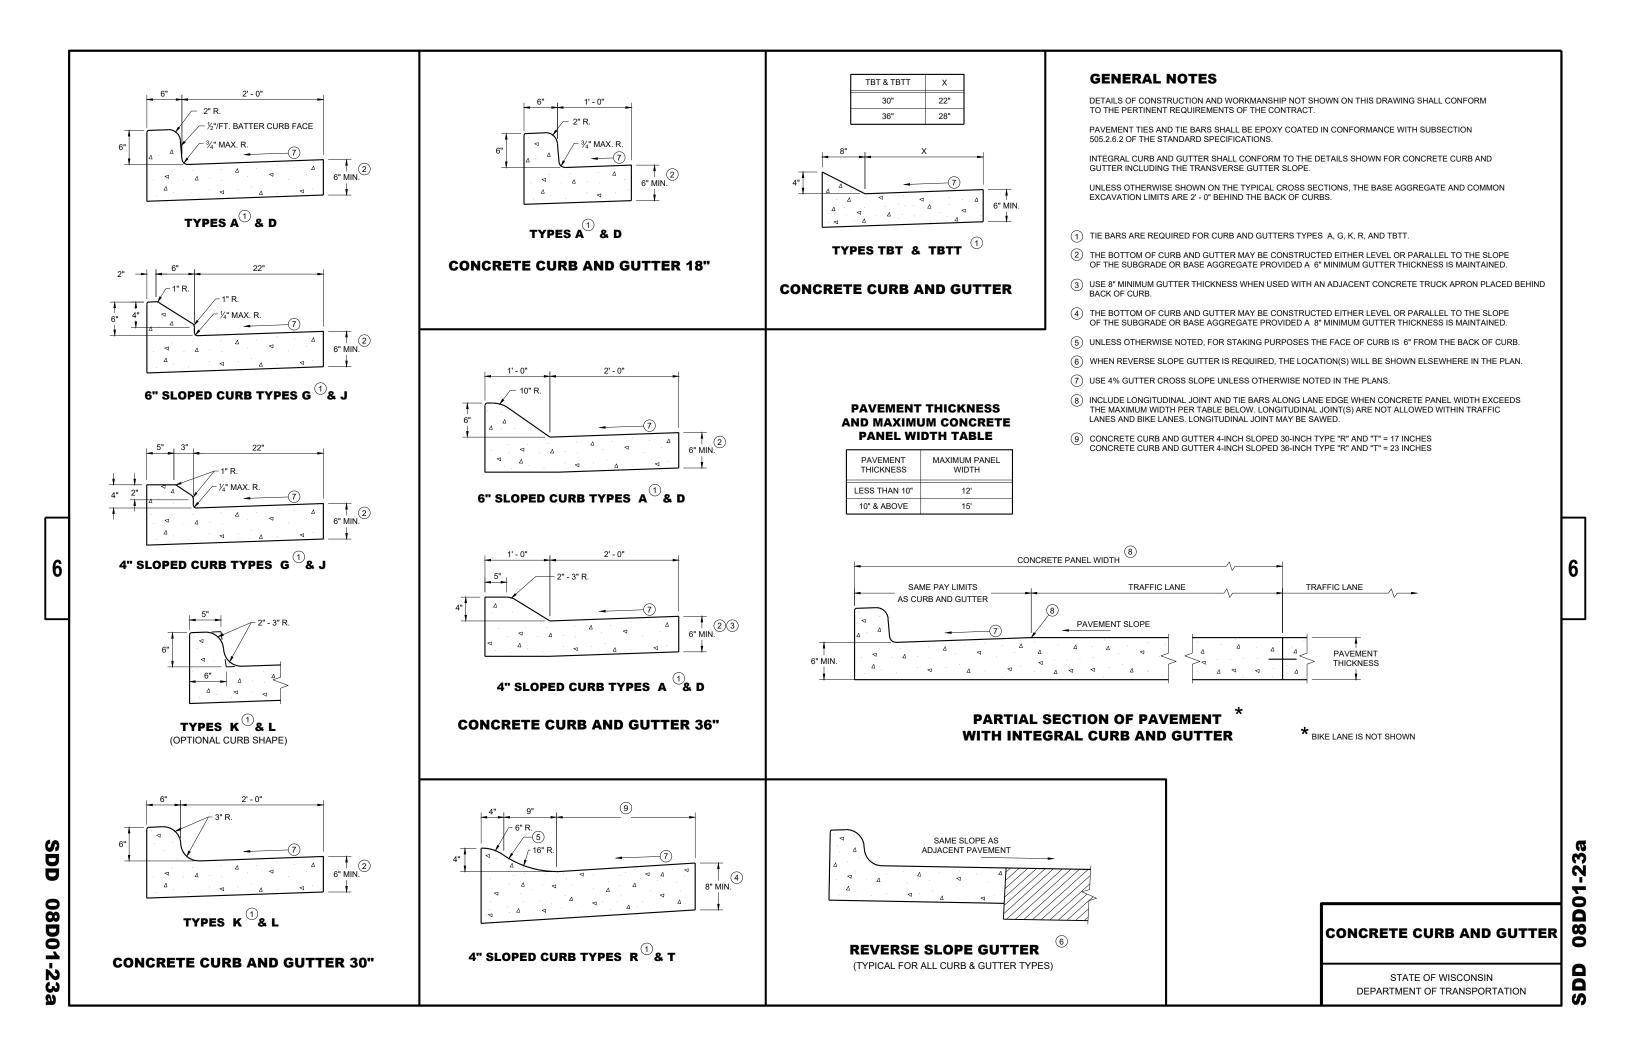

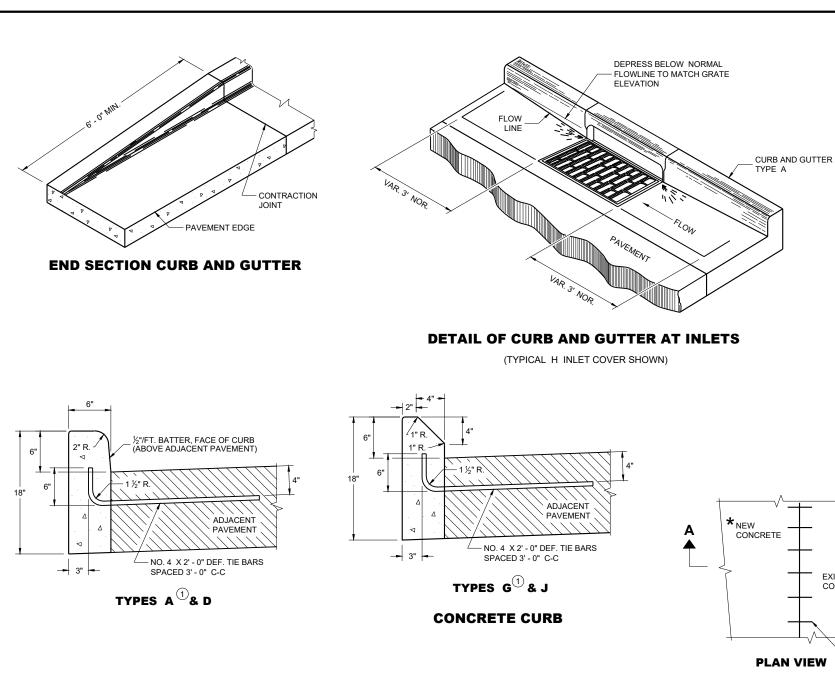

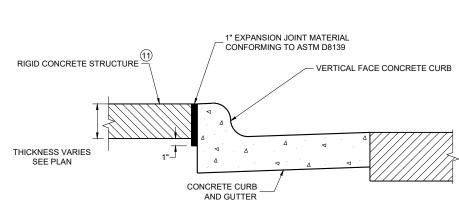

EXPANSION JOINT DETAIL FOR VERTICAL CURB ABUTTING A RIGID STRUCTURE 119

* NEW CONCRETE * NEW CURB AND GUTTER, SURFACE DRAINS, CONCRETE PAVEMENT OR OTHER NEW CONCRETE. * NEW CURB AND GUTTER, SURFACE DRAINS, CONCRETE PAVEMENT OR OTHER NEW CONCRETE. * NEW CURB AND GUTTER, SURFACE DRAINS, CONCRETE PAVEMENT OR OTHER NEW CONCRETE. * NEW CURB AND GUTTER, SURFACE DRAINS, CONCRETE PAVEMENT OR OTHER NEW CONCRETE. * NEW CURB AND GUTTER, SURFACE DRAINS, CONCRETE PAVEMENT OR OTHER NEW CONCRETE. * NEW CURB AND GUTTER, SURFACE DRAINS, CONCRETE PAVEMENT OR OTHER NEW CONCRETE. * NEW CURB AND GUTTER, SURFACE DRAINS, CONCRETE PAVEMENT OR OTHER NEW CONCRETE. * NEW CURB AND GUTTER, SURFACE DRAINS, CONCRETE PAVEMENT OR OTHER NEW CONCRETE. * NEW CURB AND GUTTER, SURFACE DRAINS, CONCRETE PAVEMENT OR OTHER NEW CONCRETE. * NEW CURB AND GUTTER, SURFACE DRAINS, CONCRETE PAVEMENT OR OTHER NEW CONCRETE. * NO. 6 TIE BARS SPACED 2' - 6" C-C, INSTALLED PERPENDICULAR TO THE LONGITUDINAL JOINT * MAXIMUM DRILL HOLE SIZE IS ½" GREATER THAN TIE BAR DIAMETER

EXISTING

SECTION A - A

½ THICKNESS OF_ NEW CONCRETE

TIE BARS DRILLED
INTO EXISTING PAVEMENT


GENERAL NOTES

DETAILS OF CONSTRUCTION AND WORKMANSHIP NOT SHOWN ON THIS DRAWING SHALL CONFORM TO THE PERTINENT REQUIREMENTS OF THE CONTRACT.


PAVEMENT TIES AND TIE BARS SHALL BE EPOXY COATED IN CONFORMANCE WITH SUBSECTION 505.2.6.2 OF THE STANDARD SPECIFICATIONS.

UNLESS OTHERWISE SHOWN ON THE TYPICAL CROSS SECTIONS, THE BASE AGGREGATE AND COMMON EXCAVATION LIMITS ARE 2'- 0" BEHIND THE BACK OF CURBS.

- 1) TIE BARS ARE REQUIRED FOR CURB AND GUTTERS TYPES A, G, K, R, AND TBTT.
- (2) THE BOTTOM OF CURB AND GUTTER MAY BE CONSTRUCTED EITHER LEVEL OR PARALLEL TO THE SLOPE OF THE SUBGRADE OR BASE AGGREGATE PROVIDED A 6" MINIMUM GUTTER THICKNESS IS MAINTAINED.
- 10 REFER TO SDD 08D18 AND 08D19 FOR ADDITIONAL DRIVEWAY ENTRANCE CURB DETAILS.
- 1 PLACE 1" THICK EXPANSION JOINT MATERIAL BETWEEN VERTICAL FACE CURB TYPES EXTENDING FROM THE TOP OF CURB TO 1 INCH BELOW THE ADJOINING CONCRETE SURFACE. RIGID CONCRETE STRUCTURES INCLUDE RAISED CONCRETE MEDIANS, CONCRETE SAFETY ISLANDS, SPLITTER ISLANDS, OR LOCATIONS IDENTIFIED ON THE PLANS.

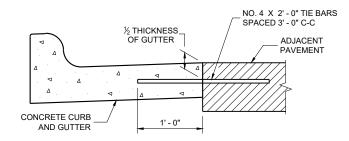

TYPICAL TIE BAR LOCATION

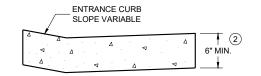

DRIVEWAY ENTRANCE CURB

(WHEN DIRECTED BY THE ENGINEER)

CONCRETE CURB, TIES AND CURB AND GUTTER APPLICATIONS

STATE OF WISCONSIN DEPARTMENT OF TRANSPORTATION


 May 2023
 /S/ Rodnery Taylor


 DATE
 ROADWAY STANDARDS DEVELOPMENT

 UNIT SUPERVISOR

SDD 08D01-23b

DD 08D01-23k

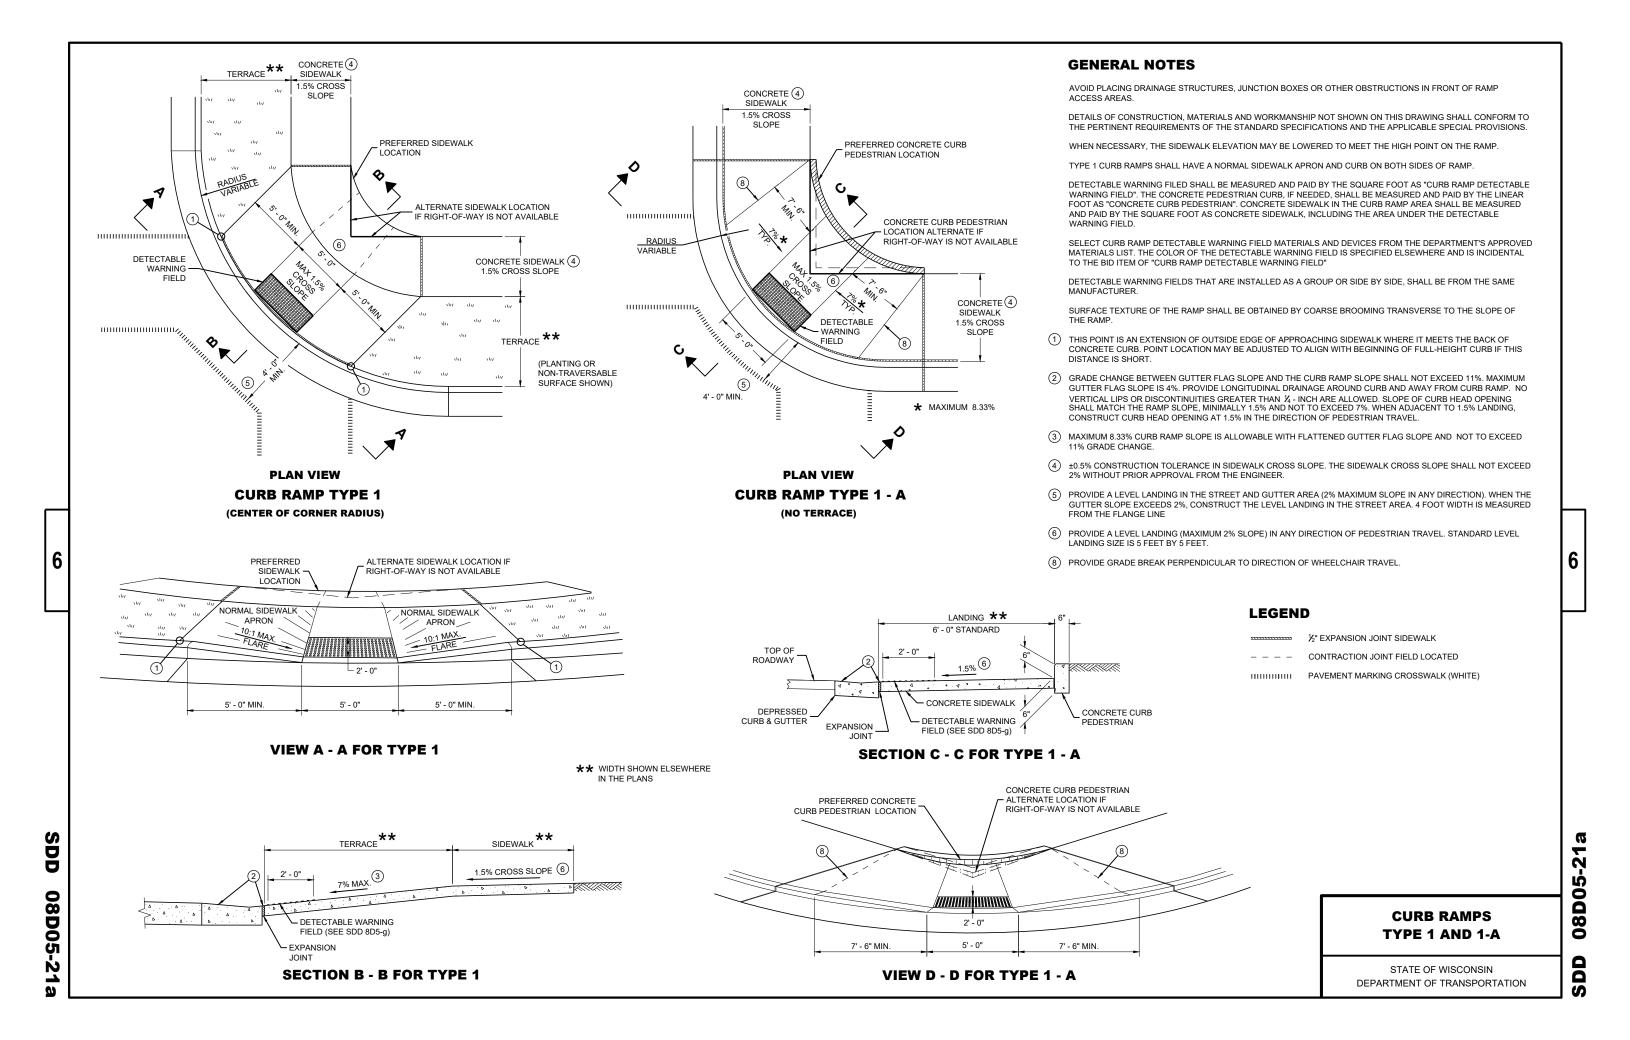


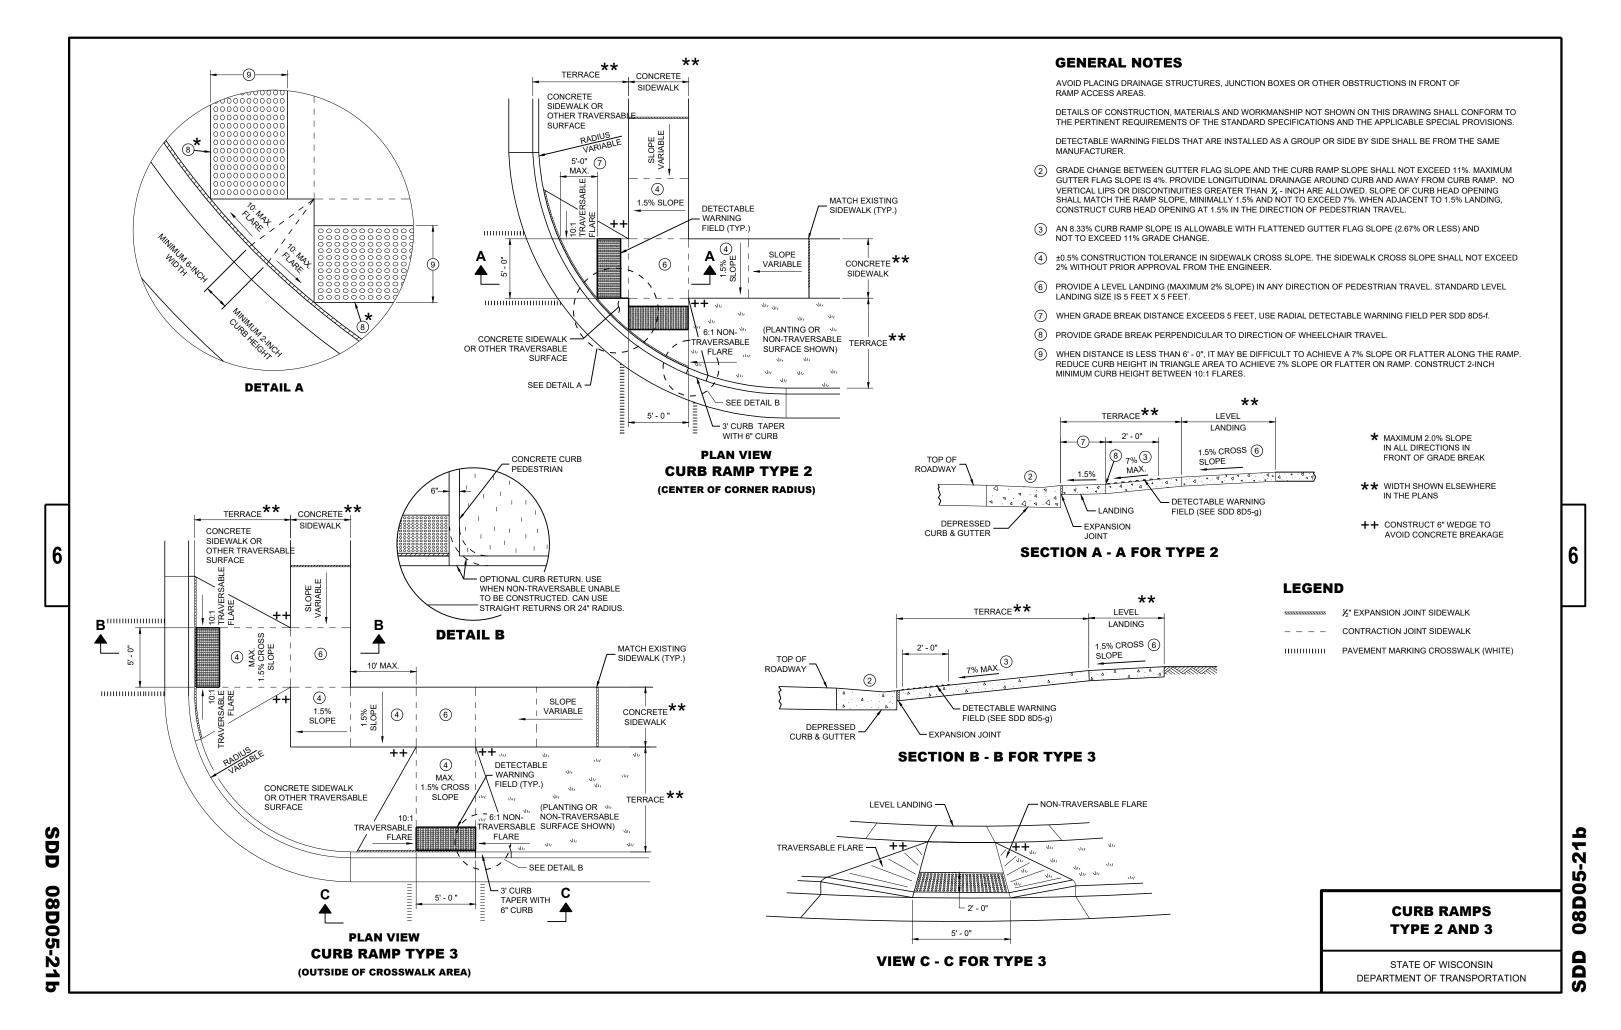



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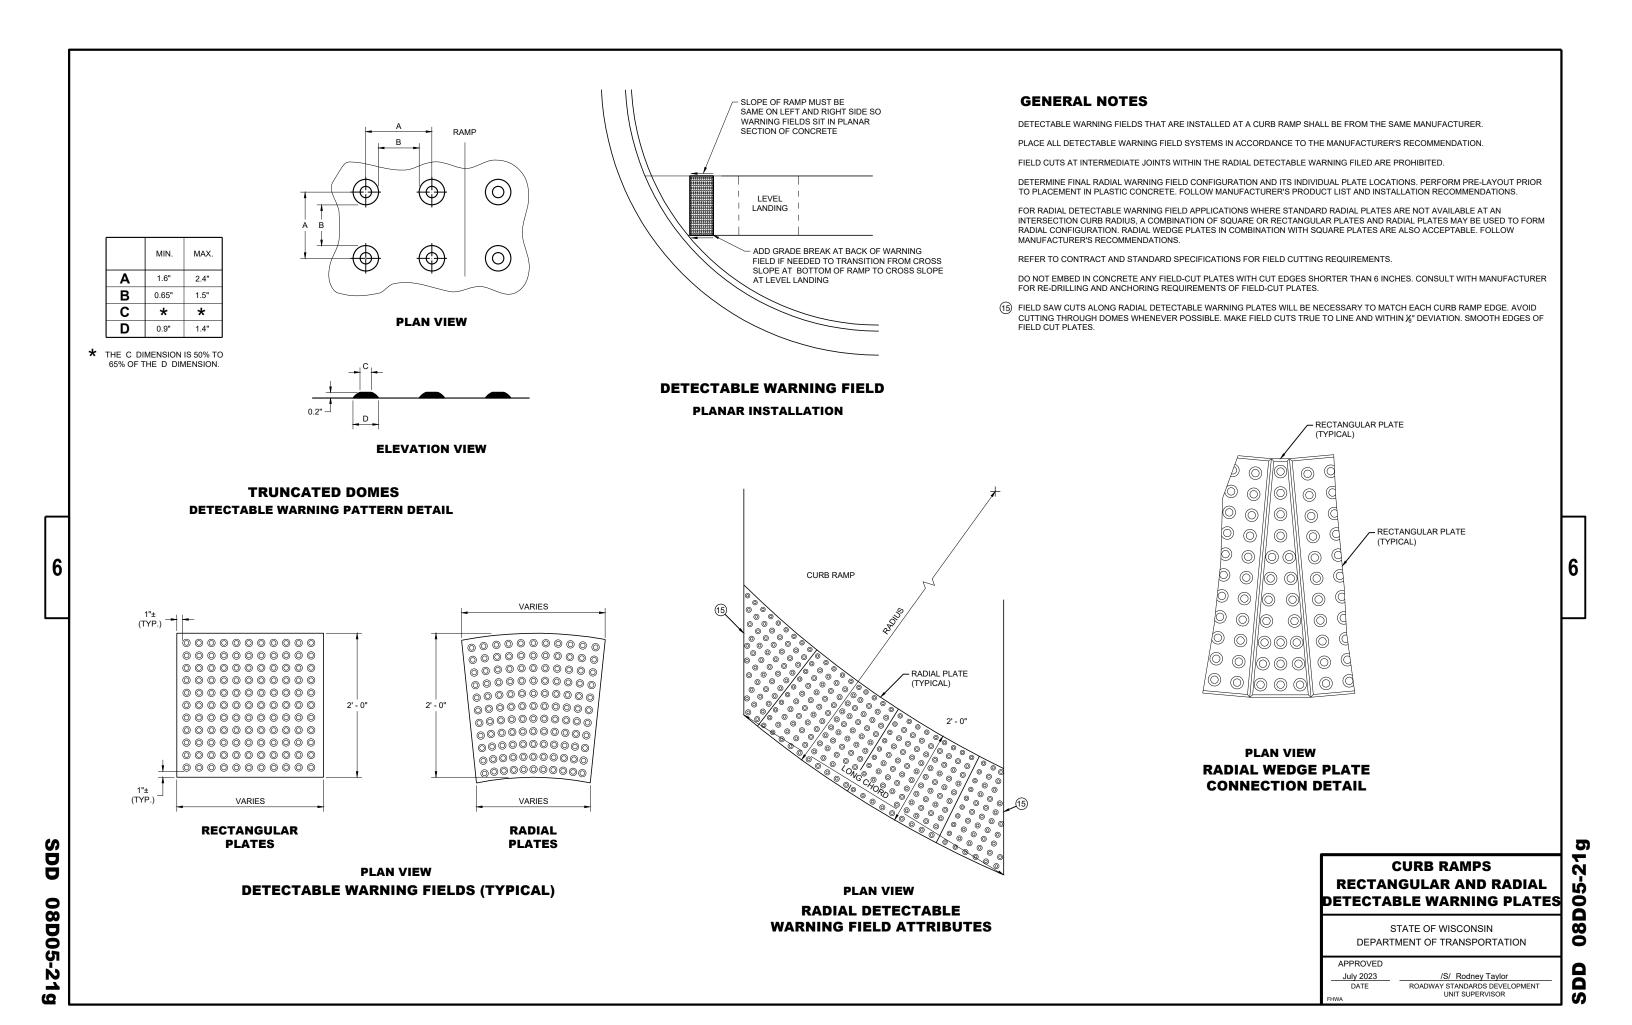
08D0


STATE OF WISCONSIN DEPARTMENT OF TRANSPORTATION




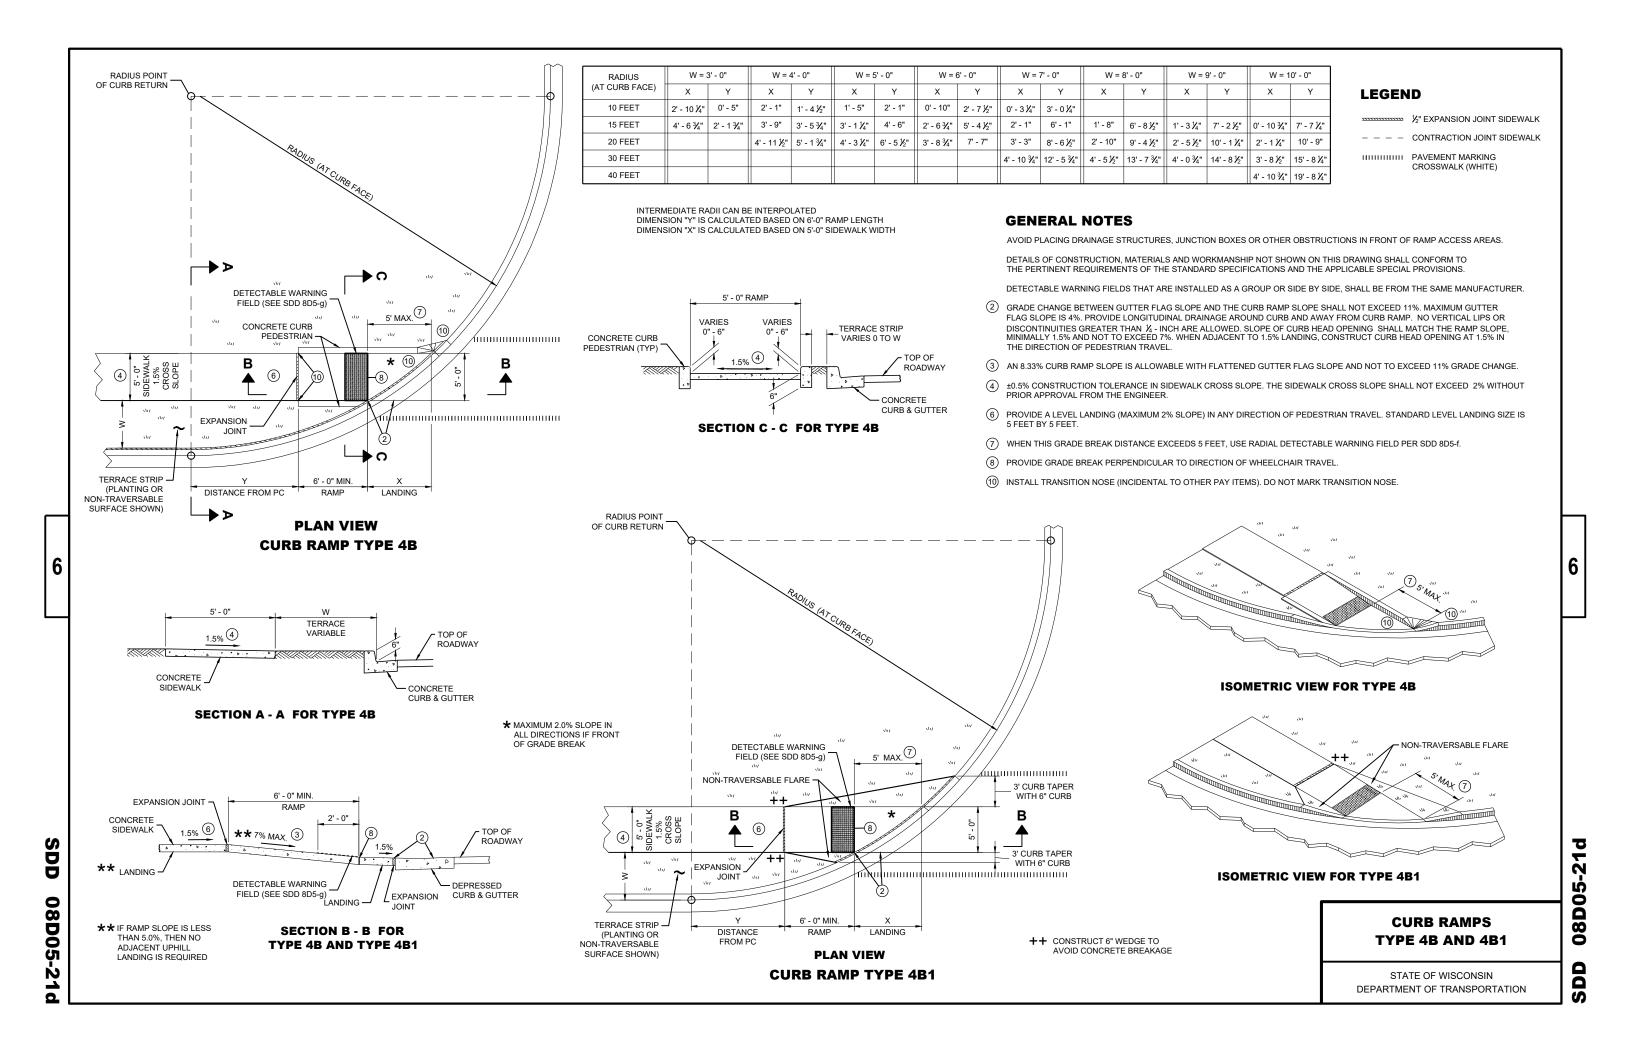

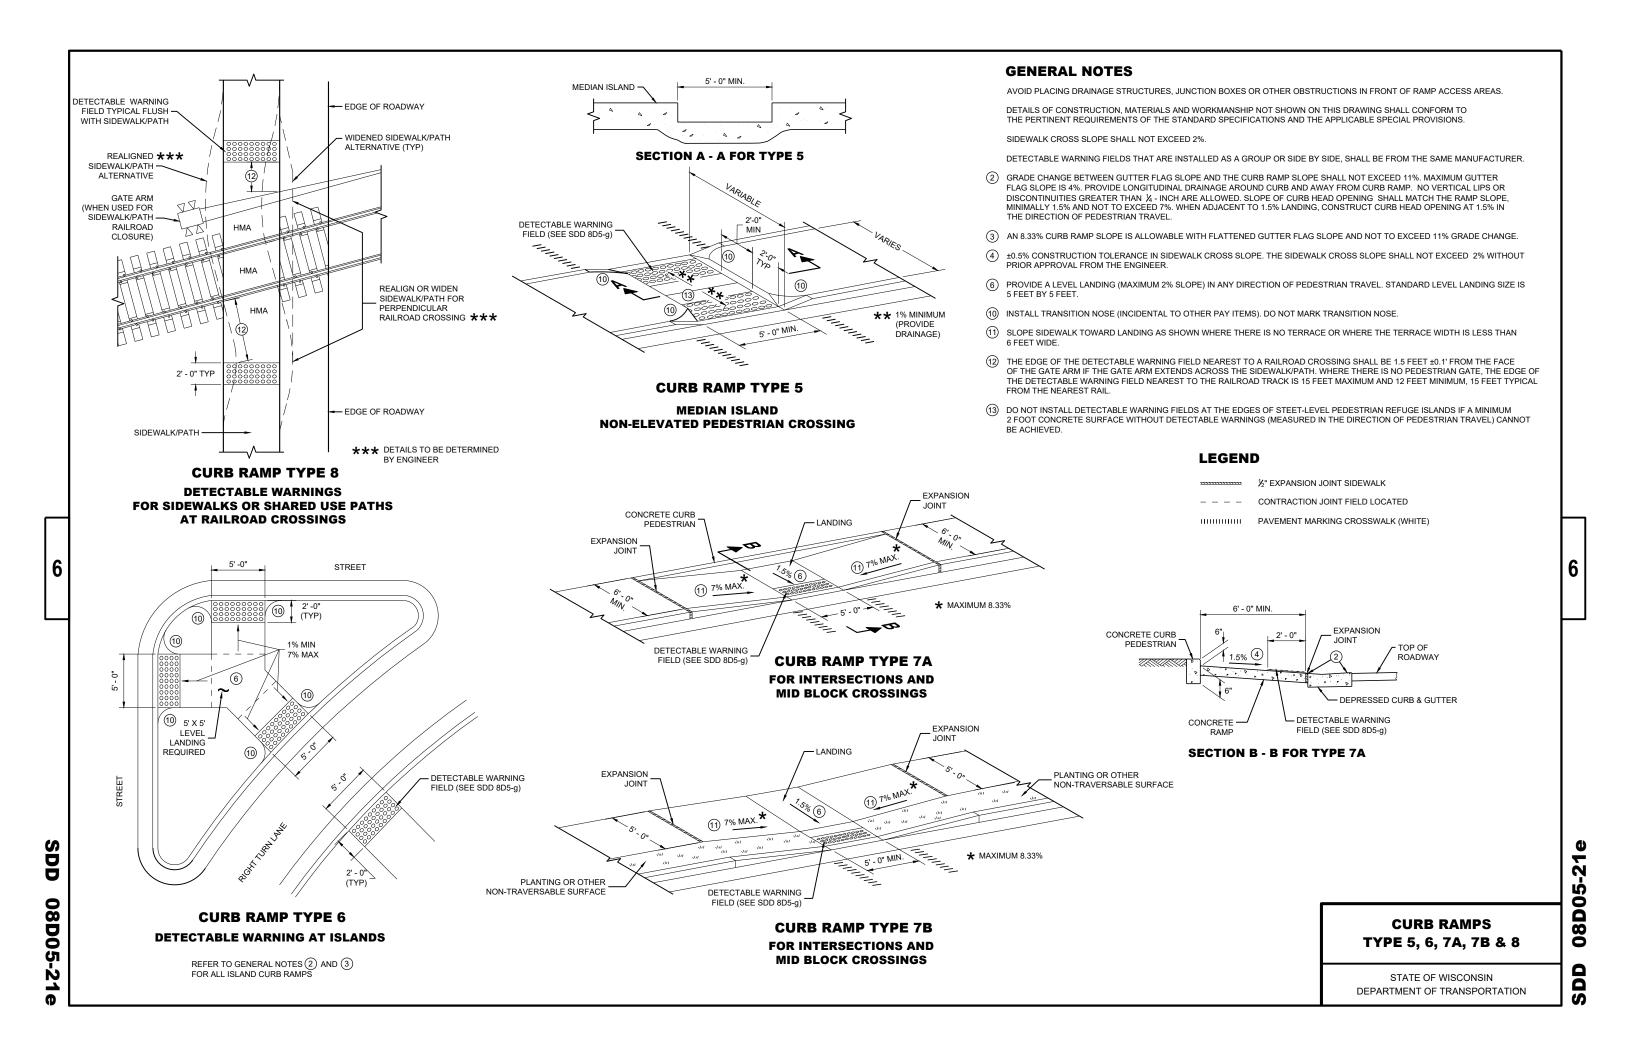

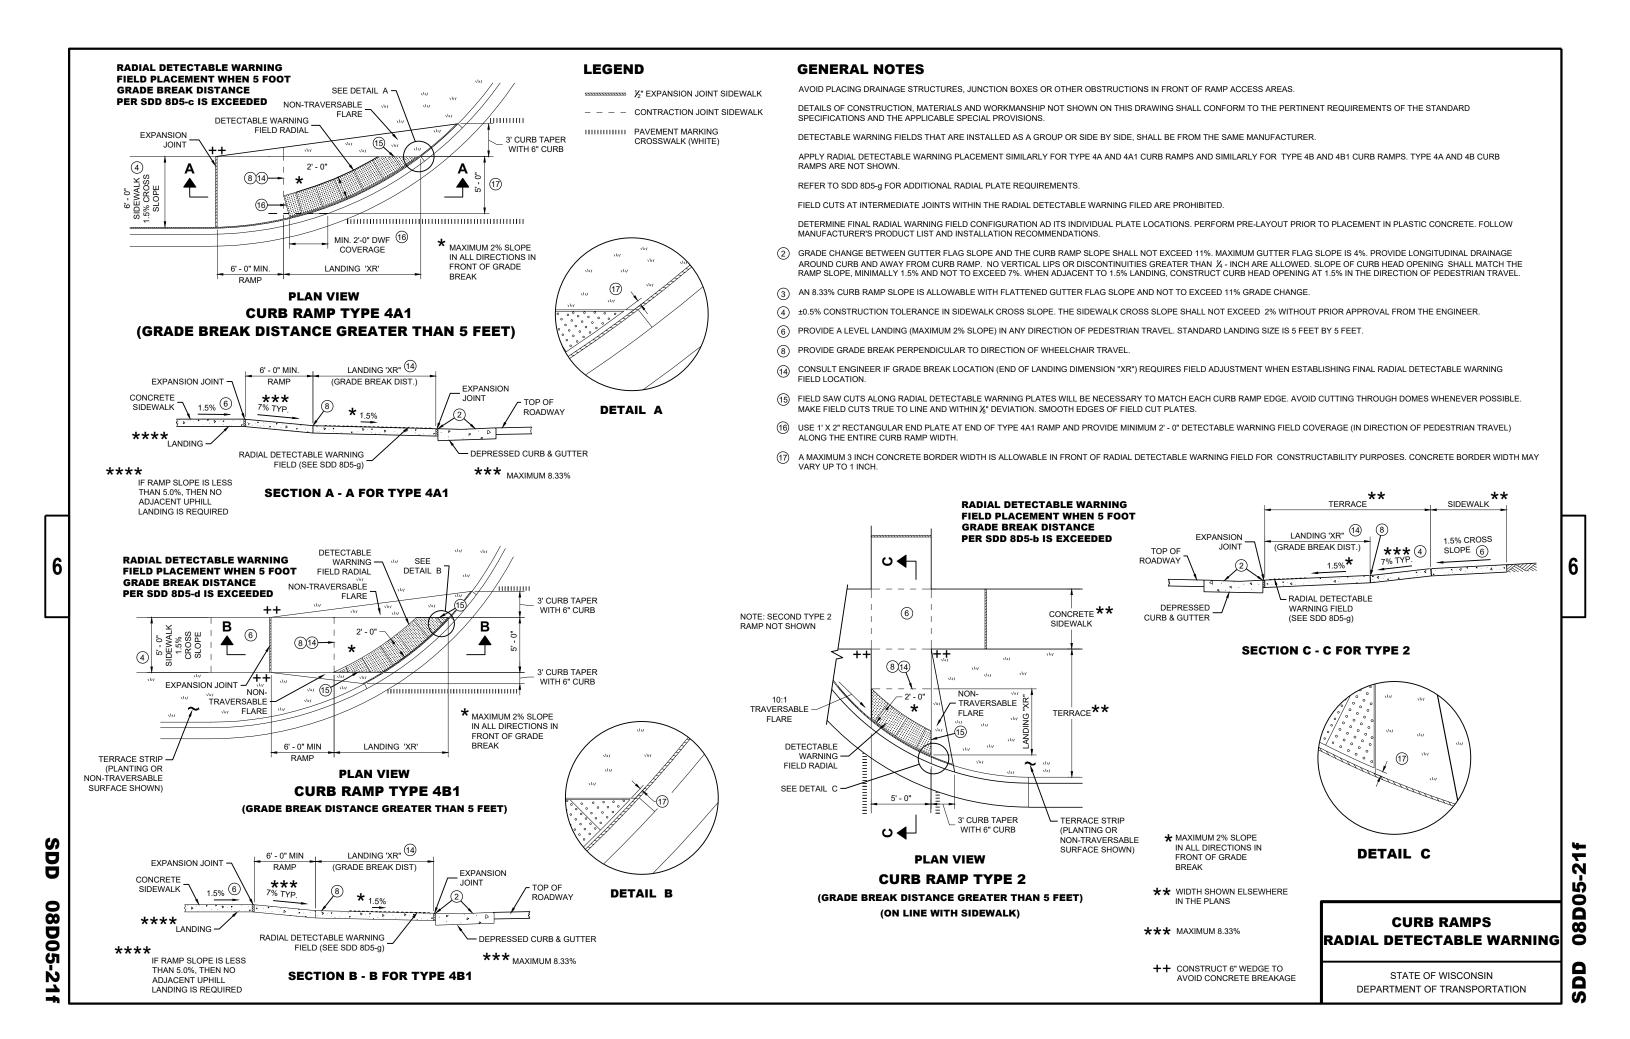

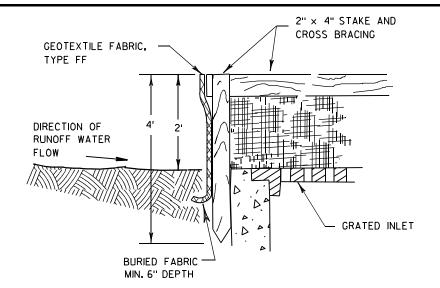

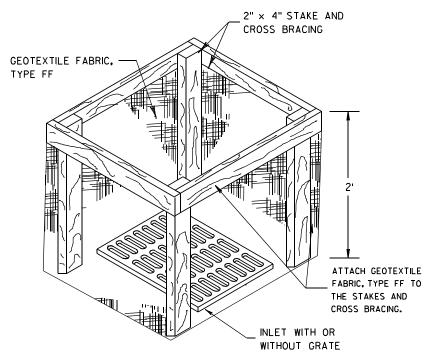

INLET PROTECTION, TYPE A


GENERAL NOTES

INLET PROTECTION DEVICES SHALL BE MAINTAINED OR REPLACED AT THE DIRECTION OF THE ENGINEER.

MANUFACTURED ALTERNATIVES APPROVED AND LISTED ON THE DEPARTMENT'S EROSION CONTROL PRODUCT ACCEPTABILITY LIST MAY BE

WHEN REMOVING OR MAINTAINING INLET PROTECTION, CARE SHALL BE TAKEN SO THAT THE SEDIMENT TRAPPED ON THE GEOTEXTILE FABRIC DOES NOT FALL INTO THE INLET. ANY MATERIAL FALLING INTO THE INLET SHALL BE REMOVED IMMEDIATELY.

- 1) FINISHED SIZE, INCLUDING FLAP POCKETS WHERE REQUIRED, SHALL EXTEND A MINIMUM OF 10" AROUND THE PERIMETER TO FACILITATE MAINTENANCE OR REMOVAL.
- (2) FOR INLET PROTECTION, TYPE C (WITH CURB BOX), AN ADDITIONAL 18" OF FABRIC IS WRAPPED AROUND THE WOOD AND SECURED WITH STAPLES. THE WOOD SHALL NOT BLOCK THE ENTIRE HEIGHT OF THE CURB BOX OPENING.
- (3) FLAP POCKETS SHALL BE LARGE ENOUGH TO ACCEPT WOOD 2X4.

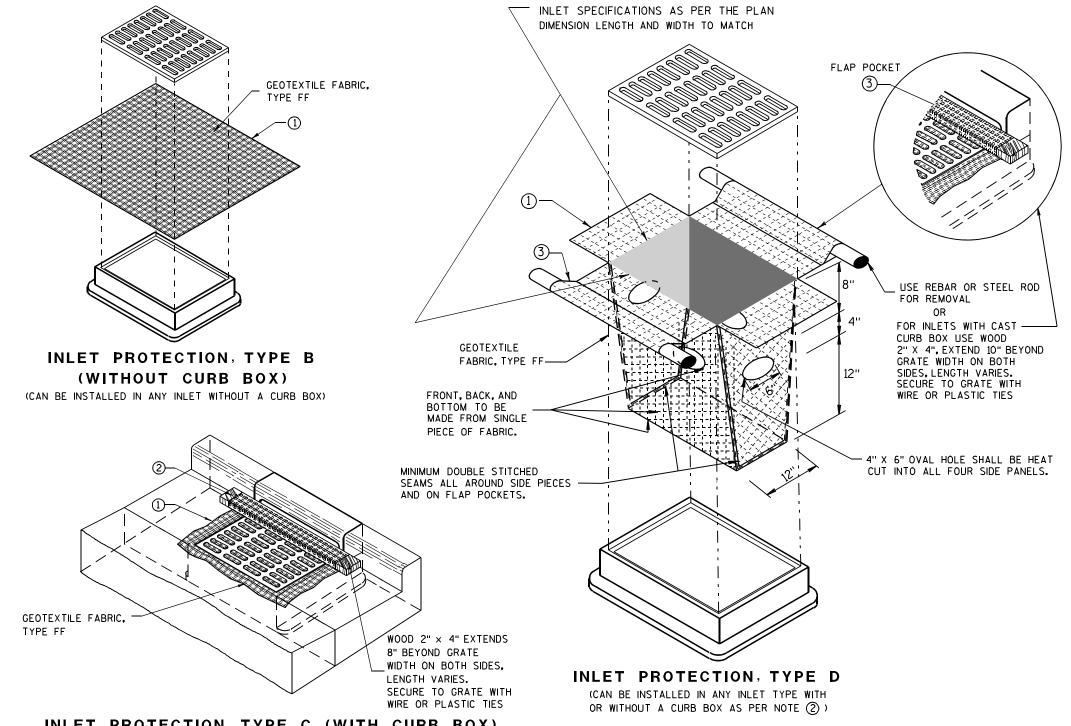

INLET PROTECTION, TYPE C (WITH CURB BOX)

INSTALLATION NOTES

TYPE B & C

TRIM EXCESS FABRIC IN THE FLOW LINE TO WITHIN 3" OF THE GRATE.

THE CONTRACTOR SHALL DEMONSTRATE A METHOD OF MAINTENANCE, USING A SEWN FLAP, HAND HOLDS OR OTHER METHOD TO PREVENT ACCUMULATED SEDIMENT FROM ENTERING THE INLET.

TYPE D

DO NOT INSTALL INLET PROTECTION TYPE D IN INLETS SHALLOWER THAN 30", MEASURED FROM THE BOTTOM OF THE INLET TO THE TOP OF THE GRATE.

TRIM EXCESS FABRIC IN THE FLOW LINE TO WITHIN 3" OF THE GRATE.

THE INSTALLED BAG SHALL HAVE A MINIMUM SIDE CLEARANCE, BETWEEN THE INLET WALLS AND THE BAG, MEASURED AT THE BOTTOM OF THE OVERFLOW HOLES, OF 3". WHERE NECESSARY THE CONTRACTOR SHALL CINCH THE BAG, USING PLASTIC ZIP TIES, TO ACHIEVE THE 3" CLEARANCE, THE TIES SHALL BE PLACED AT A MAXIMUM OF 4" FROM THE BOTTOM OF THE BAG.

INLET PROTECTION TYPE A, B, C, AND D

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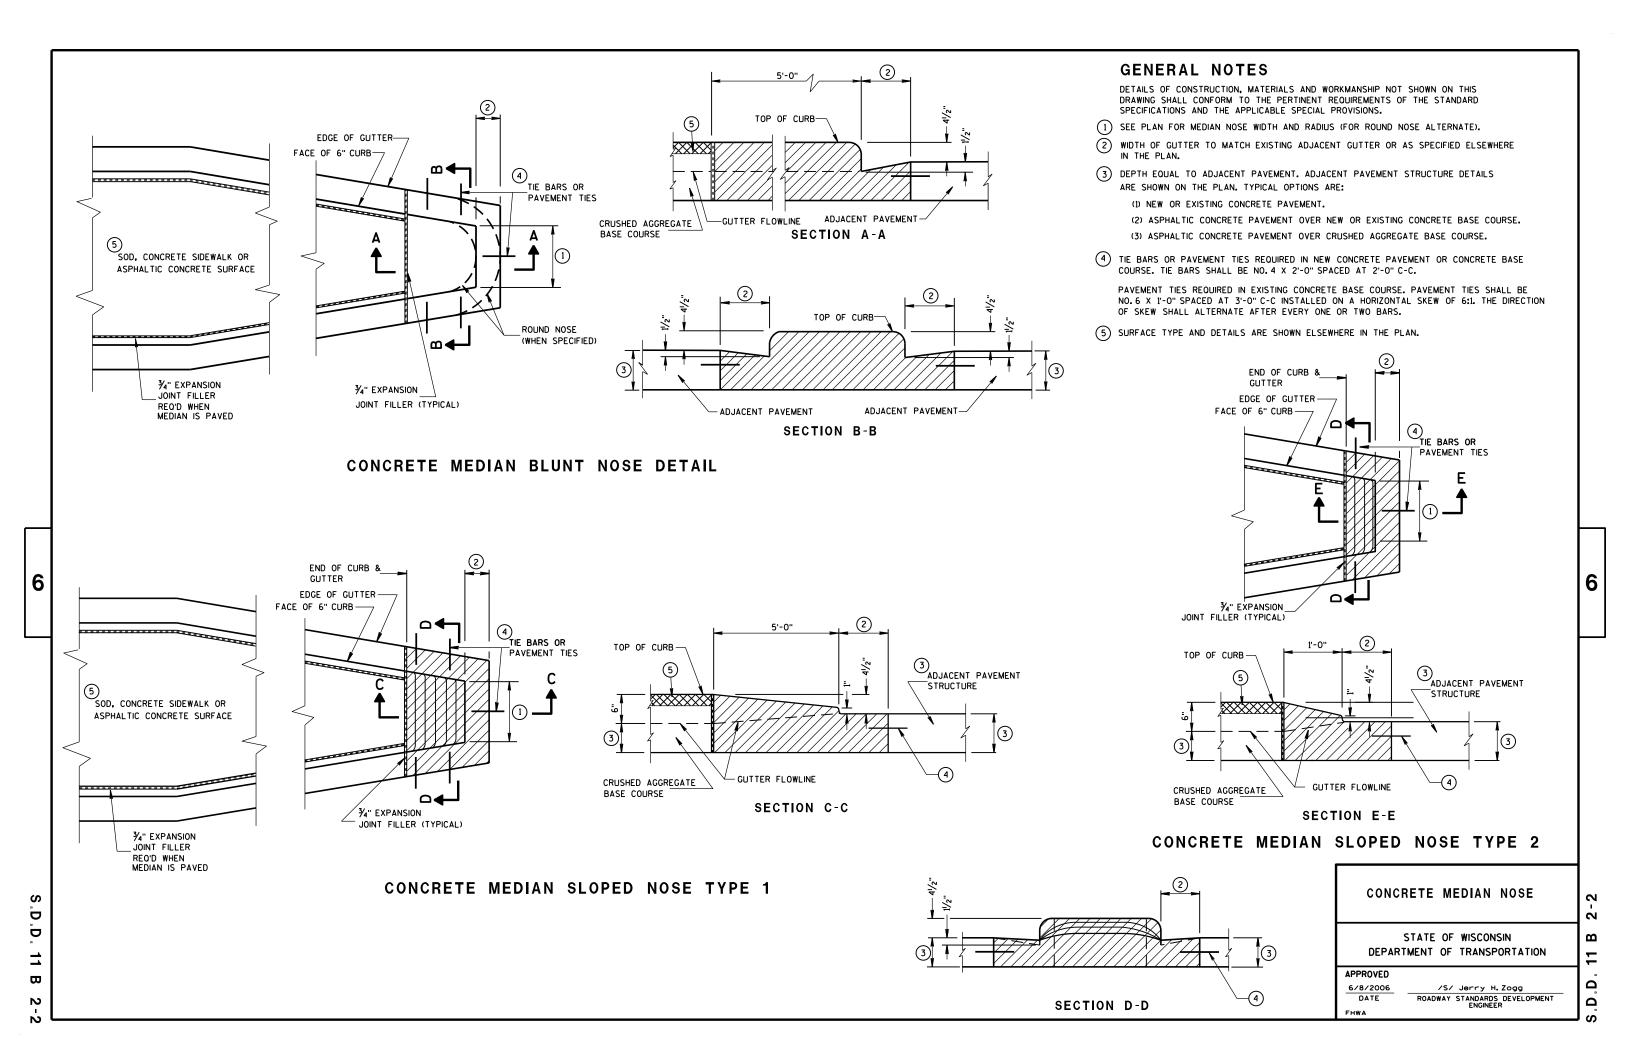
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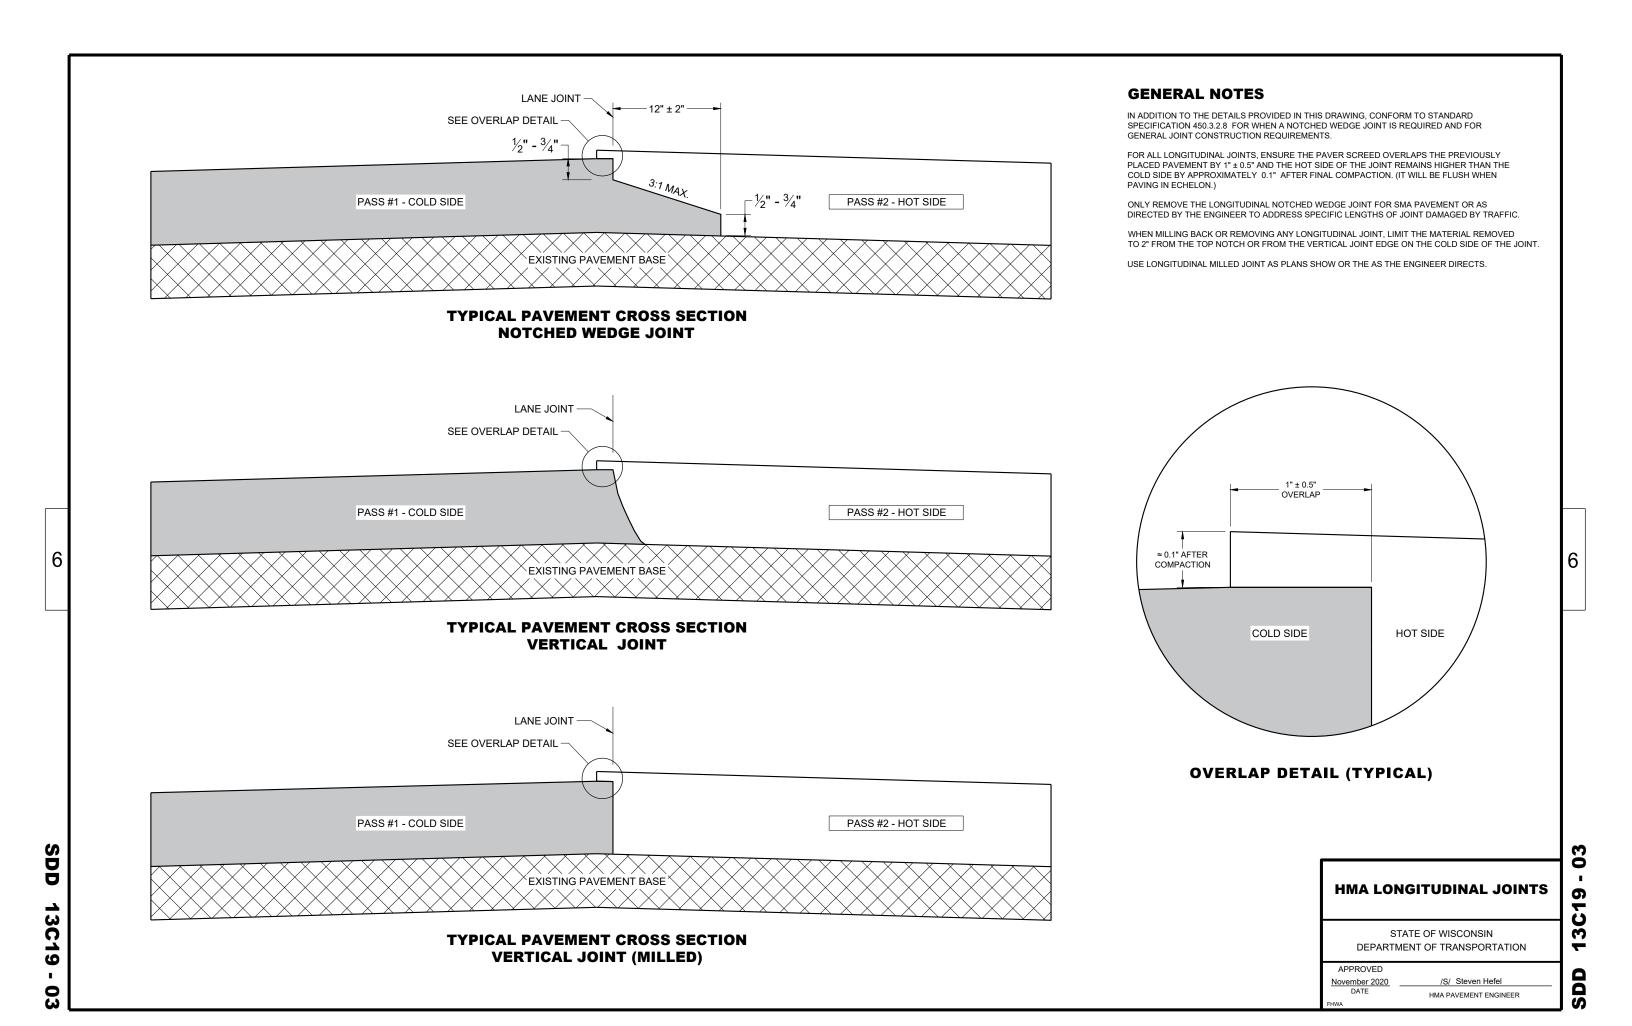
STATE OF WISCONSIN DEPARTMENT OF TRANSPORTATION


APPROVED


/S/ Beth Cannestra CHIEF ROADWAY DEVELOPMENT ENGINEER

10/16/02






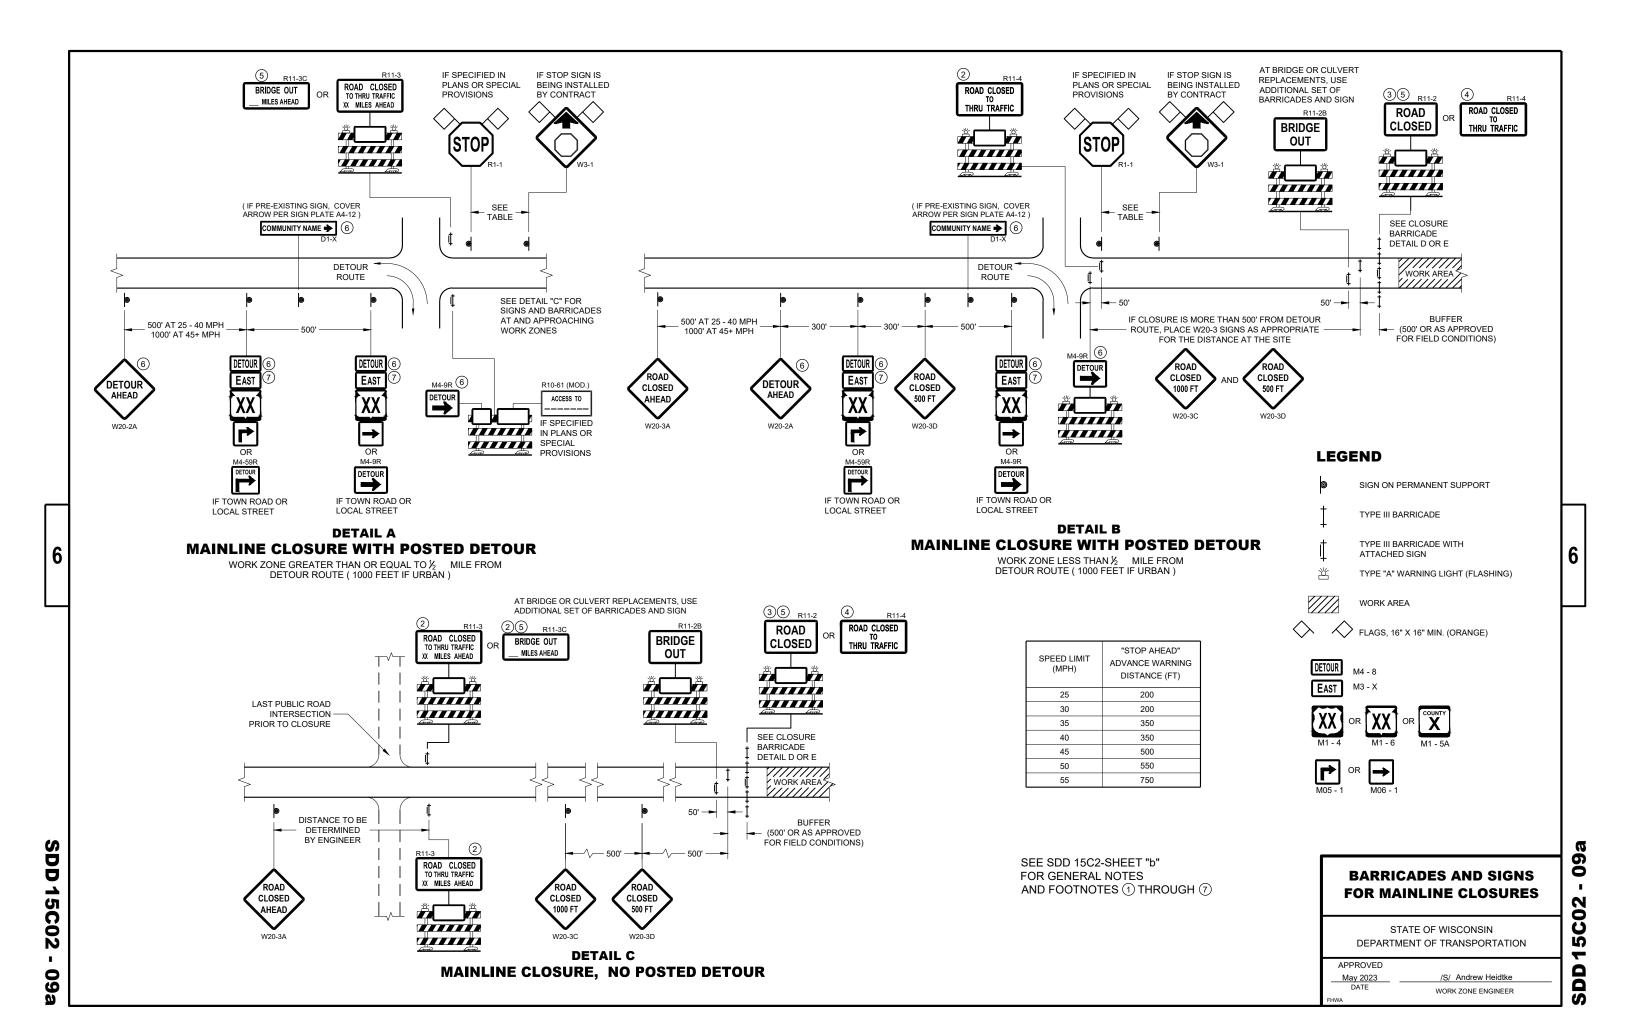

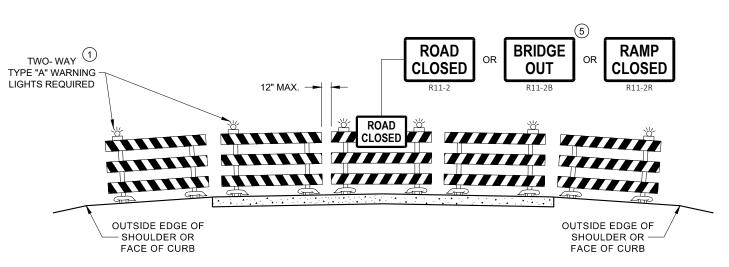

DETAIL D ROAD CLOSURE BARRICADE DETAIL APPROACH VIEW

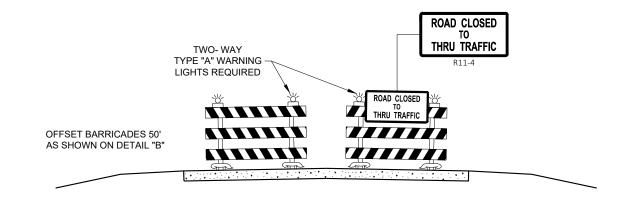

DETAIL E LANE CLOSURE BARRICADE DETAIL **APPROACH VIEW**

SEE SDD 15C2 - SHEET "a" FOR LEGEND

GENERAL NOTES

THE EXACT NUMBER, LOCATION, AND SPACING OF ALL SIGNS AND BARRICADES SHALL BE ADJUSTED TO FIT FIELD CONDITIONS AS APPROVED BY THE ENGINEER.

ANY SIGNS TEMPORARY OR EXISTING, WHICH CONFLICT WITH TRAFFIC CONTROL "IN USE", SHALL BE REMOVED OR COVERED AS NEEDED AND AS APPROVED BY THE ENGINEER.

THE SPACING BETWEEN TRAFFIC CONTROL SIGNS SHOULD BE ADJUSTED TO NOT CONFLICT WITH AND SHOULD PROVIDE A DESIRABLE MINIMUM OF 200 FEET CLEARANCE TO EXISTING SIGNS THAT WILL REMAIN IN PLACE.

BARRICADES THAT MUST BE MOVED FOR A WORK OPERATION SHALL BE IMMEDIATELY RE-ESTABLISHED UPON COMPLETION OF THE OPERATION, OR FOR CONTINUING OPERATIONS, AT THE END OF EACH WORKING DAY.

SIGNS THAT WILL BE IN PLACE LESS THAN 7 CONTINUOUS DAYS AND NIGHTS MAY BE MOUNTED ON PORTABLE

ALL TYPE III BARRICADES SHALL HAVE RAILS REFLECTORIZED ON BOTH FACES. STRIPES SHALL BE PROPERLY SLOPED DOWN TOWARD THE TRAFFIC SIDE OR AS SHOWN IN THE ROAD CLOSURE BARRICADE DETAIL "D" FOR FULL ROAD CLOSURES.

TYPE "A" LOW - INTENSITY FLASHING WARNING LIGHTS SHALL BE VISIBLE ON BOTH SIDES OF THE BARRICADE.

THE R11 - 2. R11 - 3. M4 - 9. R11 - 4. AND R10 - 61 SIGNS PLACED ON THE BARRICADES SHALL COVER NO MORE THAN THE TOP RAIL. THE SIGNS SHALL NOT COVER ANY PORTION OF THE MIDDLE RAIL OR BOTTOM RAILS.

"WO" AND "MO" SIGNS ARE THE SAME AS "W" AND "M" SIGNS EXCEPT THE BACKGROUND IS ORANGE.

ALL SIGNS SHALL BE 48" X 48" UNLESS OTHERWISE NOTED BELOW:

R11 - 2 SHALL BE 48" X 30"

R11 - 3 SHALL, R11 - 4 AND R10 - 61 SHALL BE 60 " X 30"

M4 - 9 SHALL BE 30" X 24"

M3 - X SHALL BE 24" X 12" (36" X 18" IF NEEDED TO MATCH EXISTING SIGNS)

M4 - 8 SHALL BE 24" X 12" (36" X 18" IF NEEDED TO MATCH EXISTING SIGNS)

M1 - 4, M1 - 5A AND M1 - 6 SHALL BE 24" X 24" (36" X 36" IF NEEDED TO MATCH EXISTING SIGNS)

MO5 - 1 AND MO6 - 1 SHALL BE 21" X 21" (30" X 30" IF NEEDED TO MATCH EXISTING SIGNS) D1 - X SHALL BE AS SHOWN ON SPECIFIC PROJECT SIGNING DETAIL SHEETS.

R1 - 1 SHALL BE 36" X 36"


- TWO WARNING LIGHTS SHALL BE PROVIDED ON THE CENTER BARRICADE AND A MINIMUM OF ONE WARNING LIGHT SHALL BE PROVIDED ON EACH OF THE OTHER BARRICADES WITHIN THE ROADWAY LIMITS. SPACING OF THE WARNING LIGHTS SHALL BE UNIFORM TO THE EDGE OF ROADWAY AS SHOWN (APPROX. 8 FOOT LIGHT **SPACING**
- THESE SIGNS AND BARRICADES ARE NOT REQUIRED IF ROAD CLOSURE BEGINS AT AN INTERSECTION.
- (3) FOR ROAD CLOSURE <u>WITHOUT</u> LOCAL ACCESS TO PROJECT, SEE ROAD CLOSURE BARRICADE DETAIL "D".
- (4) FOR ROAD CLOSURE WITH LOCAL ACCESS TO PROJECT, SEE ROAD CLOSURE BARRICADE DETAIL "E".
- (5) FOR BRIDGE OR CULVERT REPLACEMENTS, SUBSTITUTE "BRIDGE OUT" INSTEAD OF "ROAD CLOSED" ON R11 - 2 AND R11 - 3 SIGNS.
- (6) INSTALL DETOUR AND COMMUNITY GUIDE SIGNS AND ARROWS ONLY IF SPECIFIED IN THE CONTRACT. IF THERE ARE EXISTING ROUTE MARKER ASSEMBLIES THAT WILL REMAIN IN PLACE, ADJUST THE LOCATION OF THE DETOUR ROUTE SIGNS TO CORRESPOND WITH THE EXISTING ASSEMBLIES. MODIFY EXISTING SIGNS WHERE POSSIBLE. SEE SPECIFIC PROJECT DETOUR SIGNING DETAIL SHEETS. IF DETOUR SIGNS ARE BEING INSTALLED BY OTHERS. PLACE THE CONTRACTED TRAFFIC CONTROL SIGNS TO ALLOW FOR PLACEMENT OF ALL WARNING, DETOUR AND GUIDE
- "EAST" CARDINAL DIRECTION MARKERS AND RIGHT TURN ARROWS ARE SHOWN. USE OTHER CARDINAL DIRECTIONS AND ARROWS AS APPROPRIATE.

BARRICADES AND SIGNS FOR **VARIOUS CLOSURES**

STATE OF WISCONSIN DEPARTMENT OF TRANSPORTATION


APPROVED May 2023 DATE WORK ZONE ENGINEER

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SDD 15C02-09h

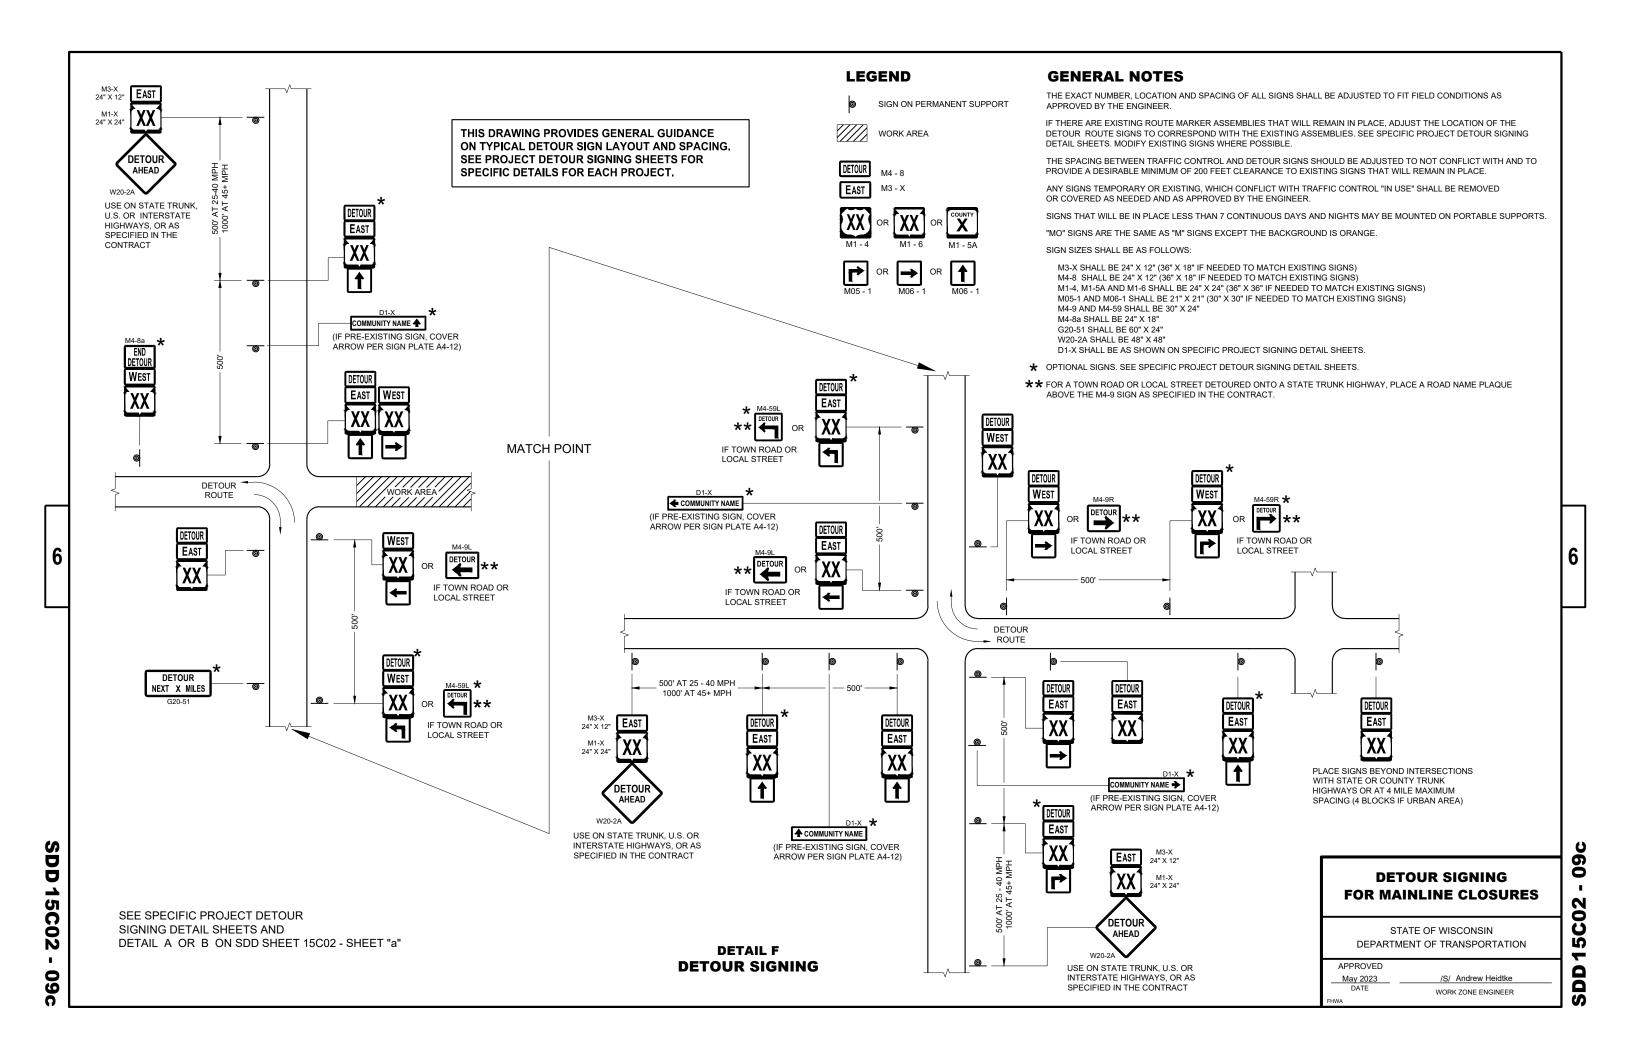

GENERAL NOTES

CELLS OF CORRUGATED PLASTIC SHALL BE VERTICALLY ORIENTED.

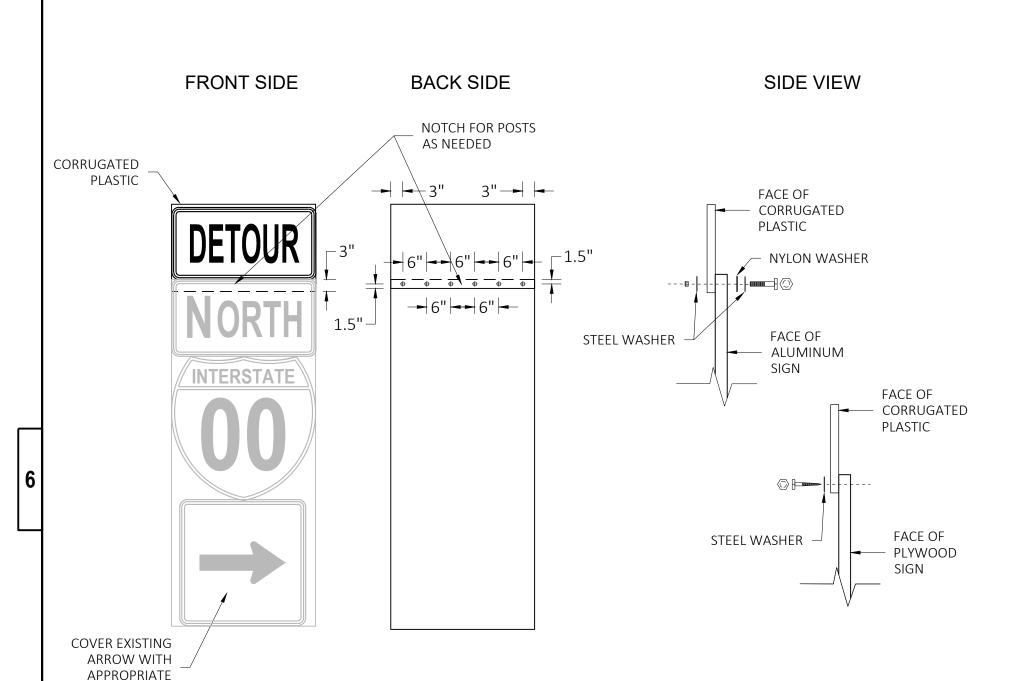PROVIDE A 0.4-INCH THICK BASE CORRUGATED PLASTIC WITH A 0.035-INCH WALL THICKNESS AND 0.4-INCH CELL SIZE.

FOR 36" WIDE SIGNS: USE 6 FASTENERS AS SHOWN.

FOR 24" WIDE SIGNS: USE 4 FASTENERS WITH EDGE SPACING AS SHOWN AND 6" SPACING BETWEEN FASTENERS.

METAL WASHERS, NUTS, BOLTS AND LAGS SHALL HAVE HEXAGONAL HEADS AND SHALL BE EITHER:

- A. HOT DIP GALVANIZED IN ACCORDANCE WITH ASTM DESIGNATION: A 153, CLASS D, OR SC 3.
- B. ELECTRO-GALVANIZED IN ACCORDANCE WITH ASTM DESIGNATION: B 633, TYPE III, SC3

THREADS ON BOLTS AND NUTS SHALL BE MANUFACTURED WITH SUFFICIENT ALLOWANCE FOR THE CADMIUM PLATE OR GALVANIZED COATING TO PERMIT THE NUTS TO RUN FREELY ON THE BOLTS.

PLYWOOD SIGNS:

LAG SCREWS - 5/16" x 1"

ALUMINUM SIGNS:

MACHINE BOLTS - 5/16" x 1-1/4" LENGTH W/NUTS

WASHERS:

1-1/4" O.D. x 3/8" I.D. x 1/16" STEEL 1-1/4" O.D. x 3/8" I.D. x .080 NYLON

MODIFIED ROUTE ASSEMBLY FOR DETOUR SIGNING

MODIFIED ROUTE ASSEMBLY FOR DETOUR SIGNING

STATE OF WISCONSIN
DEPARTMENT OF TRANSPORTATION


APPROVED

May 2023 /S/ Andrew Heidtke

DATE ROADWAY STANDARDS DEVELOPMENT
ENGINEER

D 15C02-09h

DETOUR ARROW

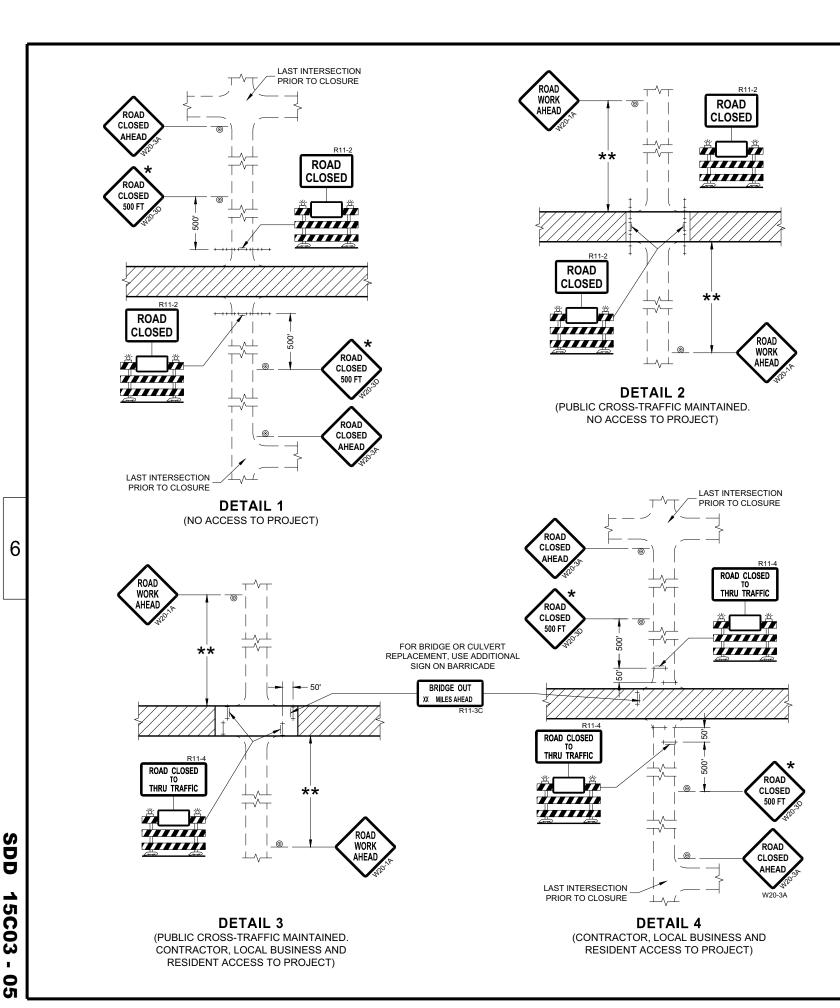

GENERAL NOTES

THE EXACT NUMBER, LOCATION, AND SPACING OF ALL SIGNS AND BARRICADES SHALL BE ADJUSTED TO FIT FIELD CONDITIONS

ANY SIGNS TEMPORARY OR EXISTING, WHICH CONFLICT WITH TRAFFIC CONTROL "IN USE" SHALL BE REMOVED OR COVERED AS NEEDED AND AS APPROVED BY THE ENGINEER.

THE SPACING BETWEEN TRAFFIC CONTROL SIGNS SHOULD BE ADJUSTED TO NOT CONFLICT WITH AND SHOULD PROVIDE A DESIRABLE MINIMUM OF 200 FEET CLEARANCE (500 FEET DESIRABLE) TO EXISTING SIGNS THAT WILL REMAIN IN PLACE.

IF A "STOP" SIGN MUST BE REMOVED FOR A WORK OPERATION, A TEMPORARY "STOP" SIGN SHALL BE PLACED PRIOR TO THE SIGN REMOVAL, OR A FLAGGER SHALL BE PROVIDED UNTIL THE SIGN IS REESTABLISHED.

BARRICADES THAT MUST BE MOVED FOR A WORK OPERATION SHALL BE IMMEDIATELY REESTABLISHED UPON COMPLETION OF THE OPERATION OR FOR CONTINUING OPERATIONS, AT THE END OF EACH WORKING DAY.

SIGNS THAT WILL BE IN PLACE LESS THAN SEVEN CONTINUOUS DAYS AND NIGHTS MAY BE MOUNTED ON PORTABLE SUPPORTS.

ALL TYPE III BARRICADES SHALL HAVE RAILS REFLECTORIZED ON BOTH FACES. STRIPES SHALL BE PROPERLY SLOPED DOWN TOWARD THE TRAFFIC SIDE OR AS SHOWN IN THE ROAD CLOSURE BARRICADE DETAIL "D" FOR FULL ROAD CLOSURES.

TYPE "A" LOW-INTENSITY FLASHING WARNING LIGHTS SHALL BE VISIBLE ON BOTH SIDES OF THE BARRICADE.

THE R11-2, R11-3, AND R11-4 SIGNS PLACED ON BARRICADES SHALL COVER NO MORE THAN THE TOP RAIL. THE SIGNS SHALL NOT COVER ANY PORTION OF THE MIDDLE OR BOTTOM RAILS.

ALL SIGNS SHALL BE 48" X 48" UNLESS OTHERWISE NOTED BELOW: R11-2 SHALL BE 48" X 30". R11-4 AND R11-3 SHALL BE 60" X 30".

- ★ OMIT THE "ROAD CLOSED 500 FT." SIGN IF THE LAST INTERSECTION IS 500 FEET OR LESS FROM THE WORK ZONE.
- ** 500' MAX. OR AT LAST INTERSECTION, WHICHEVER IS CLOSEST.

LEGEND

SIGN ON PERMANENT SUPPORT

TYPE III BARRICADE

TYPE III BARRICADE WITH ATTACHED SIGN

TYPE "A" WARNING LIGHT (FLASHING)

WORK AREA

BARRICADES AND SIGNS FOR **SIDEROAD CLOSURES**

STATE OF WISCONSIN DEPARTMENT OF TRANSPORTATION


APPROVED July 2018 DATE /S/ Andrew Heidtke WORK ZONE ENGINEER ŭ

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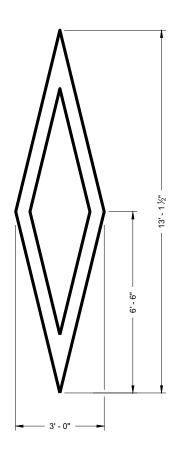
15a

GENERAL NOTES

DETAILS OF INSTALLATION, MATERIALS AND WORKMANSHIP NOT SHOWN ON THIS DRAWING SHALL CONFORM TO THE PERTINENT REQUIREMENTS OF THE STANDARD SPECIFICATIONS AND APPLICABLE SPECIAL PROVISIONS.

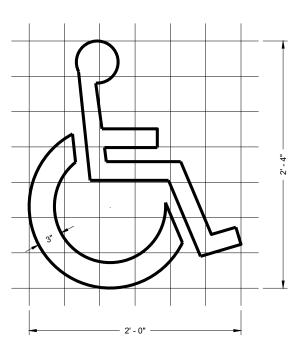

HANDICAP SYMBOL



PREFERENTIAL LANE SYMBOL


PAVEMENT MARKING SYMBOLS

STATE OF WISCONSIN DEPARTMENT OF TRANSPORTATION

APPROVED

November 2019 DATE /S/ Matthew Rauch
STATE SIGNING AND MARKING ENGINEER

SDD15C07

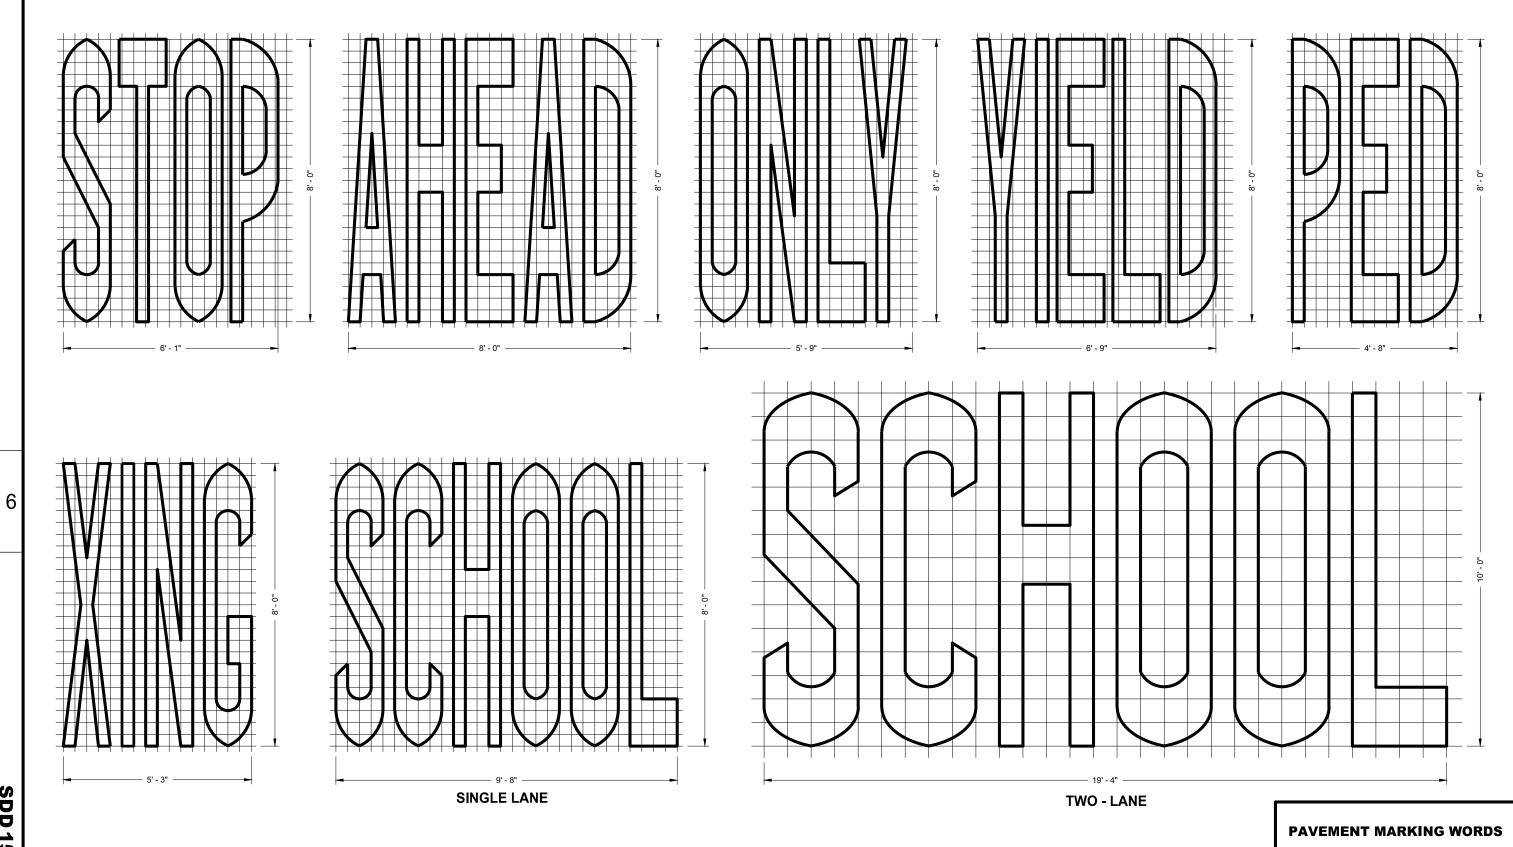

SDD 15C07 - 15b

GENERAL NOTES

DETAILS OF INSTALLATION, MATERIALS AND WORKMANSHIP NOT SHOWN ON THIS DRAWING SHALL CONFORM TO THE PERTINENT REQUIREMENTS OF THE STANDARD SPECIFICATIONS AND APPLICABLE SPECIAL PROVISIONS.

STATE OF WISCONSIN
DEPARTMENT OF TRANSPORTATION


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5b

SDD15C07

APPROVED


November 2019 /S/ Matthew Rauch
DATE STATE SIGNING AND MARKING
ENGINEER

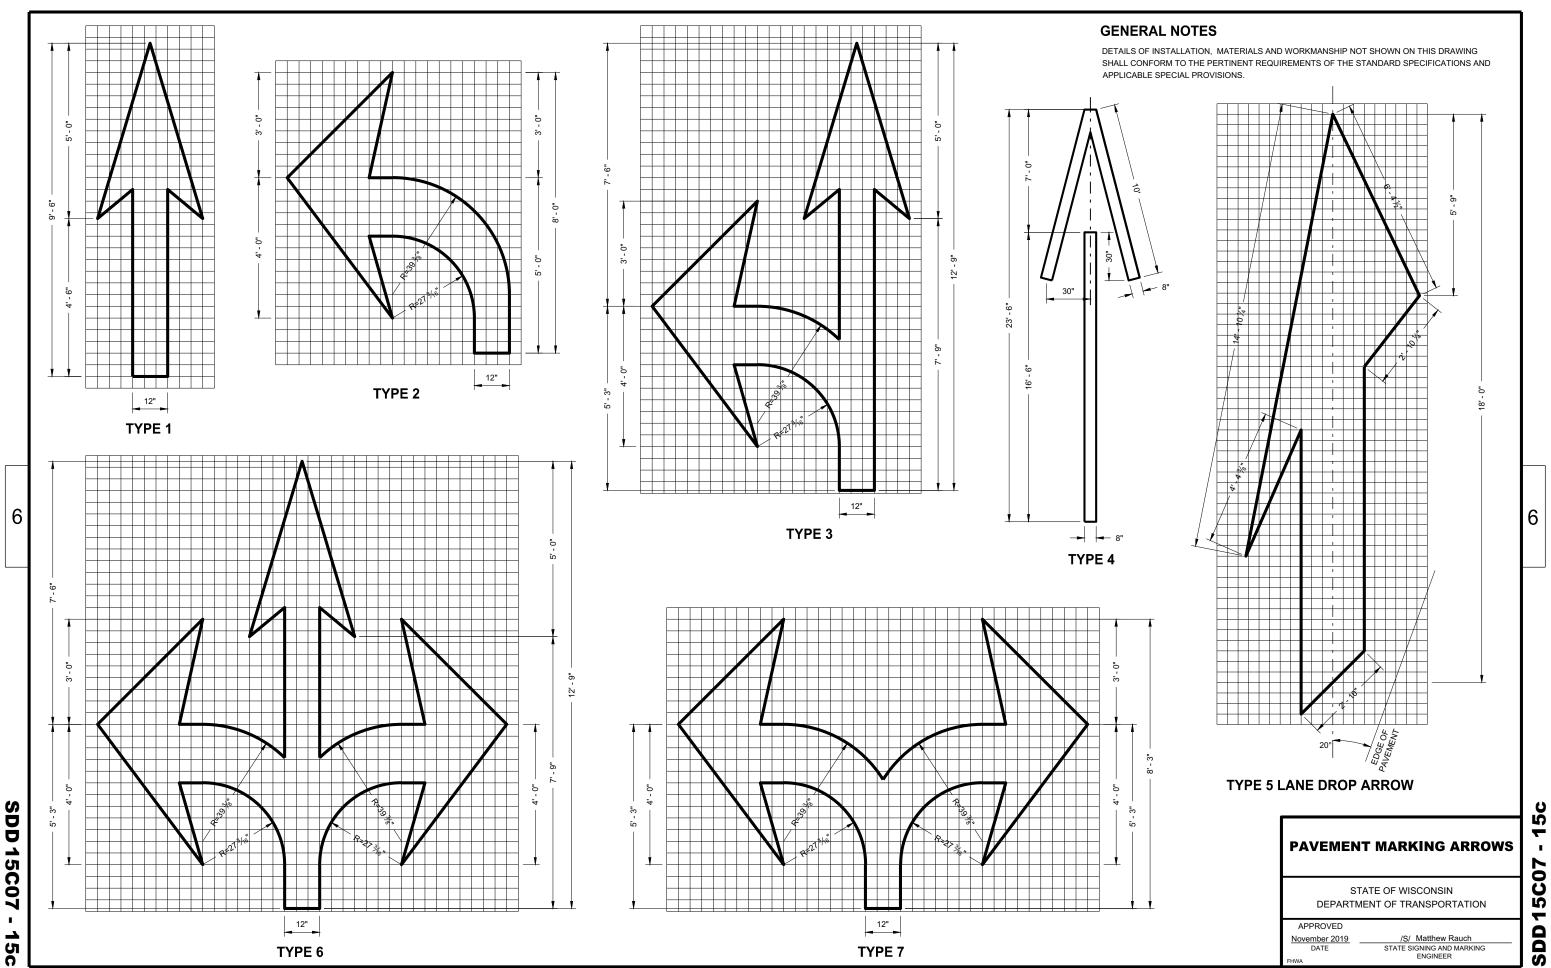

TYPE 7

TYPE 6

SDD

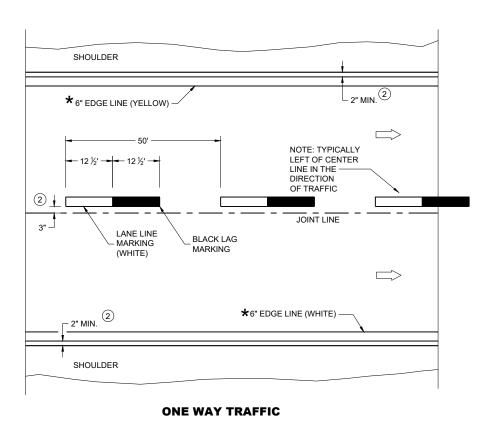

PERMANENT PAVEMENT MARKING

GENERAL NOTES

DETAILS OF CONSTRUCTION NOT SHOWN ON THIS DRAWING SHALL CONFORM TO STANDARD SPECIFICATIONS AND SPECIAL PROVISIONS.

- 1) LOCATE THE NO PASSING ZONE W14-3 SIGN WITHIN 50 FEET OF THE "T" MARKING
- (2) MEASURE FROM EDGE OF MARKING TO JOINT LINE. THIS DOES NOT INCLUDE SPACE NEEDED FOR GROOVING OPERATIONS.

LEGEND

"T" MARKING

SIGN ON PERMANENT SUPPORT

DIRECTION OF TRAFFIC

PERMANENT LONGITUDINAL **PAVEMENT MARKINGS**

STATE OF WISCONSIN DEPARTMENT OF TRANSPORTATION

May 2023 DATE


/S/ Jeannie Silver Statewide Pavement Marking Engineer

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SDD

C08-23 Ŋ SD


15C08-23a

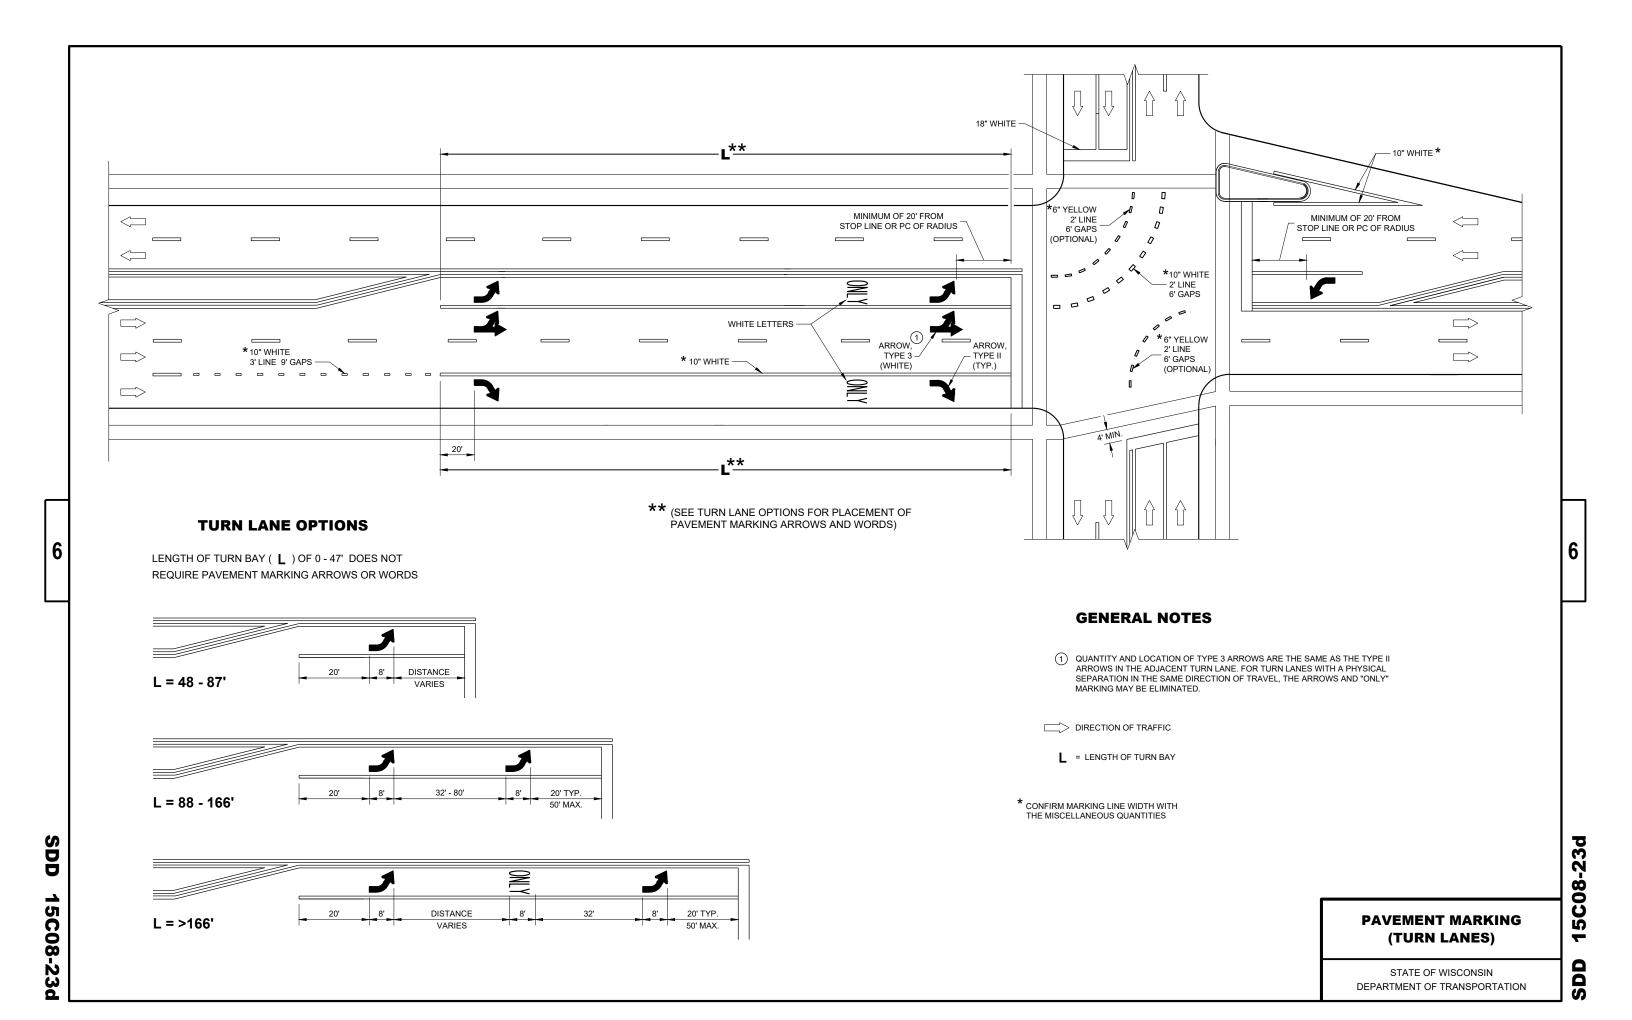

SDD 15C11


GENERAL NOTES

- (1) REFLECTIVE SHEETING SHALL FOLLOW THE REQUIREMENTS IN THE APPROVED PRODUCTS LISTING FOR SIGN SHEETING.
- (2) LOCATION OF WARNING LIGHTS WHEN SHOWN ON THE PLAN.

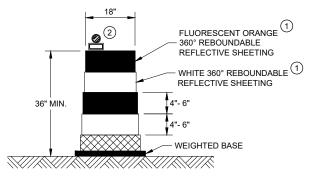


DRUM

BALLAST WIDTHS RANGE FROM 24"-36"

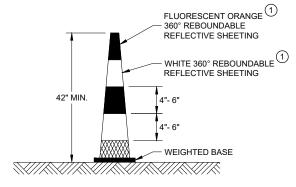


42" CONE

DO NOT USE IN TAPERS ½ SPACING OF DRUMS BALLAST WIDTHS RANGE FROM 14"-20"

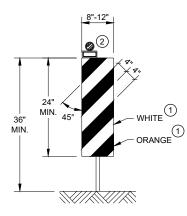


VERTICAL PANEL

THE STRIPES SHALL SLOPE DOWNWARD TO THE TRAFFIC SIDE FOR CHANNELIZATION.

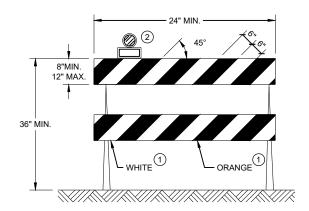

TYPE II BARRICADE

FOR RAILS LESS THAN 36" LONG, 4" WIDE STRIPES MAY BE USED. ALL STRIPES SHALL SLOPE DOWNWARD TO THE TRAFFIC SIDE FOR CHANNELIZATION.

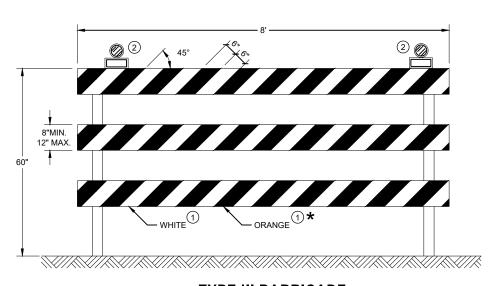

TYPE III BARRICADE

IF SIGN MOUNTED, DO NOT COVER MORE THAN 50% OF THE TOP TWO RAILS OR 33% OF THE TOTAL AREA OF THE THREE RAILS.

* IF USED FOR A PERMANENT APPLICATION USE RED SHEETING.


CHANNELIZING DEVICES DRUMS, CONES, BARRICADES AND VERTICAL PANELS

STATE OF WISCONSIN DEPARTMENT OF TRANSPORTATION 15C

APPROVED	
November 2022	/S/ Andrew Heidtke
DATE	WORK ZONE ENGINEER

CORRUGATED MEDIAN - MARKING, (YELLOW) -

MEDIAN ISLAND WITH ROUND BLUNT NOSE

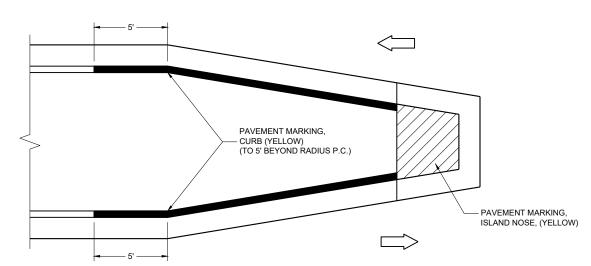

MEDIAN ISLAND WITH SLOPED NOSE

SDD


15C18-09b


TYPICAL PLACEMENT OF PAVEMENT MARKING ON MEDIAN ISLANDS

GENERAL NOTES

WHEN CONCRETE CORRUGATED MEDIAN IS CONSTRUCTED TO SEPARATE TRAFFIC OPERATING IN THE OPPOSING DIRECTION, YELLOW PAVEMENT MARKING SHALL BE APPLIED TO THE FLAT PORTION OF THE CONCRETE CORRUGATED MEDIAN. THE ITEM OF PAVEMENT MARKING, CONCRETE CORRUGATED MEDIAN, WILL BE MEASURED IN PLACE AND ACCEPTED IN ACCORDANCE WITH THE CONTRACT AND PAID FOR AT THE CONTRACT UNIT PRICE PER SQUARE FOOT.

 $\stackrel{\textstyle \frown}{}$ APPLY PAVEMENT MARKING TO THE FLAT PORTION OF CORRUGATED MEDIAN.

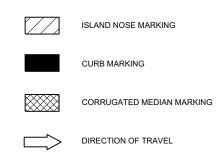

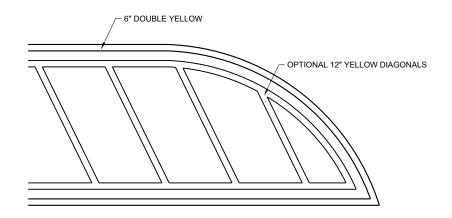

FLUSH MEDIAN ISLAND NOSE

PAVEMENT MARKINGS, MEDIAN ISLAND NOSE


STATE OF WISCONSIN
DEPARTMENT OF TRANSPORTATION


APPROVED August 2024

/S/ Jeannie Silver
Statewide Pavement Marking Engineer

DATE


DD 15C18-09k

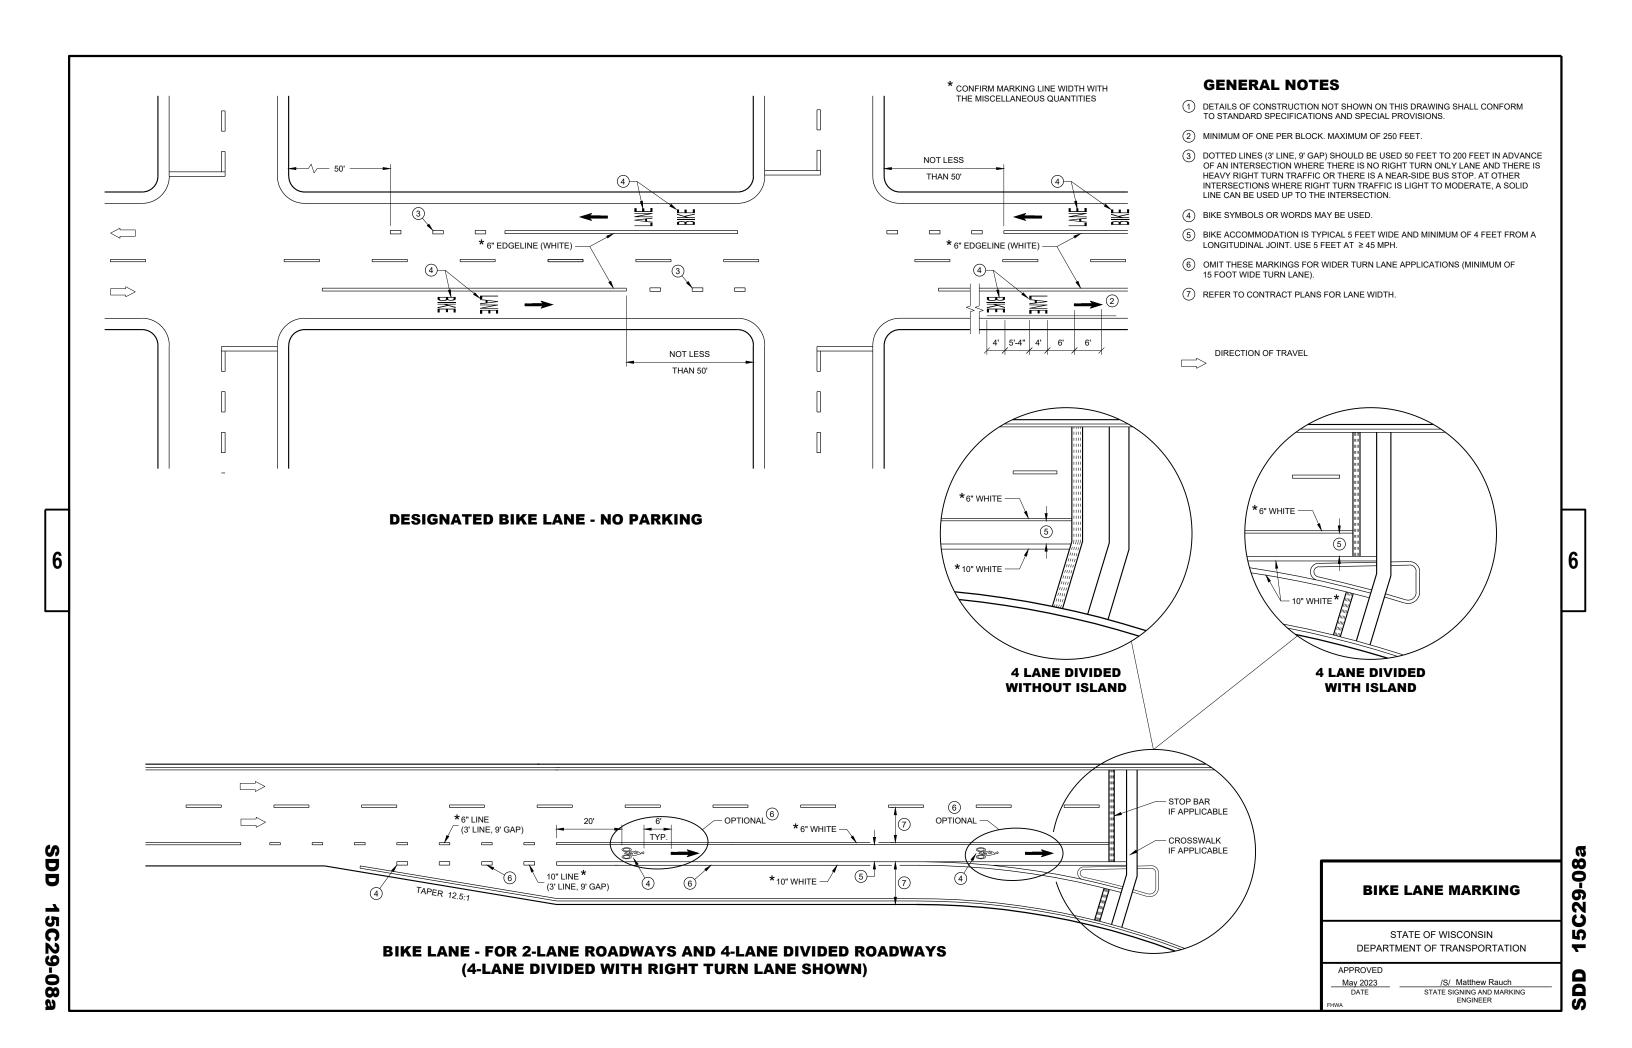

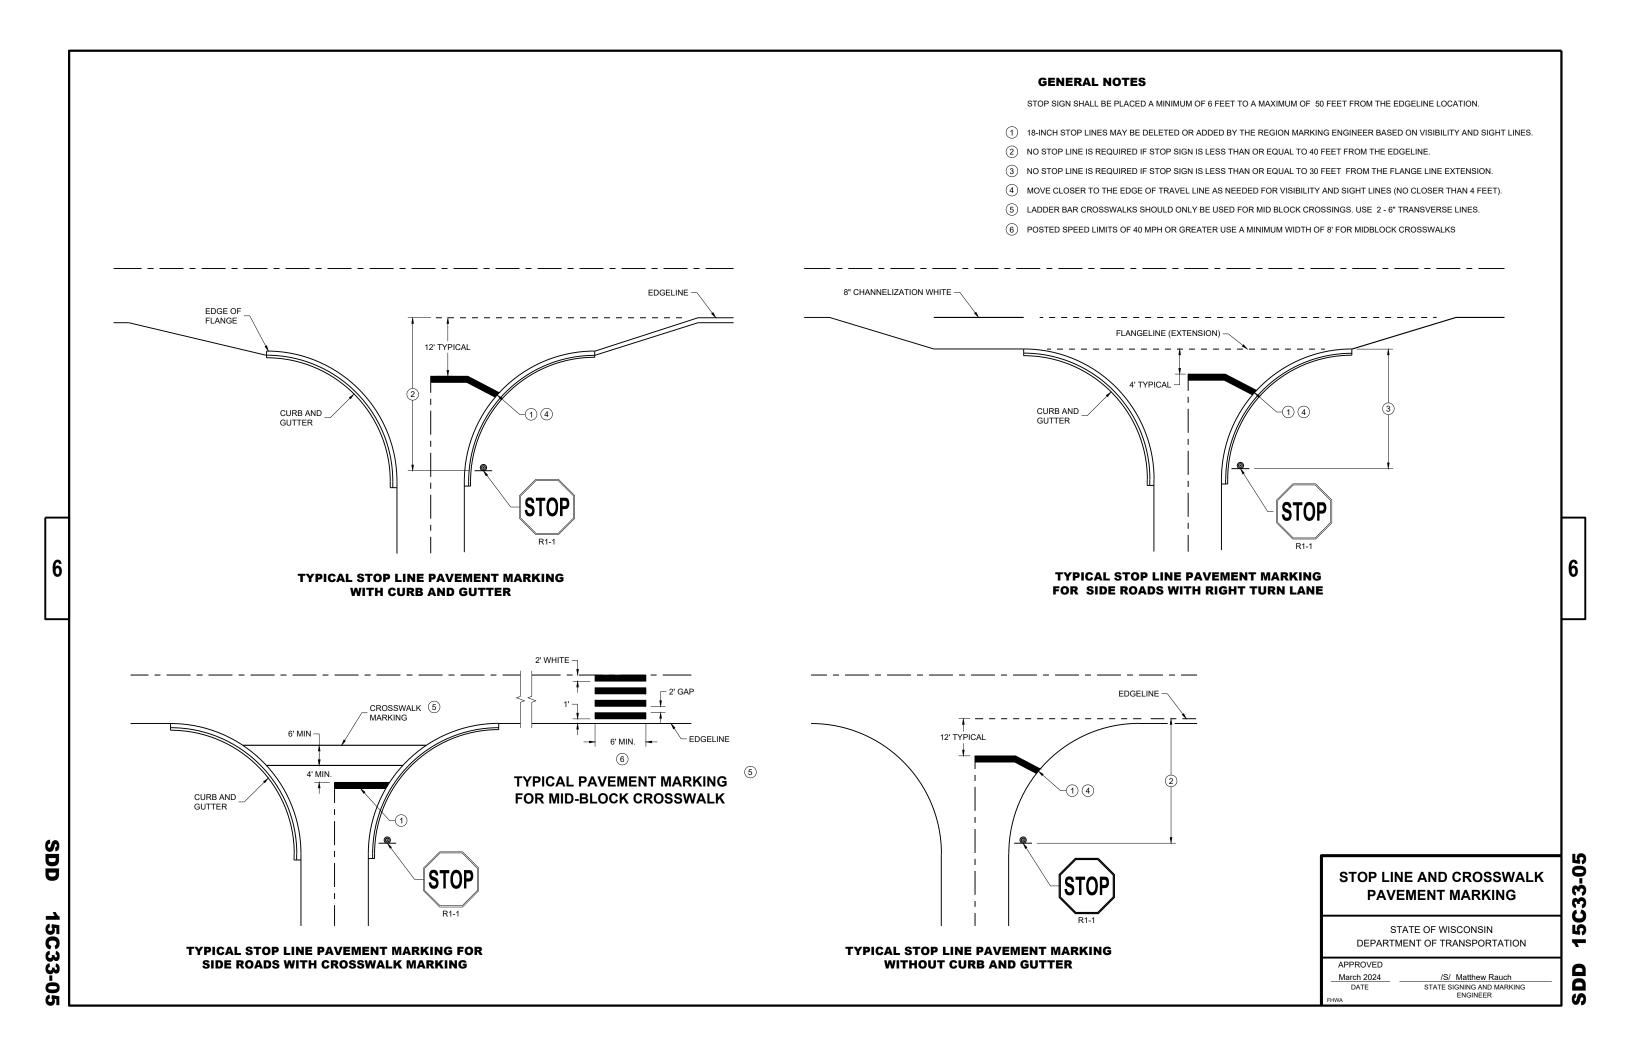


BARRICADE DEVICE SELECTED FROM APPROVED PRODUCT LIST

- (1) REFLECTIVE SHEETING SHALL FOLLOW THE REQUIREMENTS IN THE APPROVED PRODUCTS LISTING FOR SIGN SHEETING.
- ② SHEETING REQUIRED ON MORE THAN 50% OF BARRICADE WIDTH.
- 3) PLACE SHEETING ON BOTH SIDES OF THE BARRICADE.
- * USE THIS DETAIL FOR SHEETING PLACEMENT REFERENCE.

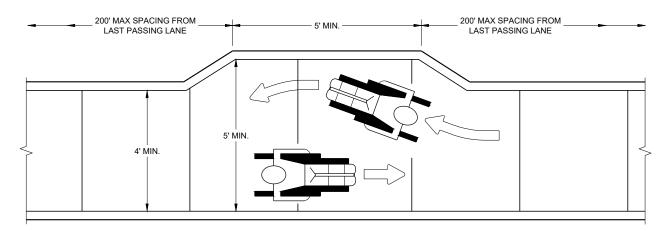

NARROW SIDEWALK PASSING DETAIL

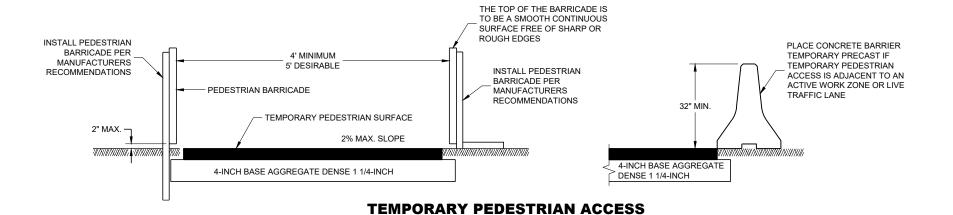

12" MAX. 3' MIN. 4' MAX. VARIES — VARIES -

TEMPORARY PEDESTRIAN BARRICADE*

TRAFFIC CONTROL, **PEDESTRIAN ACCOMMODATION**

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15D30

SDD

STATE OF WISCONSIN DEPARTMENT OF TRANSPORTATION


6

CURB RAMPS AND LANDINGS SHALL HAVE A 1:50 (2%) MAX. CROSS-SLOPE.


CLEAR SPACE OF 48" X 48" SHALL BE PROVIDED ABOVE AND BELOW THE CURB RAMP. LATERAL JOINTS OR GAPS BETWEEN SURFACES SHALL BE LESS THAN $\frac{1}{2}$ " WIDTH.

CHANGES BETWEEN SURFACE HEIGHTS SHALL NOT EXCEED $\frac{1}{2}$ ". LATERAL EDGES MAY BE VERTICAL UP TO $\frac{1}{4}$ " HIGH AND SHALL BE BEVELED AT 1:2 BETWEEN $\frac{1}{4}$ " AND $\frac{1}{2}$ ".

- (1) INSTALL CONTRASTING TEMPORARY DETECTABLE WARNING FIELD AT PEDESTRIAN STREET CROSSINGS, AS SHOWN IN THE DI ANS
- (2) PROTECTIVE EDGING WITH A 2" MIN. HEIGHT SHALL BE INSTALLED WHEN A CURB RAMP OR LANDING PLATFORM HAS A VERTICAL DROP OF 6" OR GREATER OR HAS A SIDE APRON SLOPE STEEPER THAN 1:3 (33%). PROTECTIVE EDGING SHOULD BE CONSIDERED WHEN CURB RAMPS OR LANDING PLATFORMS HAVE A VERTICAL DROP OF 3" OR MORE.
- (3) DETECTABLE EDGING WITH 6" MIN. HEIGHT AND CONTRASTING COLOR SHALL BE INSTALLED ON ALL CURB RAMP LANDINGS WHERE THE WALKWAY CHANGES DIRECTION (TURNS).
- (4) DO NOT RESTRICT WATER FLOW IN THE GUTTER SYSTEM.
- 5 ENSURE CURB RAMP IS OUT OF THE GUTTER PAN.
- (6) IF ONLY PART OF THE END PANEL OF TEMPORARY PEDESTRIAN BARRICADE PANEL IS NEEDED, EXTEND EXCESS PORTION OF TEMPORARY PEDESTRIAN BARRICADE PANEL HERE.

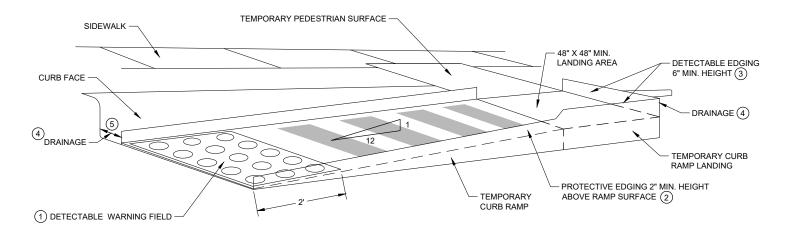

PERSPECTIVE VIEW

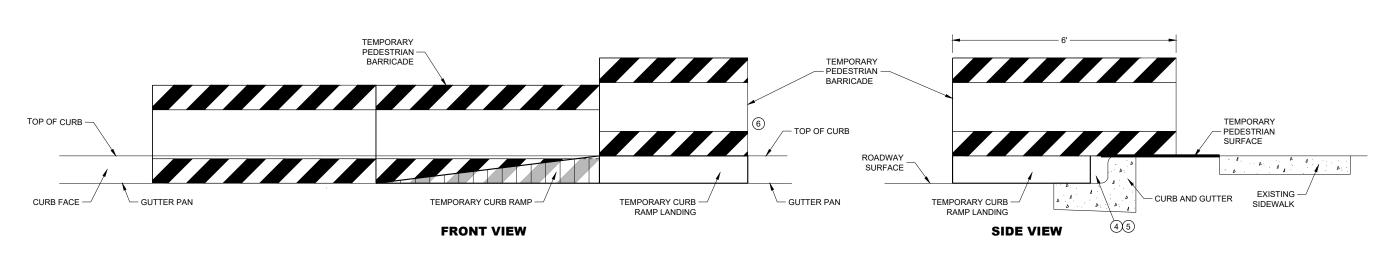

TEMPORARY CURB RAMP PARALLEL TO CURB

TRAFFIC CONTROL,
PEDESTRIAN
ACCOMMODATION

STATE OF WISCONSIN DEPARTMENT OF TRANSPORTATION

6

SDD 15D30

SDD 15D30 - 09

GENERAL NOTES

CURB RAMPS SHALL BE 48" MINIMUM WIDTH WITH A FIRM, STABLE AND SLIP RESISTANT SURFACE.

CURB RAMPS AND LANDINGS SHALL HAVE A 1:50 (2%) MAX. CROSS-SLOPE.

AND SHALL BE BEVELED AT 1:2 BETWEEN 1/4" AND 1/2".

LANDINGS WHERE THE WALKWAY CHANGES DIRECTION (TURNS).

CLEAR SPACE OF 48" X 48" SHALL BE PROVIDED ABOVE AND BELOW THE CURB RAMP. LATERAL JOINTS OR GAPS BETWEEN SURFACES SHALL BE LESS THAN $\frac{1}{2}$ " WIDTH.

ALTERNATE SIDEWALK WORK BETWEEN LEFT AND RIGHT SIDE OF ROADWAY TO MAINTAIN PEDESTRIAN ACCESS.

CHANGES BETWEEN SURFACE HEIGHTS SHALL NOT EXCEED $\frac{1}{2}$ ". LATERAL EDGES MAY BE VERTICAL UP TO $\frac{1}{4}$ " HIGH

(1) INSTALL CONTRASTING TEMPORARY DETECTABLE WARNING FIELD AT PEDESTRIAN STREET CROSSINGS, AS SHOWN IN

PROTECTIVE EDGING WITH A 2" MIN. HEIGHT SHALL BE INSTALLED WHEN A CURB RAMP OR LANDING PLATFORM HAS A VERTICAL DROP OF 6" OR GREATER OR HAS A SIDE APRON SLOPE STEEPER THAN 1:3 (33%). PROTECTIVE EDGING

SHOULD BE CONSIDERED WHEN CURB RAMPS OR LANDING PLATFORMS HAVE A VERTICAL DROP OF 3" OR MORE.

3 DETECTABLE EDGING WITH 6" MIN. HEIGHT AND CONTRASTING COLOR SHALL BE INSTALLED ON ALL CURB RAMP

TERRACE TERRACE ORAINAGE ODRAINAGE TERRACE ODRAINAGE ODRAINAGE ODRAINAGE ODRAINAGE ODRAINAGE ODRAINAGE ODRAINAGE

WITH SIDE APRON $^{\scriptsize{\scriptsize{\scriptsize{\scriptsize{\scriptsize{5}}}}}}$

SIDEWALK PROTECTIVE EDGING ② 2" MIN. HEIGHT CURB FACE DRAINAGE 2 PROTECTIVE EDGING 2" MIN. HEIGHT DETECTABLE WARNING FIELD

SDD 15D30

TEMPORARY CURB RAMP PERPENDICULAR TO CURB


WITH PROTECTIVE EDGE


TRAFFIC CONTROL, PEDESTRIAN ACCOMMODATION

STATE OF WISCONSIN
DEPARTMENT OF TRANSPORTATION

GENERAL NOTES

- (1) REFLECTIVE SHEETING SHALL FOLLOW THE REQUIREMENTS IN THE APPROVED PRODUCTS LISTING FOR SIGN SHEETING.
- ② SHEETING REQUIRED ON MORE THAN 50% OF BARRICADE WIDTH.
- (3) PLACE SHEETING ON BOTH SIDES OF THE BARRICADE.
- \bigstar USE THIS DETAIL FOR SHEETING PLACEMENT REFERENCE.

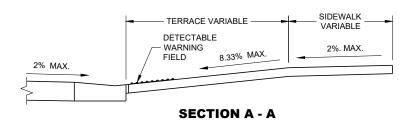

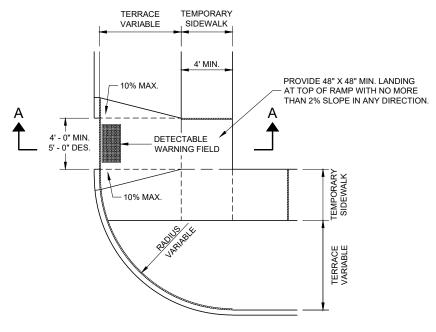

PLAN VIEW TEMPORARY TYPE 3 RAMP

(OUTSIDE OF CROSSWALK AREA)

TRAFFIC CONTROL, PEDESTRIAN ACCOMMODATION

STATE OF WISCONSIN DEPARTMENT OF TRANSPORTATION

APPROVED	
May 2023	/S/ Andrew Heidtke
DATE	WORK ZONE ENGINEER

SDD

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15D30-09d

5D30-09d SDD

SIDEWALK DETOUR, SIDEWALK ONLY ON ONE SIDE

GENERAL NOTES

SIGN LAYOUTS SHALL BE IN ACCORDANCE WITH THE WISCONSIN STANDARD SIGN PLATES.

WHERE TEMPORARY BARRICADE RUNS PARALLEL ALONG SIDEWALK, PLACE THE FACE OF THE BARRICADE AT THE EDGE OF THE SIDEWALK.

SIGNS THAT REMAIN IN PLACE LESS THAN SEVEN CONTINUOUS DAYS AND NIGHTS MAY BE MOUNTED ON PORTABLE SUPPORTS.

PLACE TEMPORARY PEDESTRIAN BARRICADE TO FIT FIELD CONDITIONS, AVOIDING CONFLICTS WITH DRIVEWAYS AND OTHER EXISTING FEATURES.

- 1 IF TERRACE IS LESS THAN 6 FEET WIDE, OMIT TEMPORARY PEDESTRIAN BARRICADE FROM THE SIDEWALK TO THE CURB.
- (2) PLACE BARRICADE CLOSURE SO THAT THE TEMPORARY PEDESTRIAN BARRICADE END IS AT THE LAST OPEN SIDEWALK ACCESS TO RESIDENCES OR BUSINESSES BEFORE THE SIDEWALK CLOSURE.
- (3) IF TEMPORARY PEDESTRIAN BARRICADE PANEL IS WIDER THAN THE SIDEWALK WIDTH, THE PORTION OF EXCESS PANEL SHOULD EXTEND INTO THE TERRACE.
- 4 MOUNTING HEIGHT OF 5 FEET FROM THE SURFACE TO THE BOTTOM OF SIGN.

TRAFFIC CONTROL,
PEDESTRIAN ACCOMMODATION

STATE OF WISCONSIN
DEPARTMENT OF TRANSPORTATION

SIDEWALK DIVERSION SINGLE SIDE

GENERAL NOTES

TYPICAL TEMPORARY PEDESTRIAN BARRICADE PANEL IS 6 FEET LONG.

SIGN LAYOUTS SHALL BE IN ACCORDANCE WITH THE WISCONSIN STANDARD SIGN PLATES.

WHERE TEMPORARY BARRICADE RUNS PARALLEL ALONG SIDEWALK, PLACE THE FACE OF THE BARRICADE AT THE EDGE OF THE SIDEWALK.

SIGNS THAT REMAIN IN PLACE LESS THAN SEVEN CONTINUOUS DAYS AND NIGHTS MAY BE MOUNTED ON PORTABLE SUPPORTS.

- ① USE TEMPORARY PEDESTRIAN BARRICADE TO SEPARATE PEDESTRIANS FROM DROP OFFS OR FOR ADDITIONAL PEDESTRIAN CHANNELIZATION.
- (2) IF TEMPORARY PEDESTRIAN BARRICADE PANEL IS WIDER THAN THE SIDEWALK WIDTH, THE PORTION OF EXCESS PANEL SHOULD EXTEND INTO THE TERRACE.
- 3 MOUNTING HEIGHT OF 5 FEET FROM THE SURFACE TO THE BOTTOM OF SIGN.

6


SDD 15D30 - 09g


STATE OF WISCONSIN
DEPARTMENT OF TRANSPORTATION


TRAFFIC CONTROL,
PEDESTRIAN ACCOMMODATION

SDD 15D30 - 09g

TYPICAL ASSEMBLIES

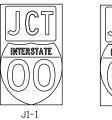

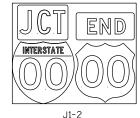

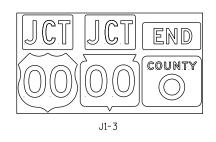



MISTIC

ROAD

JR99-1





(Typical Vertical J-Assembly See Note 10 and 11)







INTERSTATE

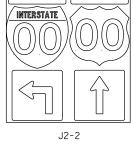

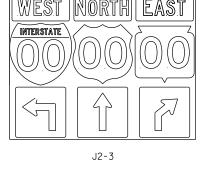


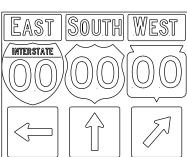

J3-3

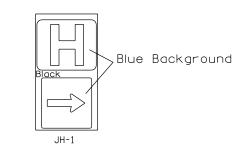



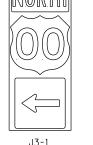




J4-1


COUNTY


J13-1

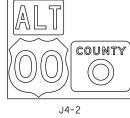



J3-2



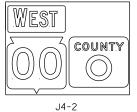

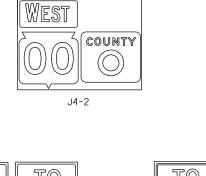

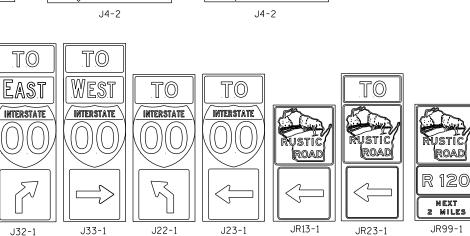

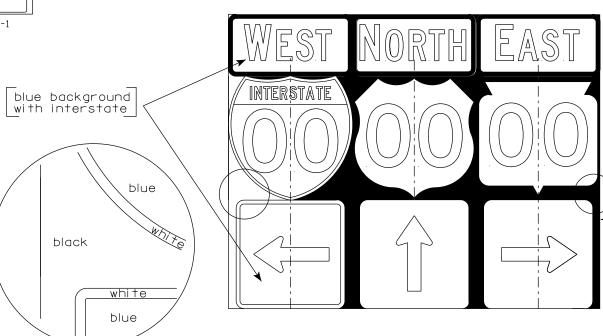

NOTES

1. Signs are Type II - Type H Reflective

2. Color:

Background - Black Non-reflective Message - see Note 4

- 3. Message Series See Note 4
- 4. The colors and message spacing on each marker shall be according to the applicable route marker panel specifications.
- 5. Certain marker heads require the component pieces to be the same color. As an example, all the components used with an M1-1 Interstate marker shall be blue.
- 6. Single panel j-assemblies shall only be used with route marker shields that are same size. If the route marker shields are different size use multiple piece component.
- 7. Route assemblies that have 24 inch route shields and have dimensions greater than 48 inches (both vertical and horizontal) shall have one horizontal splice between the arrows and route shields. Vertical splices shall not be used on route assemblies with a horizontal dimension of 144 inches or less. The contractor shall not use more than one vertical joint per sign and the joint shall be between route shields.
- 8. Route assemblies that have 36 inch shields and have dimensions greater than 48 inchs (both vertical and horizontal) shall have two horizontal splices. One horizontal splice shall be between the cardinal direction and route shields and the other horizontal splice shall be between the arrows and route shields. Vertical splices shall not be used on route assemblies with a horizontal dimension of 144 or less. The contractor shall not use more than one vertical joint per sign and the joint shall be between route shields.
- 9. All Vertical J Assemblies are given a Sign Code of JV
- 10. For JV Assemblies that have a mixture of Interstate and Non-Interstate shields, arrows and cardinals shall be white on blue.
- 11. For JV Assemblies that have a mixture of Non-Interstate and Auto-Tour shields, arrows and cardinals shall be black on white.

black white black background

ROUTE MARKERS & COMPONENTS IN TYPICAL ASSEMBLIES

WISCONSIN DEPT OF TRANSPORTATION

APPROVED For State Traffic Engineer

DATE 6/7/23

PLATE NO. <u>A2-1S.10</u> Ε SHFFT NO:


PROJECT NO:

FRONTAGE


ROAD

J12-1



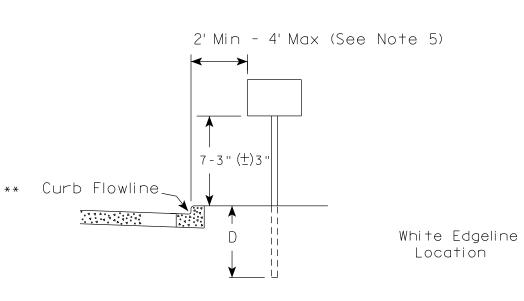

RURAL AREA (See Note 2)

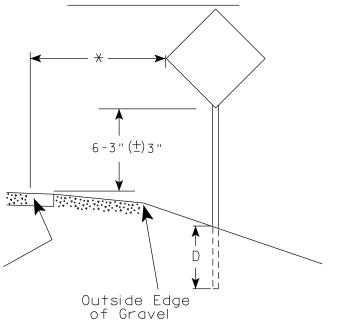


GENERAL NOTES

- 1. Signs wider than 4 feet or 20 sq.ft or larger, shall be mounted on multiple posts. Refer to plate A4-4.
- 2. If signs are mounted on or behind barrier wall, see A4-10 sign plate.

The Double Arrow sign (W12-1D) shall be mounted at a height of 2'-3" (\pm) 3". The Chevron sign (W1-8), Roundabout Chevron panel (R6-4B), Enhanced Reference Markers, Clearance Markers (W5-52), Mile Markers (D10 series), In Road Object Markers (W5-54) & End of Road Markers (W5-56) shall be mounted at a height of 4'-3" (\pm) 3".

- 3. For expressways and freeways, mounting height is 7'- 3" (\pm) 3" or 6'-3" (\pm) 3" depending upon existence of a sub-sign.
- 4. Minimum mounting height for signs mounted on traffic signal poles is 5' 3'' ($\frac{+}{-}$) 3''.
- 5. Offset distance shall be consistent with existing signs or consistent throughout length of project.
- 6. Folding signs shall be mounted at a height of 5'-3'' (\pm) 3'' or as directd by the Engineer.

2' Min - 4' Max (See Note 5)

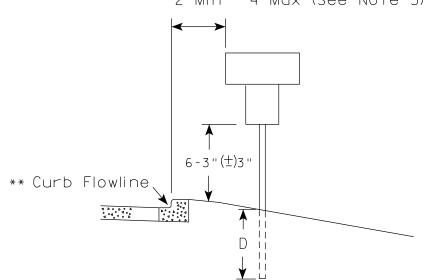

White Edgeline
Location

Outside Edge
of Gravel

POST EMBEDMENT DEPTH

Area of Sign	
Installation	D
(Sq.Ft.)	(Min)
20 or Less	4'
Greater than 20	5'

The existence of curb and gutter does not in itself mandate the vertical clearance illustrated. That height is typically measured where there is sidewalk adjacent to the roadway or parking is permitted. In the absence of sidewalk vertical clearance is measured from the top of the curb. Offset of signs is measured from the flow line.

* 6 feet from edge of a paved shoulder or 12 feet from the edge of pavement (edge line location) or 2 feet from outside edge of gravel, whichever is greater unless directed by project engineer.

PLOT BY : mscj9h

TYPICAL INSTALLATION
OF PERMANENT TYPE II
SIGNS ON SINGLE POSTS

WISCONSIN DEPT OF TRANSPORTATION

APPROVED

Matthew R Rawh

For State Traffic Engineer

DATE 12/6/23 PLATE NO. __A4-3.23

Ε

PROJECT NO: HWY: COUNTY: SHEET NO:



NOTES: 1. ALL MATERIAL TO BE APPROVED

BY ENGINEER PRIOR TO INSTALLATION

- 2. SEE SIGN PLATE A4-8 FOR SIGN HARDWARE REQUIREMENTS
- 3. 18 INCH X 18 INCH SQUARE BOX-OUTS MAY BE USED FOR INSTALLATIONS IN EXISTING CONCRETE OR ASPHALT LOCATIONS.



ELEVATION VIEW

DETAIL OF STEEL 2 X 2 SIGN POST IN BOX-OUT



DETAIL OF WOOD 4 X 6 SIGN POST IN BOX-OUT

HWY:



PLAN VIEW

COUNTY:

FOR NEW CONCRETE/ASPHALT INSTALLATIONS

SIGN POST BOX-OUTS A4-3B

WISCONSIN DEPT OF TRANSPORTATION

For State Traffic Engineer

DATE 1/27/14 PLATE NO. A4-3B.1

SHEET NO:

FILE NAME : C:\CAEFiles\Projects\tr_stdplate\A43B.DGN

PROJECT NO:

PLOT DATE: 27-JAN-2014 09:48


PLOT NAME :


PLOT BY: mscsja

PLOT SCALE: 13.659812:1.000000


APPROVED

WISDOT/CADDS SHEET 42

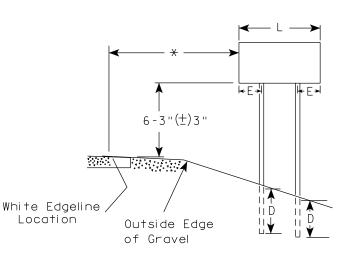

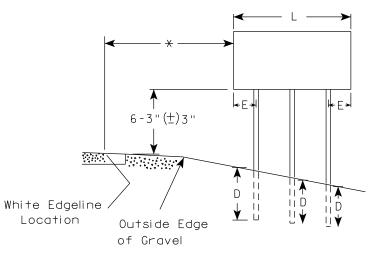

2'Min - 4'Max (See Note 6)

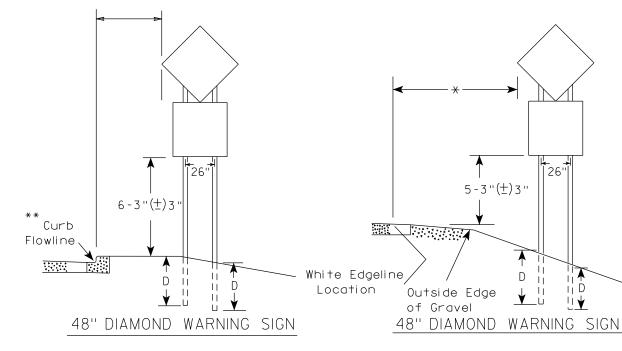

	SIGN SHAPE OTHER THAN DIAMO (TWO POSTS REQUIRED)	
	L	E
***	Greater than 48" Less than 60"	12"
	60" to 108"	L/5

SIGN SHAPE OTHER THAN DIAMOND (THREE POSTS REQUIRED)			
L	E		
Greater than 108" to 144"	12''		

GENERAL NOTES

- 1. For 3 or 4 post installations, individual post spacing shall be greater than 3'-6".
- 2. See tables below for required number of posts.
- 3. For expressways and freeways, mounting height is 7'-3" (±) 3" or 6'-3" (±) 3" depending upon existence of sub-sign.
- 4. The (±) tolerance for mounting height is 3 inches.
- 5. J-Assemblies are considered to be one sign for mounting height.
- 6. Offset distance shall be consistent with existing signs or consistent throughout length of project.
- 7. Folding signs shall be mounted at a height of 5'-3'' (\pm) 3'' or as directed by the engineer.
- 8. The Double Arrow sign (W12-1) shall be mounted at a height of 2'-3" (±) 3". The Chevron sign (W1-8), Roundabout Chevron panel (R6-4B), Clearance Markers (W5-52), Mile Markers (D10 series), In Road Object Markers (W5-54) & End of Road Markers (W5-56) shall be mounted at a height of 4"-3" (±) 3".
- * 6 feet from edge of a paved shoulder or 12 feet from the edge of pavement (edge line location) or 2 feet from outside edge of gravel, whichever is greater unless directed by project engineer.
- ** The existence of curb and gutter does not in itself mandate the vertical clearance illustrated. That height is typically measured where there is sidewalk adjacent to the roadway or parking is permitted. In the absence of sidewalk vertical clearance is measured from the top of the curb. Offset of signs is measured from the flow line.
- $\star\star\star$ See A4-3 sign plate for signs 4' or less in width and less than 20 S.F. in area.

POST EMBEDMENT DEPTH

	ı
Area of Sign	
Installation	D
(Sq. Ft.)	(Min)
20 or Less	4'
Greater than 20	5'

TYPICAL INSTALLATION OF TYPE II SIGNS ON MULTIPLE POSTS

WISCONSIN DEPT OF TRANSPORTATION

APPROVED

For State Traffic Engineer

DATE 12/6/23 PLATE NO. A4-4.16

SHEET NO:

Ε

PROJECT NO: HWY:

FILE NAME : C:\CAEfiles\Project\tr_stdplate\A44.dgn

COUNTY:


1 Y =

PLOT DATE: 6-DEC 2023 11:31

PLOT BY : mscj9h

PLOT NAME :

PLOT SCALE: \$\$.....plotscale.....\$\$ WISDOT/CADDS SHEET 42

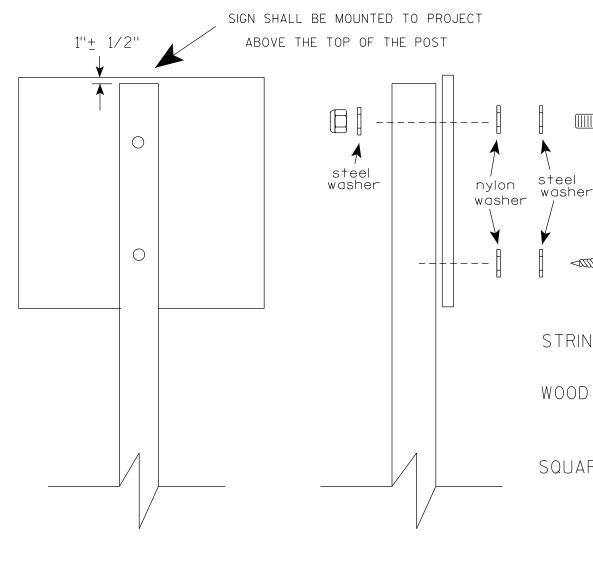

Nuts, bolts and lags used for mounting signs shall have hexagonal heads and shall be either:

- a. Hot dip galvanized in accordance with ASTM Designation: A 153. Class D. or SC 3
- b. Electro-galvanized in accordance with ASTM Designation: B 633, TYPE III, SC 3.

Threads on bolts and nuts shall be manufactured with sufficient allowance for the cadmium plate or galvanized coating to permit the nuts to run freely on the bolts.

STRINGER BOLTING TO ALUMINUM SIGNS (SEE SIGN PLATE A4-18)

MACHINE BOLTS - $\frac{5}{16}$ " X 1-3/4" Length w/ lock nuts

WOOD POSTS $(4'' \times 6'')$

LAG SCREWS - 3/8" X 3" (NO STRINGERS ON BACK OF SIGN) 3/8" X 4" (STRINGERS ON BACK OF SIGN)

SQUARE STEEL POSTS (2" x 2")

MACHINE BOLTS - 3/8" X 3-1/4" Length w/ nuts (NO STRINGER ON BACK OF SIGN) 3/8" X 5" Length w/ nuts (STRINGERS ON BACK OF SIGN)

RIVETS - 1/32 " (6605-9-6) BULB-TITE. TRI-FOLD. ALUMINUM BODY/MANDREL O.D. FLANGE .720-.765 INCH, GRIP RANGE .042-.375 INCH

WASHERS (ALL POSTS) -

1-1/4" O.D. X $\frac{3}{8}$ " I.D. X $\frac{1}{16}$ " STEEL 1-1/4" O.D. X $\frac{3}{8}$ " I.D. X .080 NYLON

Two different fastening systems are shown for illustration purposes. On any individual sign, either one or the other system shall be used. Actual number of fasteners per sign varies with the sign area, but normally there are two. For a single post installation, all signs greater than 9 sq.ft. require the use of 3 fasteners.

ATTACHMENT OF SIGNS TO POSTS

WISCONSIN DEPT OF TRANSPORTATION

APPROVED Matther

≠or State Traffic Engineer

SHEET NO:

DATE 4/1/2020

PLATE NO. <u>A4-8.9</u>

PLOT DATE: 01-APRIL-2020

PLOT BY : dotc4c

WISDOT/CADDS SHEET 42

Ε

FILE NAME : C:\CAEFiles\Projects\tr_stdplate\A48.DGN

PROJECT NO:



PROJECT NO: HWY: COUNTY: SHEET NO: FILE NAME : C:\CAEFiles\Projects\tr_stdplate\A49.DGN PLOT DATE: 05-FEB-2015 17:09 PLOT BY: mscsja PLOT NAME : PLOT SCALE: 13.659812:1.000000

DATE 2/05/15

PLATE NO. <u>A4-9.9</u>

For State Traffic Engineer



BANDING



SINGLE SIGN





WASHER PLACEMENT



HWY:

WASHERS (ALL POSTS) -

1-1/4" O.D. X³/₈" I.D. X¹/₁₆" STEEL 1-1/4" O.D. $\times \frac{3}{8}$ " I.D. \times .080 NYLON FOR ALL TYPE H SIGNS

CHANNEL

GENERAL NOTES

- 1. Any sign over 3 feet in width shall use the V-Block banding method. See A5-10 standard plate.
- 2. Signs 3 feet or greater in height shall have three bracket bands installed. Signs less than 3 feet in height shall have two bracket bands installed.
- 3. Banding and assembly bracket shall be stainless steel. All bands shall be $\frac{3}{4}$ " in width and 0.025" thickness.
- 4. ALL SIGN MOUNTING BOLTS AND WASHERS SHALL BE EITHER:
 - a. Hot dip or mechanically galvanized in accordance with ASTM Designation: A 153, Class D
 - b. Electro-galvanized in accordance with ASTM designation: B 633, Type III, SC 3

"J" ASSEMBLY



STANDARD SIGN SIGN BANDING DETAILS

WISCONSIN DEPT OF TRANSPORTATION

SHEET NO:

APPROVED

DATE 6/10/19

PLATE NO. A5-9.4

Ε

State Traffic Engineer

COUNTY:

PLOT NAME :

PLOT SCALE: \$\$.....plotscale.....\$\$ WISDOT/CADDS SHEET 42

PROJECT NO:

VIEW FROM TOP

GENERAL NOTES

- 1. WOOD 4"X6" POST MATERIAL SHALL CONFORM TO 507.2.2 OF THE WISDOT STANDARD SPECIFICATIONS
- 2. BLOCK BANDING AND CLIPS SHALL BE STAINLESS STEEL, $\frac{3}{4}$ " WIDTH AND 0.025" THICKNESS
- 3. SIGNS 3' OR GREATER IN HEIGHT SHALL UTILIZE 3 BLOCK BANDS.

 SIGNS UNDER 3' IN HEIGHT SHALL UTILIZE 2 BLOCK BANDS
- 4. ACTUAL NUMBER OF FASTENERS PER SIGN VARIES WITH THE SIGN AREA, BUT NORNALLY THERE ARE TWO. FOR SIGNS GREATER THAN 9 S.F. 3 FASTENERS SHALL BE USED.
- 5. ALL SIGN MOUNTING BOLTS AND WASHERS SHALL BE EITHER:
 - a. Hot dip or mechanically galvanized in accordance with ASTM Designation: A 153, Class D
 - b. Electro-galvanized in accordance with ASTM Designation: B 633, TYPE III, SC 3
- 6. ALL BOLTS SHALL HAVE HEXAGONAL HEADS.
- 7. STEEL WASHERS SHALL BE $1^{1}/_{4}$ " O.D. X $3/_{8}$ " I.D. X $1/_{16}$ "
- 8. NYLON WASHERS SHALL BE $1^{1}/_{4}$ " O.D. X $3/_{8}$ " I.D. X .080 FOR TYPE H OR TYPE F FACE SIGN

 \rightarrow LAG BOLTS SHALL BE $\frac{3}{8}$ " X $\frac{2}{2}$ "

BLOCK BANDING DETAIL (V-BLOCK OPTION)

WISCONSIN DEPT OF TRANSPORTATION

Manher R

APPROVED

DATE 4/19/2022 PLATE NO. A5-10.3

SHEET NO:

FILE NAME : C:\CAEfiles\Projects\tr_stdplate\A510.dgn

PROJECT NO:

PLOT DATE: 19-APRIL 2022 11:55

SIGN

PLOT BY : dotc4c

WISDOT/CADDS SHEET 42

Ε

- 1. Sign is Type II Type F Reflective
- 2. Color:

Background - Orange Message - Black

- 3. Message Series C
- 4. Corners may be square or rounded when base material is plywood but borders shall be rounded as shown. When base material is metal, the corners and borders shall be rounded.

C —		<u> </u>
		H
		F H B
		F G
←	A	\
ı	G20-2A	I

SIZE D 4.5 36 3/8 1/23 3/4 | 2 1/2 | 4 1/8 | 4 1/8 | 11 1/8 12 1/8 18 1 1/2 4 1/2 3 3/4 5 7/8 6 3/4 16 3/4 2 1/2 1 3/4 18 1/2 5/8 48 1 1/8 1/2 8.0 2M 1 1/8 4 1/2 3 3/4 5 7/8 6 3/4 16 3/4 2 1/2 1 3/4 18 1/2 48 5/8 24 1/2 8.0 48 1 1/8 5/8 4 1/2 3 3/4 5 7/8 6 3/4 16 3/4 2 1/2 1 3/4 18 1/2 24 1/2 8.0 4 1/2 3 3/4 4 48 24 1 1/8 1/2 5/8 5 % 6 $\frac{3}{4}$ | 16 $\frac{3}{4}$ | 2 $\frac{1}{2}$ | 1 $\frac{3}{4}$ | 18 $\frac{1}{2}$ 8.0 5 48 24 | 1 $\frac{7}{8}$ 1/2 5/8 4 1/2 | 3 3/4 | 5 7/8 | 6 3/4 | 16 3/4 | 2 1/2 | 1 3/4 | 18 1/2 | 6 8.0

COUNTY:

STANDARD SIGN G20-2A

WISCONSIN DEPT OF TRANSPORTATION

APPROVED Matthew & Raw

SHEET NO:

For State Traffic Engineer

DATE 1/26/2023 PLATE NO. G20-2A.10

FILE NAME : C:\CAEfiles\Projects\tr_stdplate\G202A.dgn

HWY:

PROJECT NO:

PLOT DATE: 26-JAN 2023 8:27

PLOT BY : dotc4c

PLOT NAME :



- 1. Sign is Type II Type H Reflective
- 2. Color:


Background - White Message – Black

3. Message Series - D except 3 number signs Series C

G G F A
BLACK

M1-6

HWY:

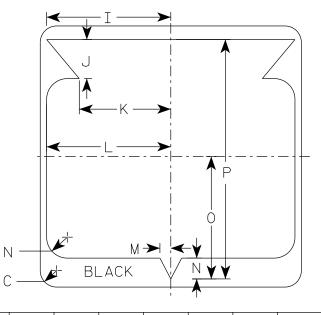

SIZ	Ξ Δ	Д	В	С	D	E	F	G	Н	I	J	K	L	М	N	0	Р	Q	R	S	T	U	V	W	X	Υ	Z	Area sq. ft.
1																												
2	2	24		1 1/2			12	5 1/2	6 1/2	10 1/4	2 1/2	8 1/8	11 1/2	1	1 1/8	11 1/4	21 1/8											4.0
21	2	24		1 1/2			12	5 1/2	6 1/2	10 1/4	2 1/2	8 1/8	11 1/2	1	1 1/8	11 1/4	21 1/8											4.0
3	3	36		2 1/4			18	8 3/4	9 1/4	15 3/8	5 3/8	12 5/8	17 1/8	1 1/2	2 1/8	16 1/8	33											9.0
4	3	36		2 1/4			18	8 3/4	9 1/4	15 3/8	5 3/8	12 5/8	17 1/8	1 1/2	2 1/8	16 1/8	33											9.0
5	3	36		2 1/4			18	8 3/4	9 1/4	15 3/8	5 3/8	12 5/8	17 1/8	1 1/2	2 7/8	16 7/8	33											9.0

COUNTY:

STATE ROUTE MARKER M1-6 FOR ASSEMBLIES

WISCONSIN DEPT OF TRANSPORTATION

APPROVED

₹or State Traffic Engineer

SHEET NO:

DATE 11/8/2022 PLATE NO. M1-6.11

Ε

FILE NAME : C:\CAEfiles\Projects\tr_stdplate\M16.dgn

PROJECT NO:

PLOT DATE: 8-NOV 2022 8:40

PLOT BY : dotc4c

PLOT NAME :

1. All Signs Type II - Type H Reflective

NOTES

2. Color:

Background - See note 5 Message - See note 5

- 3. Message Series C
- 4. Corners may be square or rounded when base material is plywood but borders shall be rounded as shown. When base material is metal, the corners and borders shall be rounded.
- 5. M3-1 thru M3-4 Background - White

Message - Black

MB3-1 thru MB3-4 Background - Blue

Message - White

MK3-1 thru MK3-4 Background - Green

Message - White

MM3-1 thru MM3-4 Background - White

Message - Green


MN3-1 thru MN3-4 Background - Brown

Message - White


MP3-1 thru MP3-4 Background - White

Message - Blue


6. Note the first letter of each direction is larger than the remainder of the message.

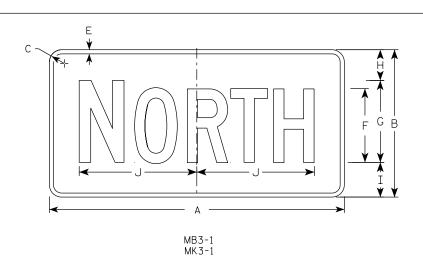


M3-1 MM3-1 MP3-1

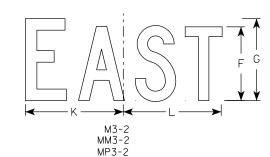



MM3-3

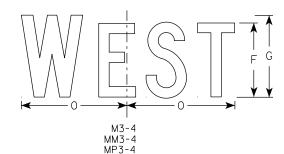

HWY:

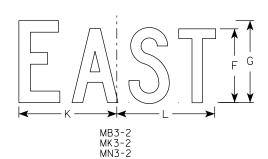

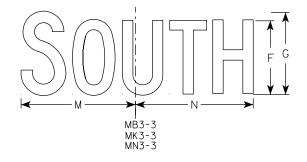

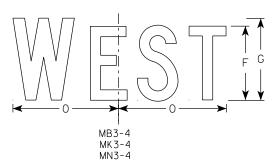

SIZE	А	В	С	D	E	F	G	Н	I	J	K	L	М	N	0	Р	Q	R	S	Т	U	V	w	X	Y	Z	Area sq. ft.
1																											
25	24	12	1 1/2	3/8	3/8	6	7	2 1/4 2	3/4 10) 1/4	7 1/8	8 3/8	10 1/4	9 3/4	8 3/4												2.00
2M	24	12	1 1/2	3/8	3/8	6	7	2 1/4 2	3/4 10) 1/4	7 1/8	8 3/8	10 1/4	9 3/4	8 3/4												2.00
3	36	18	1 1/2	3/8	1/2	9	10	3 3/4 4	1/4 14	1 3/8	12	12 1/8	14	14 1/8	13												4.5
4	36	18	1 1/2	3/8	1/2	9	10	3 3/4 4	1/4 14	1 3/8	12	12 1/8	14	14 1/8	13												4.5
5	36	18	1 1/2	3/8	1/2	9	10	3 3/4 4	1/4 14	1 3/8	12	12 1/8	14	14 1/8	13												4.5

COUNTY:

STANDARD SIGNS M3-1 THRU M3-4 SERIES

WISCONSIN DEPT OF TRANSPORTATION

SHEET NO:

APPROVED

DATE 2/8/2023

PLATE NO. <u>M3-1.1</u>5

FILE NAME : C:\CAEfiles\Projects\tr_stdplate_M31.dgn

PROJECT NO:

PLOT DATE: 8-FEB 2023 11:00

PLOT BY : dotc4c

PLOT NAME :

- 1. Sign is Type II Type F Reflective
- 2. Color:

Background - Orange Message - Black

- 3. Message Series B
- 4. Corners may be square or rounded when base material is plywood but borders shall be rounded as shown. When base material is metal, the corners and borders shall be rounded.

$\begin{array}{c c} & & & \\ \downarrow & & \downarrow \\ \hline & & & \\ \hline & & & \\ \end{array}$	G	
		3
M4-8	>	<u>, </u>

SIZE	Α	В	С	D	E	F	G	Н	I	J	K	┙	М	N	0	Р	Q	R	S	Т	U	٧	W	Χ	Υ	Z	Area sq. ft.
1																											
2	24	12	1 1/2	3/8	3/8	6	3	10	10 1/4																		2.0
2M	24	12	1 1/2	3/8	3/8	6	3	10	10 1/4																		2.0
3	36	18	1 1/2	3/8	1/2	9	4 1/2	14 5/8	14 1/2																		4.5
4	36	18	1 1/2	3/8	1/2	9	4 1/2	14 5/8	14 1/2																		4.5
5	36	18	1 1/2	3/8	1/2	9	4 1/2	14 5/8	14 1/2																		4.5

COUNTY:

STANDARD SIGN M4 - 8

WISCONSIN DEPT OF TRANSPORTATION

APPROVED Matthew

DATE 2/9/2023 PLATE NO. M4-8.4

FILE NAME : C:\CAEfiles\Projects\tr_stdplate\M48.dgn

HWY:

PROJECT NO:

PLOT DATE: 9-FEB 2023 7:38

PLOT BY : dotc4c

PLOT NAME :

2. Color:

Background - Orange Message - Black

- 3. Message Series B
- 4. Corners may be square or rounded when base material is plywood but borders shall be rounded as shown. When base material is metal, the corners and borders shall be rounded.

C	<u> </u>
	G
	F G
M4-8A	→

SIZE	А	В	С	D	E	F	G	Н	I	J	K	L	М	N	0	Р	Q	R	S	Т	U	٧	W	X	Y	Z	Area sq. ft.
1																											
2	24	18	1 1/2	3/8	1/2	6	2	2	4 3/4	9 3/4																	3.0
2M	24	18	1 1/2	3/8	1/2	6	2	2	4 3/4	9 3/4																	3.0
3	30	24	1 1/2	3/8	1/2	8	2 1/2	3	6 3/4	13																	5.0
4	30	24	1 1/2	3/8	1/2	8	2 1/2	3	6 3/4	13																	5.0
5	30	24	1 1/2	3/8	1/2	8	2 1/2	3	6 3/4	13																	5.0

COUNTY:

STANDARD SIGN M4 - 8 A

WISCONSIN DEPT OF TRANSPORTATION

for State Traffic Engineer

DATE 2/9/2023 PLATE NO. M4-8A.4 SHEET NO:

FILE NAME : C:\CAEfiles\Projects\tr_stdplate\M48A.dgn

PROJECT NO:


PLOT DATE: 9-FEB 2023 8:03

PLOT BY : dotc4c

PLOT NAME :

PLOT SCALE: \$\$.....plotscale.....\$\$ WISDOT/CADDS SHEET 42


HWY:

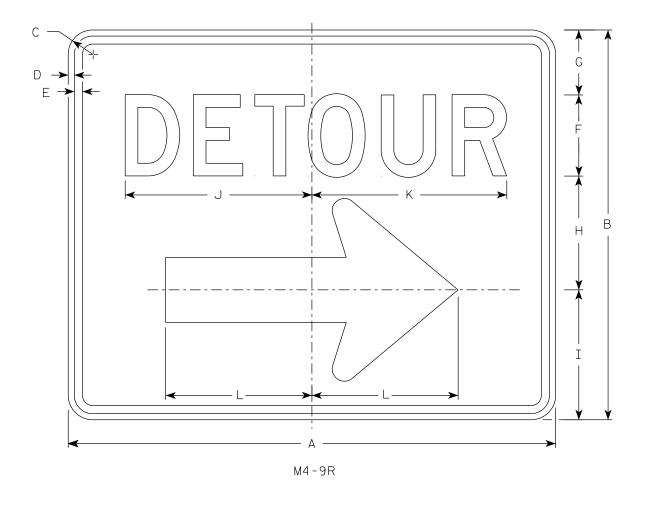

- 1. Sign is Type II Type F Reflective
- 2. Color:

Background - Orange Message - Black

- 3. Message Series D
- 4. Corners may be square or rounded when base material is plywood but borders shall be rounded as shown. When base material is metal, the corners and borders shall be rounded.
- 4. M4-9L is the same as M4-9R except the arrow is reversed.

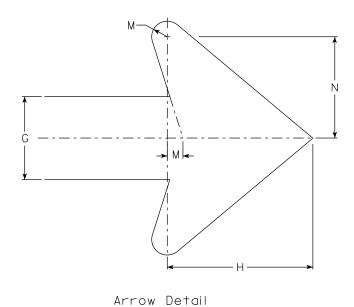

SIZE	А	В	С	D	E	F	G	Н	I	J	K	L	М	N	0	Р	Q	R	S	Т	U	٧	W	X	Y	Z	Area sq. ft.
1																											
2	30	24	1 1/2	3/8	1/2	5	4	7	8	11 1/2	12	9	3/4	4 1/8													5.00
2M	30	24	1 1/2	3/8	1/2	5	4	7	8	11 1/2	12	9	3/4	4 1/8													5.00
3	30	24	1 1/2	3/8	1/2	5	4	7	8	11 1/2	12	9	3/4	4 1/8													5.00
4	48	36	1 1/8	1/2	5/8	8	6	10 1/2	11 5/8	20 %	20 1/2	13 1/4	1 1/8	6 %													12.0
5	48	36	1 1/8	1/2	5/8	8	6	10 1/2	11 5/8	20 5/8	20 1/2	13 1/4	1 1/8	6 1/8													12.0

COUNTY:

STANDARD SIGN M4-9 R & L

WISCONSIN DEPT OF TRANSPORTATION

APPROVED Matthe

Forstate Traffic Engineer

8/2023 PLATE NO. M4-9R.6

DATE <u>2/9/2023</u>

SHEET NO:

Ε


HWY:

PROJECT NO:

- 1. Sign is Type II Type F Reflective
- 2. Color:

Background - Orange Message - Black

- 3. Corners may be square or rounded when base material is plywood but borders shall be rounded as shown. When base material is metal, the corners and borders shall be rounded.
- 4. M4-60L is the same as M4-60R except the arrow is reversed.

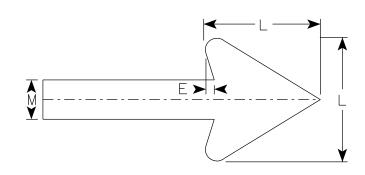

Arrow Detail

H K K	
M4-60R	

SIZE	Α	В	С	D	E	F	G	Н	I	J	К	L	М	N	0	Р	Q	R	S	Т	U	٧	w	Х	Y	Z	Area sq. ft.
1																											
25	30	24	1 1/2	3/8	1/2	2 1/2	11	6	2	3 1/4	7	6	2														5.00
2M	30	24	1 1/2	3/8	1/2	2 1/2	11	6	2	3 1/4	7	6	2														5.00
3																											
4																											
5																											

STANDARD SIGN M4-60 L&R

WISCONSIN DEPT OF TRANSPORTATION

APPROVED Matthew R Rauch

For state Traffic Engineer

DATE 2/14/2023 PLATE NO. M4-60.2

PROJECT NO: HWY: COUNTY: SHEET NO:

FILE NAME: C:\CAEfiles\Projects\tr_stdplate\M460.dgn

PLOT DATE: 14-FEB 2023 8:12

PLOT BY: dotc4c


PLOT NAME: PLOT SCALE: \$\$.....plotscale.....\$\$ WISDOT/CADDS SHEET 42

7

- 1. Sign is Type II- Type F Reflective
- 2. Color:

Background - Orange Message - Black

3. Corners may be square or rounded when base material is plywood but borders shall be rounded as shown. When base material is metal, the corners and borders shall be rounded.

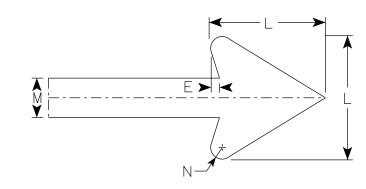

Arrow Detail

IZE A	В	С	D	E	F	G	Н	I	J	K	L	М	N	0	Р	Q	R	S	Т	U	V	W	X	Y	Z	Area sq. ft
1																										
2S 30	24	1 1/2	3/8	1/2	2 1/2	11	6	2	3 1/4	10 3/8	6	2	3/8													5.00
2M 30	24	1 1/2	3/8	1/2	2 1/2	11	6	2	3 1/4	10 3/8	6	2	3/8													5.00
3																										
4																										

COUNTY:

M4-60D

STANDARD SIGN M4-60D

WISCONSIN DEPT OF TRANSPORTATION

APPROVED Matthew R Ray

SHEET NO:

For State Traffic Engineer
DATE 2/14/2023 PLATE NO. M4-60D.2

HWY:

PLOT DATE: 14-FEB 2023 9:49

G

PLOT BY : dotc4c

PLOT NAME :


PLOT SCALE: \$\$.....plotscale.....\$\$


E NAME : C:\CAETIIES\Projects\Tr_STapIdTe\M46UD.agn

PROJECT NO:


.

M5-1L MM5-1L MO5-1L MP5-1L

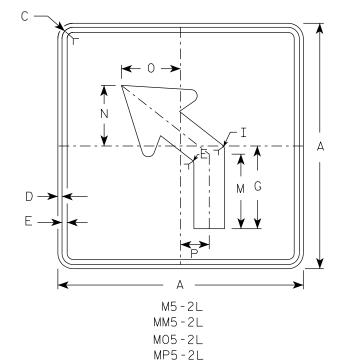

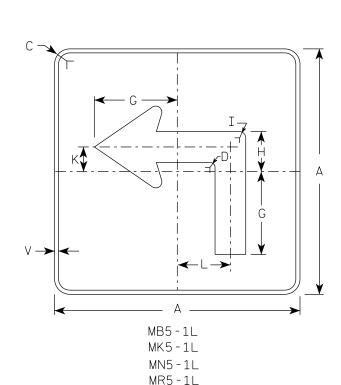

HWY:

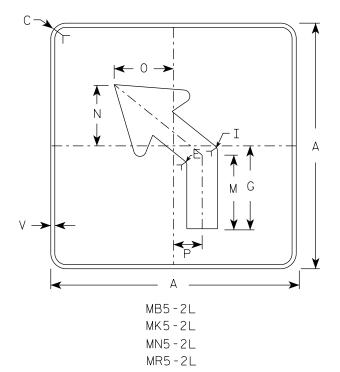

NOTES

- 1. Signs are Type II Type H reflective except as shown

Background - See note 4 Message - See note 4

- 3. Corners may be square or rounded when base material is plywood but borders shall be rounded as shown. When base material is metal, the corners and borders shall be rounded.
- M5-1 and M5-2 Background White Message – Black

MB5-1 and MB5-2 Background - Blue

Message - White

MK5-1 and MK5-2 Background - Green

Message - White

MM5-1 and MM5-2 Background - White

Message - Green

MN5-1 and MN5-2 Background - Brown

Message - White

M05-1 and M05-2 Background - Orange - Type F Reflective

Message - Black

MP5-1 and MP5-2 Background - White


Message - Blue

MR5-1 and MR5-2 Background - Brown

Message - Yellow

- 5. M5-1R same as M5-1L except arrow points right.
- 6. M5-2R same as M5-2L except arrow tilts right.

ARROW DETAIL

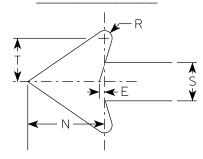

PLOT NAME :

SIZE	А	В	С	D	E	F	G	Н	I	J	K	L	М	N	0	Р	Q	R	S	Т	U	V	W	X	Y	Z	Area sq. ft.
1																											
25	21		1 1/2	3/8	3/8		7	3 3/8	5/8	2	1/8	4 1/2	6 3/8	5 1/4	5	2 1/2		1/2	2	3		1/2					3.06
2M	21		1 1/2	3/8	3/8		7	3 3/8	5/8	2	1/8	4 1/2	6 3/8	5 1/4	5	2 1/2		1/2	2	3		1/2					3.06
3	30		1 1/8	1/2	5/8		10 1/8	4 1/8	7/8		3	6 1/2	9 1/8	7 1/2	7 1/4	3 1/2		3/4	3 3/4	4 1/4		1/2					6.25
4	30		1 1/8	1/2	5/8		10 1/8	4 1/8	7/8		3	6 1/2	9 1/8	7 1/2	7 1/4	3 1/2		3/4	3 3/4	4 1/4		1/2					6.25
5	30		1 1/8	1/2	5/8		10 1/8	4 1/8	7/8		3	6 1/2	9 1/8	7 1/2	7 1/4	3 1/2		3/4	3 3/4	4 1/4		1/2					6.25

COUNTY:

STANDARD SIGN M5-1 & M5-2

WISCONSIN DEPT OF TRANSPORTATION

APPROVED

Forstate Traffic Engineer

DATE 2/13/2023 PLATE NO. M5-1.15

SHEET NO:

FILE NAME: C:\CAEfiles\Projects\tr_stdplate_M51.dgn

PROJECT NO:

PLOT DATE: 13-FEB 2023 10:05

PLOT BY : dotc4c

- 1. Signs are Type II Type H Reflective except as Shown
- 2. Color:

Background - See note 4 Message - See note 4

- 3. Corners may be square or rounded when base material is plywood but borders shall be rounded as shown. When base material is metal, the corners and borders shall be rounded.
- 4. M6-1 and M6-2 Background White Message - Black

MB6-1 and MB6-2 Background - Blue

Message - White

MK6-1 and MK6-2 Background - Green

Message - White

MM6-1 and MM6-2 Background - White

Message - Green

MN6-1 and MN6-2 Background - Brown

Message - White

M06-1 and M06-2 Background - Orange - Type F Reflective


Message - Black

MP6-1 and MP6-2 Background - White

Message - Blue

MR6-1 and MR6-2 Background - Brown

Message - Yellow

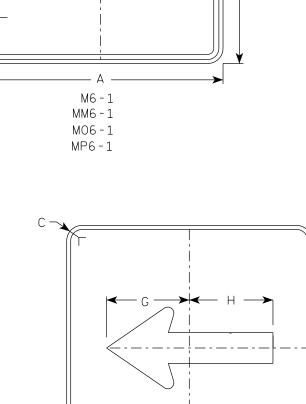


MB6-1

MK6-1

MN6-1

MR6-1

HWY:

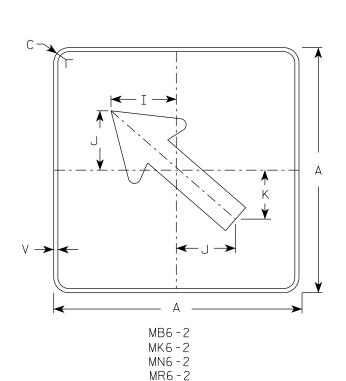


M6-2

MM6 - 2

MO6-2

MP6-2

ARROW DETAIL

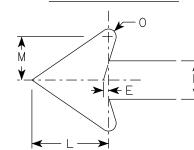

SIZE	Α	В	С	D	E	F	G	Н	I	J	К	L	М	N	0	Р	Q	R	S	Т	U	V	W	Х	Y	Z	Area sq. ft.
1																											
25	21		1 1/2	3/8	3/8		7 1/2	7 1/8	5 %	5	4 1/4	5 1/4	3	2 5/8	1/2							1/2					3.06
2M	21		1 1/2	3/8	3/8		7 1/2	7 1/8	5 %	5	4 1/4	5 1/4	3	2 5/8	1/2							1/2					3.06
3	30		1 1/8	1/2	5/8		10 3/4	10 1/4	8	7 1/4	6	7 1/2	4 1/4	3 3/4	3/4							1/2					6.25
4	30		1 1/8	1/2	5/8		10 3/4	10 1/4	8	7 1/4	6	7 1/2	4 1/4	3 3/4	3/4							1/2					6.25
5	30		1 1/8	1/2	5/8		10 3/4	10 1/4	8	7 1/4	6	7 1/2	4 1/4	3 3/4	3/4							1/2					6.25

COUNTY:

STANDARD SIGN M6-1 & M6-2 SERIES

WISCONSIN DEPT OF TRANSPORTATION

APPROVED

DATE 2/13/2023 PLATE NO. M6-1.16 SHEET NO:

For State Traffic Engineer

FILE NAME : C:\CAEfiles\Projects\tr_stdplate_M61.dgn

PROJECT NO:

 $\vee \longrightarrow$

PLOT DATE: 13-FEB 2023 1:30

PLOT BY : dotc4c

PLOT NAME :


PLOT SCALE: \$\$.....plo†scale.....\$\$ WISDOT/CADDS SHEET 42

Ε

- 1. Sign is Type II Type H Reflective
- 2. Color:

Background - White Message – Black

- 3. Message Series E
- 4. Substitute appropriate numerals and optically adjust spacing to achieve proper balance.

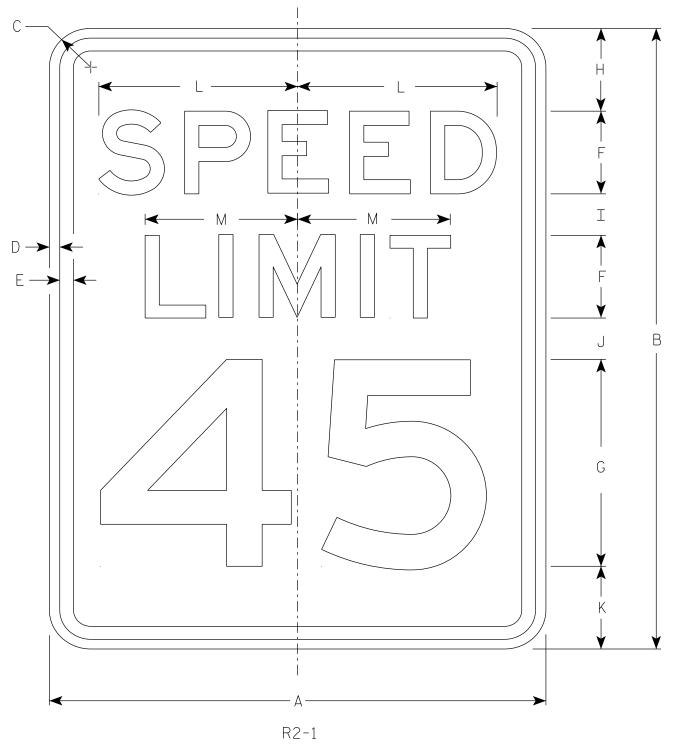

SIZE	А	В	С	D	E	F	G	Н	I	J	K	L	М	N	0	Р	Q	R	S	Т	U	٧	W	X	Y	Z	Area sq. ft.
1	18	24	1 1/2	3/8	1/2	3	8	3	2	2	3	7 1/4	5 1/2														3.0
25	24	30	1 1/2	3/8	1/2	4	10	3	2 1/4	3 3/8	3 3/8	9 5/8	7 3/8														5.0
2M	30	36	1 1/8	1/2	5/8	5	12	5	2 1/2	2 1/2	4	12	9 1/4														7.5
3	36	48	1 1/8	1/2	5/8	6	14	6	5	5	6	14 3/8	11														12.0
4	36	48	1 1/8	1/2	5/8	6	14	6	5	5	6	14 3/8	11														12.0
5	48	60	3	3/4	1	8	20	6	4 1/2	6 3/4	6 3/4	19 1/4	14 5/8														20.0

COUNTY:

STANDARD SIGN R2-1

WISCONSIN DEPT OF TRANSPORTATION

SHEET NO:

APPROVED

DATE 2/1/23

For State Traffic Engineer PLATE NO. R2-1.14

HWY:

PROJECT NO:

PLOT DATE: 9-JULY 2024 1:47

PLOT BY : mscj9h


PLOT NAME :

2. Color:

Background - AS SHOWN Message - BLACK

3. Message Series - C or as noted



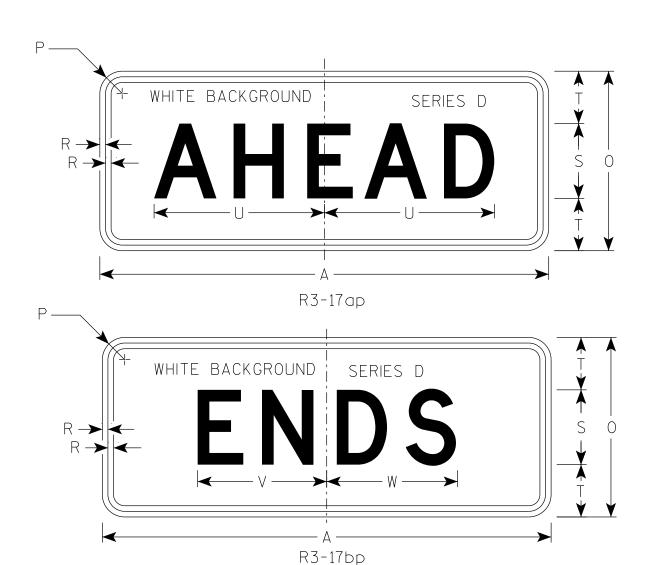

																											R3-17	R3-17ap	R3-17bp
SIZE	Α	В	С	D	E	F	G	Н	I	J	K	L	М	Ν	0	Р	Q	R	S	T	U	٧	W	Х	Y	Z	Area sq. ft.	Area sq. ft.	Area sq. ft.
1																													
25	30	24	1 1/2	3/8	1/2	2	4	4 1/8	7 1/8	6 3/8	9 1/2	2 5/8	7/8	13	12	1 1/2	3 3/8	3/8	5	3 1/2	11 3/8	8 %	8 3/4	2 3/8	15 %	8	5.0	2.5	2.5
2M	30	24	1 1/2	3/8	1/2	2	4	4 1/8	7 1/8	6 3/8	9 1/2	2 5/8	7/8	13	12	1 1/2	3 3/8	3/8	5	3 1/2	11 3/8	8 5/8	8 3/4	2 3/8	15 5/8	8	5.0	2.5	2.5
3																													
4																													
5																													
				•	•	•									•	•	•	•	•	•				•			•		•

STANDARD SIGN
R3-17 & R3-170&DP

WISCONSIN DEPT OF TRANSPORTATION

APPROVED

Matther R Rauch

For State Traffic Engineer

DATE 2/23/23 PLATE NO. R3-17.3

SHEET NO:

FILE NAME : C:\CAEfiles\Projects\tr_stdplate\R317.dgn

PROJECT NO:


PLOT DATE: 23-FEB 2023 9:44

PLOT BY: mscj9h


- 1. Sign is Type II Type H Reflective
- 2. Color:

Background - White Message - Black

3. Message Series - E

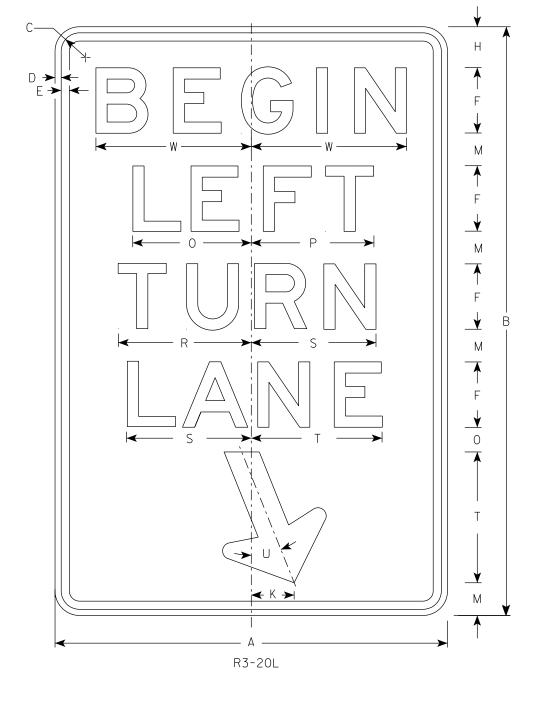

HWY:

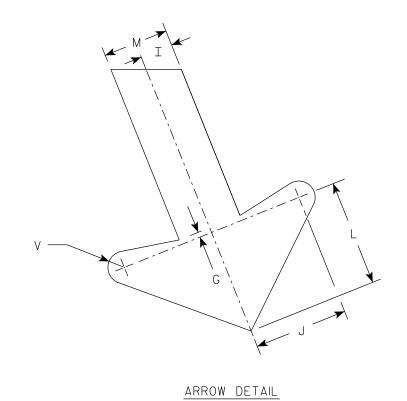

l ——																											
SIZE	Α	В	С	D	E	F	G	Н	I	J	K	L	M	N	0	Р	Q	R	S	T	U	٧	W	Χ	Y	Z	Area sq. ft.
1																											
25	24	36	1 1/2	3/8	1/2	4	1/4	2 1/2	1	2 1/8	2 %	3 1/4	2	1 1/2	7 1/4	7 1/2		8 1/8	7 5/8	8	22°	1/2	9 1/2				6.0
2M	24	36	1 1/2	3/8	1/2	4	1/4	2 1/2	1	2 1/8	2 %	3 1/4	2	1 1/2	7 1/4	7 1/2		8 1/8	7 5/8	8	22°	1/2	9 1/2				6.0
3	36	54	1 1/8	1/2	5/8	6	3/8	3 3/4	1 1/2	4 1/4	4	4 1/8	3	2 1/4	10 1/8	11 1/4		12 1/4	11 1/2	12	22°	3/4	13 1/4				13.5
4																											
5																											

COUNTY:

STANDARD SIGN R3-20L

WISCONSIN DEPT OF TRANSPORTATION

For State Traffic Engineer

DATE 2/23/23 PLATE NO. <u>R3-20L.8</u>

SHEET NO:

PLOT SCALE: \$\$.....plotscale.....\$\$ WISDOT/CADDS SHEET 42

FILE NAME : C:\CAEfiles\Projects\tr_stdplate\R320L.dgn

PROJECT NO:

PLOT DATE: 23-FEB 2023 10:26

PLOT BY: mscj9h


PLOT NAME :


- 1. Sign is Type II Type H Reflective
- 2. Color:

Background - White Message – Black


3. R4-8 is the same as R4-7 except Legend is reversed.

DIVIDER DETAIL

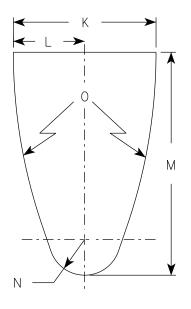

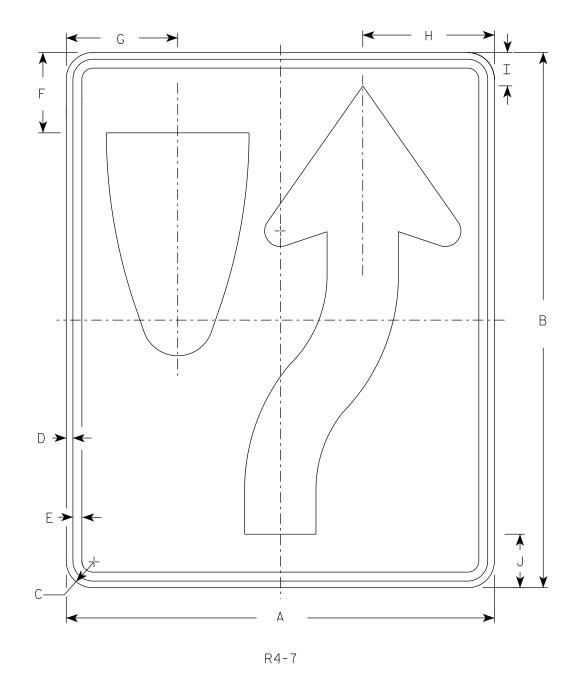

ARROW DETAIL

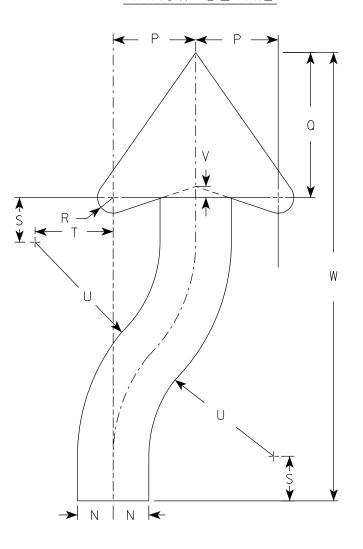

SIZE	А	В	С	D	E	F	G	Н	I	J	K	L	М	N	0	Р	Q	R	S	Т	U	٧	W	Х	Y	Z	Area sq. ft.
1	18	24	1 1/2	3/8	1/2	3 3/8	4 3/4	5 1/2	1 3/8	2 1/4	6	3	9 3/8	1 1/2	22 1/2	3 1/2	6 1/8	5/8	1 1/8	3 1/4	6 3/4	1/2	20 3/8				3.0
25	24	30	1 1/2	3/8	1/2	4 1/2	6 1/4	7 3/8	1 1/8	3	8	4	12 1/2	2	30	4 5/8	8 1/8	7/8	2 1/2	4 3/8	9	5/8	25 1/8				5.0
2M	24	30	1 1/2	3/8	1/2	4 1/2	6 1/4	7 3/8	1 1/8	3	8	4	12 1/2	2	30	4 5/8	8 1/8	7/8	2 1/2	4 3/8	9	5/8	25 1/8				5.0
3	36	48	1 1/8	1/2	5/8	6 3/4	9 3/8	11 1/8	2 1/8	4 1/2	12	6	18 3/4	3	45	6 1/8	12 1/4	1 1/4	3 3/4	6	13 1/2	1	40 3/4				12.0
4	36	48	1 1/8	1/2	5/8	6 3/4	9 3/8	11 1/8	2 1/8	4 1/2	12	6	18 3/4	3	45	6 1/8	12 1/4 1	1 1/4	3 3/4	6	13 1/2	1	40 3/4				12.0
5	48	60	3	3/4	1	9	12 1/2	14 3/4	3 3/4	6	16	8	25	4	60	9 1/4	16 1/4	1	5	8 3/4	18	1 1/4	50 1/4				20.0

STANDARD SIGN R4-7 & R4-8

WISCONSIN DEPT OF TRANSPORTATION

APPROVED

For State Traffic Engineer DATE 8/17/23 PLATE NO. R4-7.9

SHEET NO:

FILE NAME : C:\CAEfiles\Projects\tr_stdplate\R47.dgn

HWY:

PROJECT NO:

COUNTY:

PLOT DATE: 17-AUG 2023 12:39


PLOT BY : mscj9h

PLOT NAME :

- 1. Sign is Type II Type H Reflective
- 2. Color:

Background - See detail Message - White

3. Message Series - D

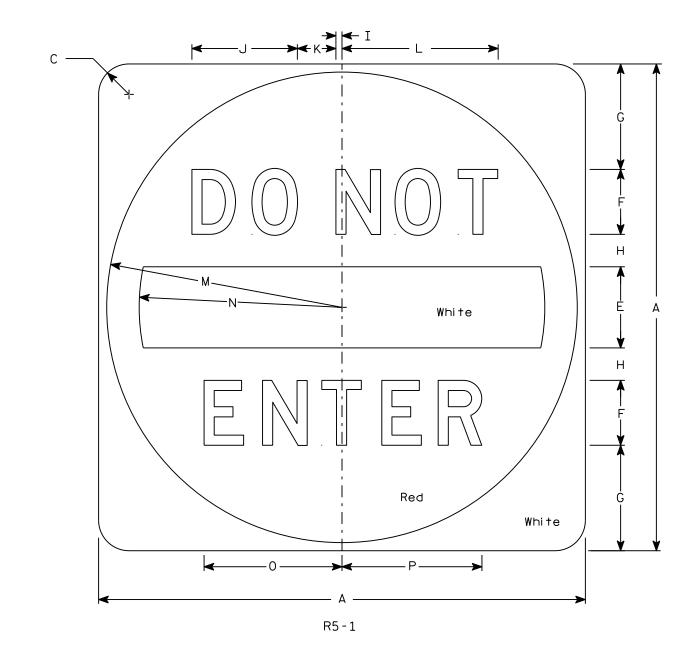

SIZE	Α	В	С	D	E	F	G	Н	I	J	К	L	М	N	0	Р	Q	R	S	Т	U	٧	W	Х	Υ	Z	Area sq. ft.
1																											
25	30		1 1/8		5	4	6 1/2	2	3/8	6 1/2	2 3/8	9 %	14 1/2	12 1/2	8 1/2	8 %											6.25
2M	36		2 1/4		6	5	7 1/2	2 1/2	1/2	8 1/8	3	12 1/8	17 1/2	15	10 %	10 3/4											9.0
3	36		2 1/4		6	5	7 1/2	2 1/2	1/2	8 1/8	3	12 1/8	17 1/2	15	10 %	10 3/4											9.0
4	36		2 1/4		6	5	7 1/2	2 1/2	1/2	8 1/8	3	12 1/8	17 1/2	15	10 %	10 ¾											9.0
5	48		3		8	6	11	3	5/8	9 3/4	3 5/8	14 1/2	23 1/2	20	12 3/4	12 1/8											16.0

COUNTY:

STANDARD SIGN R5-1

WISCONSIN DEPT OF TRANSPORTATION

APPROVED

Matther & Rauch


DATE <u>3/15/18</u>

8 PLATE NO. R5-1.16
SHEET NO:

PLOT SCALE : 5.914594:1.000000

HWY:

PROJECT NO:

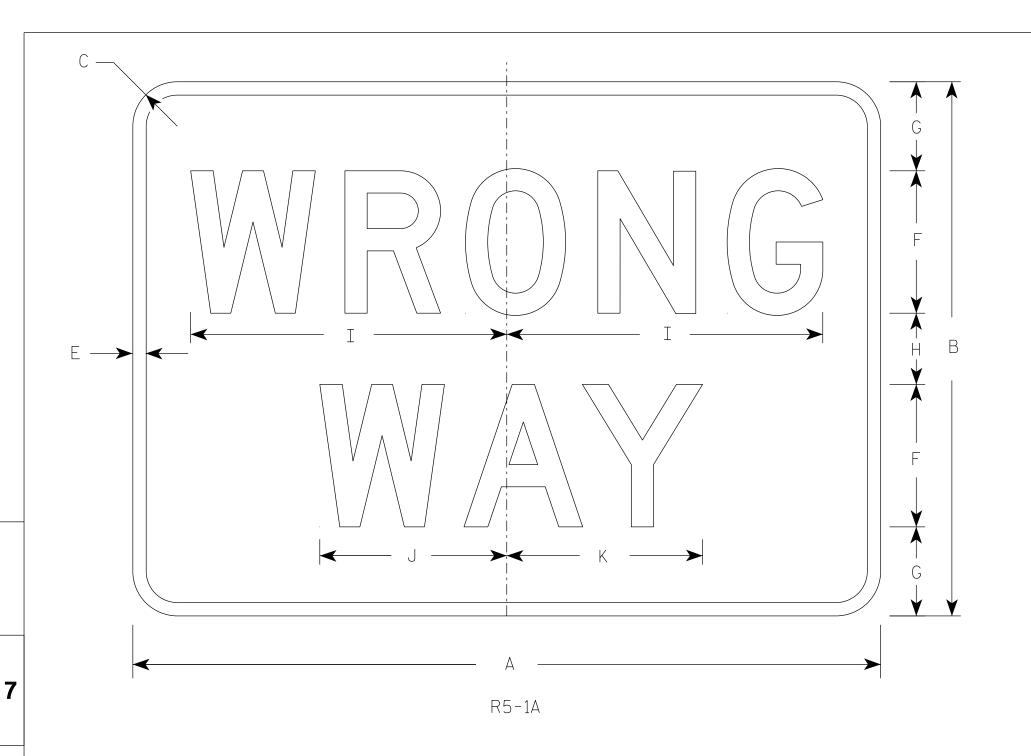

- 1. Sign is Type II Type H Reflective
- 2. Color:

Background - Red Message - White

3. Message Series - D

SIZE	А	В	С	D	Е	F	G	Н	I	J	K	L	М	N	0	Р	Q	R	S	Т	U	٧	W	X	Y	Z	Area sq. ft.
1	30	18	1 1/2		1/2	5	3	2	11	6 1/2	6 1/8																3.75
25	36	24	1 1/2		5/8	6	4 1/2	3	13 1/4	7 1/8	8 1/4																6.00
2M	42	30	1 1/8		3/4	8	5	4	17 3/4	10 1/2	11																8.75
3	42	30	1 1/8		3/4	8	5	4	17 3/4	10 1/2	11																8.75
4	42	30	1 1/8		3/4	8	5	4	17 3/4	10 1/2	11																8.75
5	42	30	1 1/8		3/4	8	5	4	17 3/4	10 1/2	11																8.75

STANDARD SIGN R5-1A

WISCONSIN DEPT OF TRANSPORTATION

SHEET NO:

APPROVED

PLATE NO. <u>R5-1</u>A.3

PROJECT NO:

COUNTY: PLOT DATE: 17-AUG 2023 2:56

PLOT BY : mscj9h

PLOT NAME :

PLOT SCALE: \$\$.....plotscale.....\$\$ wisdot/cadds sheet 42

HWY:



- 1. Sign is Type II Type H Reflective
- 2. Color:


Background - White Message - Red

- 3. Message Series See Note 4
- 4. Lines 1, 3 and 4 are series C, line 2 is series B.
- 5. R7-1D (double arrow)

R7-1L (left arrow)

R7-1R (right arrow)

ARROW DETAIL

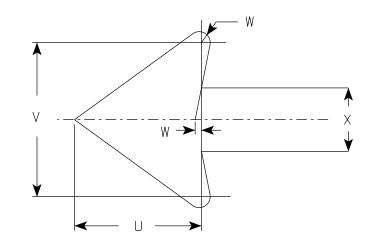

R7-1

SIZE	А	В	С	D	E	Ŀ	G	Ι	I	٦	K	L	М	N	0	Р	Q	R	S	Т	U	٧	W	X	Y	Z	Area sq. ft.
1	12	18	1 1/2	3/8	3/8	3	1 1/8	2	7/8	5/8	1 1/2	2 1/2	2	2	4 1/8	4 1/8	2 1/4	2 1/8	2 1/2	3 1/8	1 1/2	1 3/4	1/8	3/4			1.5
25	18	24	1 1/2	3/8	1/2	4	2 1/2	2 1/2	1 1/4	1	2	3 1/4	2 3/4	2 5/8	7 1/8	7	2 3/4	2 5/8	3 1/8	5 %	2 1/4	2 5/8	1/4	1 1/8			3.0
2M	24	30	1 1/2	3/8	1/2	5	3	3	2	1 1/4	2 1/2	4	3 1/4	3 3/8	9 1/4	9 1/4	3 1/4	3 1/4	3 3/4	7 3/4	3	3 1/2	1/4	1 1/2			5.0
3	24	30	1 1/2	3/8	1/2	5	3	3	2	1 1/4	2 1/2	4	3 1/4	3 3/8	9 1/4	9 1/4	3 1/4	3 1/4	3 3/4	7 3/4	3	3 1/2	1/4	1 1/2			5.0
4																											
5																											

COUNTY:

STANDARD SIGN R7-1

WISCONSIN DEPT OF TRANSPORTATION

APPROVED

MMU/MU/MUState Traffic Engineer

SHEET NO:

DATE 10/26/23

PLATE NO. <u>R7-1.11</u>

FILE NAME : C:\Users\PROJECTS\tr_stdplate\R71.dgn

HWY:

PROJECT NO:

PLOT DATE: 26-OCT 2023 2:48


PLOT BY: mscj9h

PLOT NAME :

- 1. Sign is Type II Type H Reflective
- 2. Color:

Background - White Message - Black

- 3. Message Series C
- 4. Use Size 2 for Sidewalks. Use Size 3 for Paths and Trails.

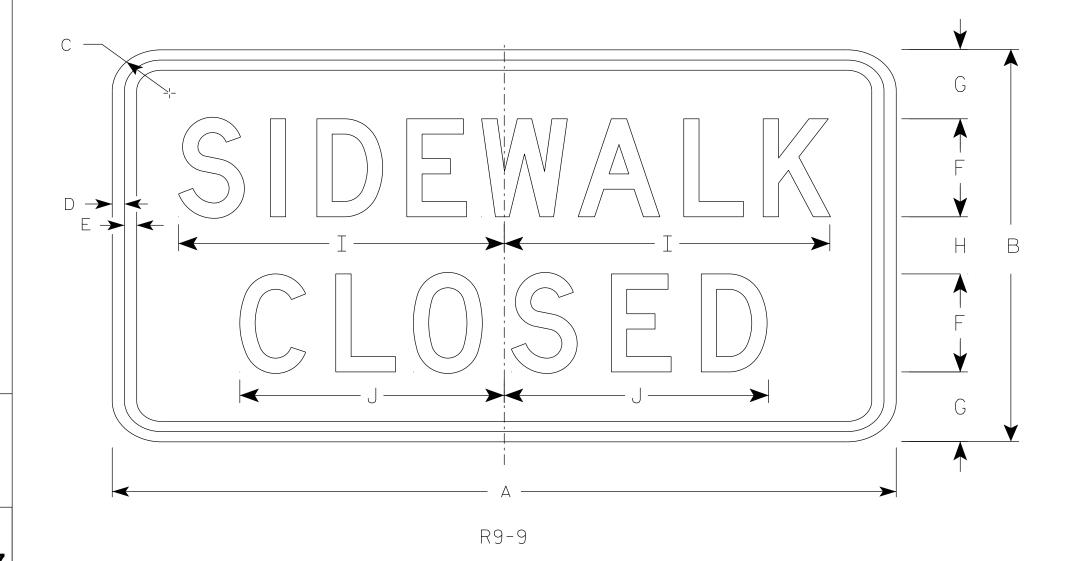

SIZE	А	В	С	D	E	F	G	Н	I	J	K	L	М	Ν	0	Р	Q	R	S	Т	U	V	W	X	Y	Z	Area sq. ft.
1																											
25	24	12	1 1/2	1/2	1/2	3	2 1/8	1 3/4	10	8 1/8																	2.0
2M	24	12	1 1/2	1/2	1/2	3	2 1/8	1 3/4	10	8 1/8																	2.0
3	30	18	1 1/2	1/2	1/2	4	3 1/2	3	12 1/2	10 1/4																	3.75
4																											
5																											

COUNTY:

STANDARD SIGN R9-9

WISCONSIN DEPT OF TRANSPORTATION

APPROVED

For State Traffic Engineer

SHEET NO:

DATE <u>1/24/24</u>

PLATE NO. <u>R9-9.7</u>

FILE NAME : C:\CAEfiles\Projects\tr_stdplate\R99.dgn

HWY:

PROJECT NO:

PLOT DATE: 24-JAN 2024 11:55

PLOT BY: mscj9h

PLOT NAME :

PLOT SCALE: \$\$.....plotscale.....\$\$WISDOT/CADDS SHEET 42


1

- 1. Sign is Type II Type H Reflective
- 2. Color:

Background - White

Message – Black

3. Message Series - D

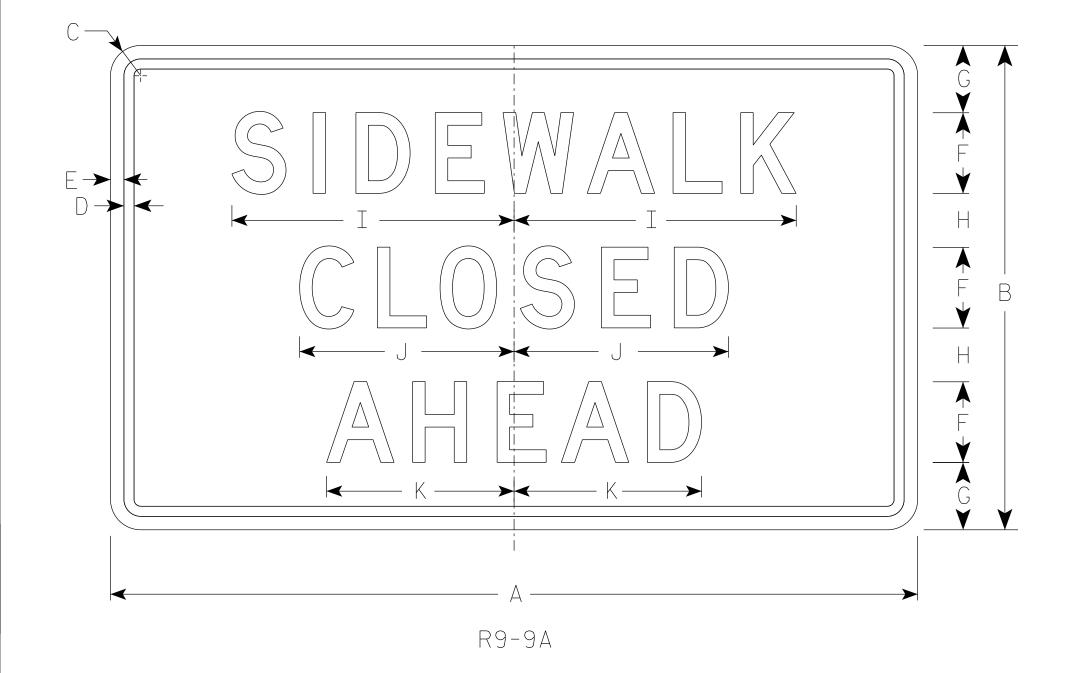

l																											
SIZE	А	В	С	D	E	F	G	Н	I	J	K	L	М	N	0	Р	Q	R	S	Т	U	V	W	X	Y	Z	Area sq. ft.
1																											
25	30	18	1 1/2	3/8	1/2	3	2 1/2	2	10 1/2	8	7																3.75
2M	30	18	1 1/2	3/8	1/2	3	2 1/2	2	10 1/2	8	7																3.75
3																											
4																											
5																											
PRC	JECT	NO:					НΛ	WY:					COU	NTY:													

STANDARD SIGN R9-9A

WISCONSIN DEPT OF TRANSPORTATION

APPROVED Matthew f_{or} State Traffic Engineer


DATE 1/24/24 PLATE NO. R9-9A.2 SHEET NO:

Ε

FILE NAME : C:\CAEFiles\Projects\tr_stdplate\R99A.DGN

PLOT DATE : 24-JAN 2024 11:58

PLOT BY: mscj9h

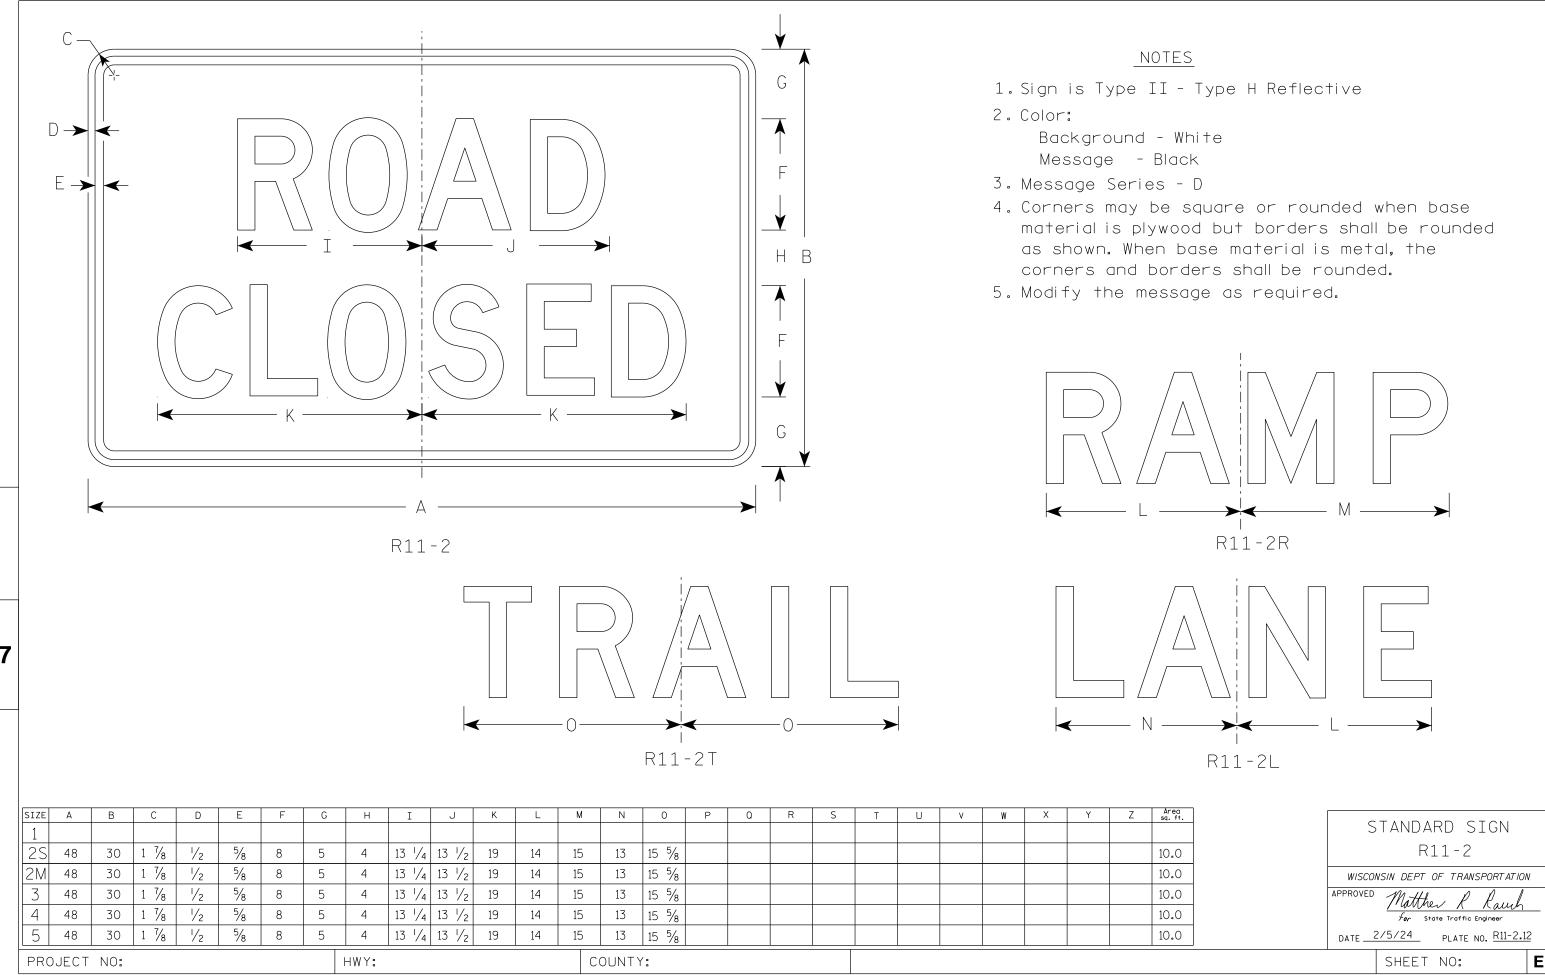

FILE NAME : C:\Users\PROJECTS\tr_stdplate\R112.dgn

PLOT DATE: 5-FEB 2024 2:10

PLOT BY: mscj9h

PLOT NAME :



- 1. Sign is Type II Type H Reflective
- 2. Color:

Background - White Message - Black

- 3. Message Series C
- 4. Corners may be square or rounded when base material is plywood but borders shall be rounded as shown. When base material is metal, the corners and borders shall be rounded.
- 5. Substitute appropriate numerals to nearest quarter mile and optically adjust spacing to achieve proper balance.

R11-3

** See Note 5

HWY:

В	C	D	E	F	G	Н	I	J	K	L	М	N	0	Р	Q	R	S	Т	U	٧	W	X	Υ	Z	Area sq. ft.
18	1 1/2	3/8	3/8	4	3	2	11 1/4	3	1 1/8	15 3/8	2	3 3/4	8 1/4	5/8		1 3/8	13 1/4	8 3/8	7/8	10 1/2	7 1/8				4.5
30	1 7/8	1/2	5/8	6	5	3 1/2	16 1/8	5	1 3/8	23 1/4	3	6 1/4	13	1 1/8		1 1/8	22 1/8	14	1 1/2	17 1/2	11 1/8				12.5
30	1 7/8	1/2	5/8	6	5	3 1/2	16 1/8	5	1 3/8	23 1/4	3	6 1/4	13 %	1 1/8		1 1/8	22 1/8	14	1 1/2	17 1/2	11 7/8				12.5
)	30	30 1 7/8	18 1 ½ ¾ 30 1 ⅓ ½	18 1 ½ 3/8 3/8 30 1 7/8 ½ 5/8	18 1 ½ 3/8 3/8 4 30 1 7/8 ½ 5/8 6	18 1 ½ 3/8 3/8 4 3 30 1 ½ ½ 5/8 6 5	18 1 ½ 3/8 3/8 4 3 2 30 1 ½ 5/8 6 5 3 ½	18 1 ½ 3/8 3/8 4 3 2 11 ¼ 30 1 ½ 5/8 6 5 3 ½ 16 ¾	18 1 ½ 3/8 3/8 4 3 2 11 ¼ 3 30 1 ¾ ½ 5/8 6 5 3 ½ 16 ¾ 5	18 1 ½ 3/8 3/8 4 3 2 11 ¼ 3 1 ⅓ 30 1 ¾ ½ 5/8 6 5 3 ½ 16 ¾ 5 1 ¾	18 1 ½ 3/8 3/8 4 3 2 11 ¼ 3 1 ½ 15 3/8 30 1 ¾ ½ 5/8 6 5 3 ½ 16 ¾ 5 1 ¾ 23 ¼	18 1 ½ 3/8 3/8 4 3 2 11 ¼ 3 1 ½ 15 3/8 2 30 1 ¾ ½ 5/8 6 5 3 ½ 16 ¾ 5 1 3/8 23 ¼ 3	18 1 ½ 3/8 3/8 4 3 2 11 ¼ 3 1 ⅓ 15 ¾ 15 ¾ 2 3 ¾ 30 1 ¾ ½ 5/8 6 5 3 ½ 16 ¾ 5 1 ¾ 23 ¼ 3 6 ¼	18 1 ½ 3/8 3/8 4 3 2 11 ¼ 3 1 ⅓ 15 ¾ 2 3 ¾ 8 ¼ 30 1 ¾ ½ 5/8 6 5 3 ½ 16 ¾ 5 1 ¾ 23 ¼ 3 6 ¼ 13 ¾	18 1 ½ 3/8 3/8 4 3 2 11 ¼ 3 1 ⅓ 15 ¾ 2 3 ¾ 8 ¼ 5/8 30 1 ¾ ½ 5/8 6 5 3 ½ 16 ¾ 5 1 ¾ 23 ¼ 3 6 ¼ 13 ¾ 1 ½	18 1 ½ 3/8 3/8 4 3 2 11 ¼ 3 1 ⅓ 15 ¾ 2 3 ¾ 8 ¼ 5/8 30 1 ¾ ½ 5/8 6 5 3 ½ 16 ¾ 5 1 ¾ 23 ¼ 3 6 ¼ 13 ¾ 1 ½	18 1 ½ 3/8 3/8 4 3 2 11 ¼ 3 1 ⅓ 15 ¾ 2 3 ¾ 8 ¼ 5/8 1 ¾ 30 1 ¾ ½ 5/8 6 5 3 ½ 16 ¾ 5 1 ¾ 23 ¼ 3 6 ¼ 13 ½ 1 ½	18 1 ½ 3/8 3/8 4 3 2 11 ¼ 3 1 ⅓8 15 ¾8 2 3 ¾4 8 ¼4 5/8 1 ¾8 13 ¼4 30 1 ¾8 ½ 5/8 6 5 3 ½ 16 ¾8 5 1 ¾8 23 ¼4 3 6 ¼4 13 ½8 1 ⅓8 1 ¾8 22 ⅓8	18 1 ½ 3/8 3/8 4 3 2 11 ¼ 3 1 ⅓8 15 ¾8 2 3 ¾4 8 ¼4 5/8 1 ¾8 13 ¼4 8 ¾8 30 1 ¾8 ½ 5/8 6 5 3 ½ 16 ¾8 5 1 ¾8 23 ¼4 3 6 ¼4 13 ½8 1 ⅓8 1 ¾8 12 ½8 14	18 1 ½ 3/8 3/8 4 3 2 11 ¼ 3 1 ⅓8 15 ¾8 2 3 ¾4 8 ¼4 5/8 1 ¾8 13 ¼4 8 ¾8 ½8 30 1 ¾8 ½ 5/8 6 5 3 ½ 16 ¾8 5 1 ¾8 23 ¼4 3 6 ¼4 13 ½8 1 ⅓8 11 ¾8 22 ⅓8 14 1 ½2	18 1 ½ 3/8 3/8 4 3 2 11 ¼ 3 1 ⅓8 15 ¾8 2 3 ¾4 8 ¼4 5/8 1 ¾8 13 ¼4 8 ¾8 ¼8 10 ½ 30 1 ¾8 ½ 5/8 6 5 3 ½ 16 ¾8 5 1 ¾8 23 ¼4 3 6 ¼4 13 ½8 1 ⅓8 1 ¾8 12 ½8 14 1 ½2 17 ½2	18 1 ½ 3/8 3/8 4 3 2 11 ¼ 3 1 ⅓ 15 ¾ 2 3 ¾ 8 ¼ 5/8 1 ¾ 1 ¾ 1 ¾ 1 ¾ 1 ¾ 1 ¾ 1 ¾ 1 ¾ 1 ¾ 1 ¾ 1 ¾ 1 ¾ 1 ¾ 1 ¾ 1 ¾ 1 ¾ 1 ¾ 1 ¼ 1 ½ 1 ¼ 1 ¼ 1 ¼ 1 ½ 1 ¼ <t< td=""><td>18 1 ½ 3/8 3/8 4 3 2 11 ¼ 3 1 ⅓ 15 ¾ 2 3 ¾ 8 ¼ 5/8 1 ¾ 1 ¾ 1 ¾ 1 ¾ 1 ½ 1 ¾ 1 ¾ 1 ¾ 1 ¾ 1 ¾ 1 ¾ 1 ¾ 1 ¾ 1 ¾ 1 ¾ 1 ¾ 1 ¾ 1 ¼ 1 ¼ 1 ¼ 1 ¼ 1 ¼ 1 ½ <t< td=""><td>18 1 ½ 3/8 3/8 4 3 2 11 ¼ 3 1 ⅓ 15 ¾ 2 3 ¾ 8 ¼ 5/8 1 ¾ 1 ¾ 1 ¾ 1 ¾ 1 ¾ 1 ¾ 1 ¾ 1 ¾ 1 ¾ 1 ¾ 1 ¾ 1 ¾ 1 ¾ 1 ¾ 1 ¾ 1 ¾ 1 ¾ 1 ¾ 1 ¼ 1 ¼ 1 ¼ 1 ¼ 1 ½ <t< td=""><td>18 1 ½ 3/8 3/8 4 3 2 11 ¼ 3 1 ⅓ 15 ¾ 2 3 ¾ 8 ¼ 5/8 1 ¾ 1 ¾ 1 ¾ 1 ¾ 1 ¾ 1 ¾ 1 ¾ 1 ¾ 1 ¾ 1 ¾ 1 ¾ 1 ¾ 1 ¾ 1 ¾ 1 ¾ 1 ¾ 1 ¾ 1 ¾ 1 ¼ <t< td=""></t<></td></t<></td></t<></td></t<>	18 1 ½ 3/8 3/8 4 3 2 11 ¼ 3 1 ⅓ 15 ¾ 2 3 ¾ 8 ¼ 5/8 1 ¾ 1 ¾ 1 ¾ 1 ¾ 1 ½ 1 ¾ 1 ¾ 1 ¾ 1 ¾ 1 ¾ 1 ¾ 1 ¾ 1 ¾ 1 ¾ 1 ¾ 1 ¾ 1 ¾ 1 ¼ 1 ¼ 1 ¼ 1 ¼ 1 ¼ 1 ½ <t< td=""><td>18 1 ½ 3/8 3/8 4 3 2 11 ¼ 3 1 ⅓ 15 ¾ 2 3 ¾ 8 ¼ 5/8 1 ¾ 1 ¾ 1 ¾ 1 ¾ 1 ¾ 1 ¾ 1 ¾ 1 ¾ 1 ¾ 1 ¾ 1 ¾ 1 ¾ 1 ¾ 1 ¾ 1 ¾ 1 ¾ 1 ¾ 1 ¾ 1 ¼ 1 ¼ 1 ¼ 1 ¼ 1 ½ <t< td=""><td>18 1 ½ 3/8 3/8 4 3 2 11 ¼ 3 1 ⅓ 15 ¾ 2 3 ¾ 8 ¼ 5/8 1 ¾ 1 ¾ 1 ¾ 1 ¾ 1 ¾ 1 ¾ 1 ¾ 1 ¾ 1 ¾ 1 ¾ 1 ¾ 1 ¾ 1 ¾ 1 ¾ 1 ¾ 1 ¾ 1 ¾ 1 ¾ 1 ¼ <t< td=""></t<></td></t<></td></t<>	18 1 ½ 3/8 3/8 4 3 2 11 ¼ 3 1 ⅓ 15 ¾ 2 3 ¾ 8 ¼ 5/8 1 ¾ 1 ¾ 1 ¾ 1 ¾ 1 ¾ 1 ¾ 1 ¾ 1 ¾ 1 ¾ 1 ¾ 1 ¾ 1 ¾ 1 ¾ 1 ¾ 1 ¾ 1 ¾ 1 ¾ 1 ¾ 1 ¼ 1 ¼ 1 ¼ 1 ¼ 1 ½ <t< td=""><td>18 1 ½ 3/8 3/8 4 3 2 11 ¼ 3 1 ⅓ 15 ¾ 2 3 ¾ 8 ¼ 5/8 1 ¾ 1 ¾ 1 ¾ 1 ¾ 1 ¾ 1 ¾ 1 ¾ 1 ¾ 1 ¾ 1 ¾ 1 ¾ 1 ¾ 1 ¾ 1 ¾ 1 ¾ 1 ¾ 1 ¾ 1 ¾ 1 ¼ <t< td=""></t<></td></t<>	18 1 ½ 3/8 3/8 4 3 2 11 ¼ 3 1 ⅓ 15 ¾ 2 3 ¾ 8 ¼ 5/8 1 ¾ 1 ¾ 1 ¾ 1 ¾ 1 ¾ 1 ¾ 1 ¾ 1 ¾ 1 ¾ 1 ¾ 1 ¾ 1 ¾ 1 ¾ 1 ¾ 1 ¾ 1 ¾ 1 ¾ 1 ¾ 1 ¼ <t< td=""></t<>

COUNTY:

STANDARD SIGN R11-3

WISCONSIN DEPT OF TRANSPORTATION

APPROVED Matther & Rawh

For State Traffic Engineer

SHEET NO:

DATE <u>2/5/24</u> PLATE NO. <u>R11-3.10</u>

Ε

FILE NAME : C:\CAEfiles\Projects\tr_stdplate\R113.DGN

PROJECT NO:

PLOT DATE : 5-FEB 2024 2:30


PLOT BY: mscj9h

PLOT NAME :

- 1. Sign is Type II Type H Reflective
- 2. Color:

Background - White Message - Black

- 3. Message Series C
- 4. Corners may be square or rounded when base material is plywood but borders shall be rounded as shown. When base material is metal, the corners and borders shall be rounded.

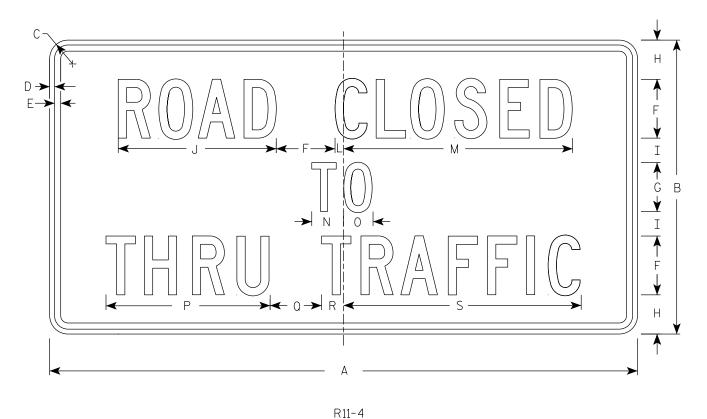

K11-2

SIZE	Α	В	С	D	E	F	G	Ι	I	J	K	L	М	N	0	Р	Q	R	S	Т	U	٧	W	X	Υ	Z	Area sq. ft.
1																											
25	60	30	1 1/8	1/2	5/8	6	5	4	2 1/2	16 1/8		7/8	23 3/8	3 1/4	3	16 3/4	5 1/4	2 1/4	24 1/4								12.5
2M	60	30	1 1/8	1/2	5/8	6	5	4	2 1/2	16 1/8		7/8	23 3/8	3 1/4	3	16 3/4	5 1/4	2 1/4	24 1/4								12.5
3																											
4																											
5																											

COUNTY:

STANDARD SIGN R11 - 4

WISCONSIN DEPT OF TRANSPORTATION

APPROVED

Matthew K Kaul For State Traffic Engineer

SHEET NO:

DATE 2/5/24

PLATE NO. R11-4.4

FILE NAME : C:\CAEfiles\Projects\tr_stdplate\R114.dgn

HWY:

PROJECT NO:

PLOT DATE : 5-FEB 2024 2:54

PLOT BY: mscj9h

PLOT NAME: PLOT SCALE: \$\$.

PLOT SCALE: \$\$.....plotscale.....\$\$ WISDOT/CADDS SHEET 42


7

- 1. Sign is Type II Type H Reflective
- 2. Color:

Background - White

Message - Black

3. Message Series - D

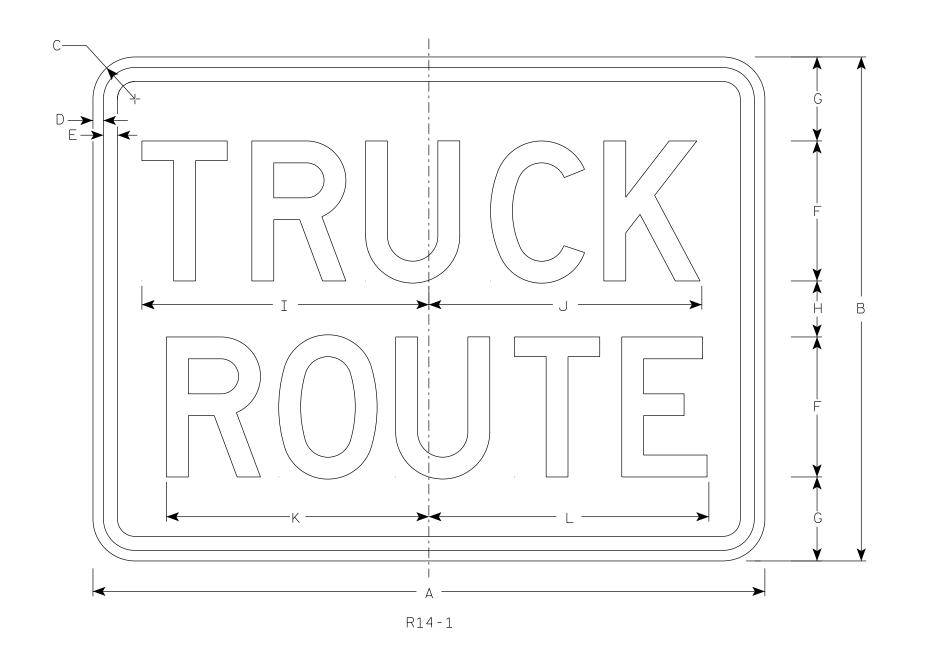

SIZE	А	В	С	D	E	F	G	Н	I	J	К	L	М	N	0	Р	Q	R	S	T	U	٧	W	Х	Y	Z	Area sq. ft.
1																											
25	24	18	1 1/2	3/8	1/2	5	3	2	10 1/4	9 3/4	9 3/8	10															3.0
2M	24	18	1 1/2	3/8	1/2	5	3	2	10 1/4	9 3/4	9 3/8	10															3.0
3	30	24	1 1/2	3/8	1/2	6	4	4	12 1/4	11 3/4	11 1/4	12															5.0
4																											
5																											

COUNTY:

STANDARD SIGN R14-1

WISCONSIN DEPT OF TRANSPORTATION

APPROVED

DATE 2/9/24 PLATE NO. R14-1.7

SHEET NO:

 $f_{\it or}$ State Traffic Engineer

Ε

FILE NAME : C:\CAEfiles\Projects\tr_stdplate\R141.dgn

HWY:

PROJECT NO:

PLOT DATE: 9-FEB 2024 9:27

PLOT BY: mscj9h

PLOT NAME :

- 1. Sign is Type II Type F Reflective
- 2. Color:

Background - Yellow Message – Black

3. W4-2L is the same as W4-2R except the symbolis reversed along the vertical centerline.

D E	
	F
	F
$A \longrightarrow I \cup J \longrightarrow G \longrightarrow I \cup J \cup G \longrightarrow G$	
c	

W4-2R

SIZE	А	В	С	D	E	F	G	Н	I	J	K	L	М	N	0	Р	Q	R	S	Т	U	٧	W	Х	Y	Z	Area sq. ft.
1	30		1 1/8	1/2	5/8	10	3 3/8	45°	7/8	1 1/2	4 1/4	2 1/2	1 1/4														6.25
25	36		2 1/4	5/8	3/4	12	4	45°	1	1 3/4	5	3	1 1/2														9.0
2M	36		2 1/4	5/8	3/4	12	4	45 °	1	1 3/4	5	3	1 1/2														9.0
3	36		2 1/4	5/8	3/4	12	4	45 °	1	1 3/4	5	3	1 1/2														9.0
4	48		3	3/4	1	16	5 3/8	45°	1 1/4	2 3/8	6 3/4	4	2														16.0
5	48		3	3/4	1	16	5 3/8	45°	1 1/4	2 3/8	6 3/4	4	2														16.0

STANDARD SIGN W4-2

WISCONSIN DEPT OF TRANSPORTATION

APPROVED Matther For State Traffic Engineer

DATE 8/31/2023 PLATE NO. W4-2.15

SHEET NO:

WISDOT/CADDS SHEET 42

Ε

PLOT DATE : 31-AUG 2023 11:15

PLOT BY : dotc4c

PROJECT NO:



- 1. Sign is Type II Type F Reflective
- 2. Color:

Background - Yellow Message - Black

- 3. Message Series D
- 4. W9-1L same as W9-1R except the word Left replaces Right.

										Y																	
SIZE	А	В	С	D	Е	F	G	Н	I	J	K	L	М	N	0	Р	Q	R	S	Т	U	٧	W	Х	Y	Z	Area sq. ft.
1	30		1 1/8	1/2	5/8	5	1 1/2	2 1/2	7 1/8	7 5/8	9 1/4	8 1/8	7 5/8	8 5/8													6.25
25	36		2 1/4	5/8	3/4	6	2	3	8 1/2	9 1/8	11	9 3/4	9	10 3/8													9.0
2M	36		2 1/4	5/8	3/4	6	2	3	8 1/2	9 1/8	11	9 3/4	9	10 3/8													9.0
3	36		2 1/4	5/8	3/4	6	2	3	8 1/2	9 1/8	11	9 3/4	9	10 3/8													9.0
4	36		2 1/4	5/8	3/4	6	2	3	8 1/2	9 1/8	11	9 3/4	9	10 3/8													9.0
5	48		3	3/4	1	8	3	4	11 1/4	12 1/4	14 3/4	12 1/8	12 1/4	13 5/8													16.0

W9-1R

STANDARD SIGN W9-1

WISCONSIN DEPT OF TRANSPORTATION

APPROVED Matthe R Rau

DATE 11/9/2023 PLATE NO. W9-1.9

PROJECT NO: SHEET NO:

FILE NAME : C:\CAEfiles\Projects\tr_stdplate\\91.dgn

PLOT DATE: 9-NOV 2023 1:03


PLOT BY : dotc4c

WISDOT/CADDS SHEET 42



Background - Yellow Message - Black

- 3. Message Series E
- 4. Size 4 and 5 shall be Type I Type F Reflective

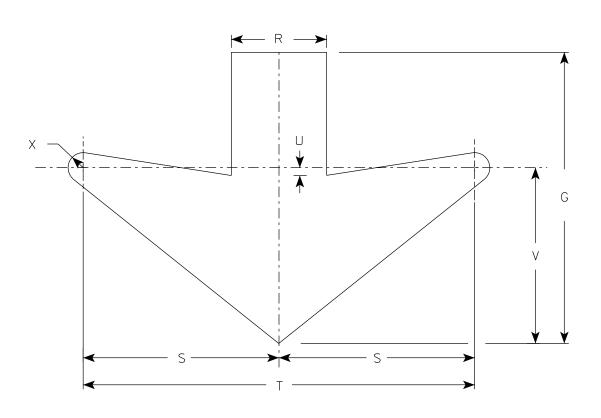

ARROW DETAIL

SIZE	Α	В	С	D	E	F	G	Н	I	J	K	L	М	N	0	Р	Q	R	S	Т	U	V	W	Х	Y	Z	Area sq. ft.
1	48	60	3	3/4	1	8	14 1/2	5	4	3 1/2	15 1/4	15 3/8	17 3/8	17 1/4	17 3/4	10 1/2		4 3/4	9 3/4	19 1/2	3/4	8 3/4	5	3/4			20.0
25	48	60	3	3/4	1	8	14 1/2	5	4	3 1/2	15 1/4	15 3/8	17 3/8	17 1/4	17 3/4	10 1/2		4 3/4	9 3/4	19 1/2	3/4	8 3/4	5	3/4			20.0
2M	48	60	3	3/4	1	8	14 1/2	5	4	3 1/2	15 1/4	15 3/8	17 3/8	17 1/4	17 3/4	10 1/2		4 3/4	9 3/4	19 1/2	3/4	8 3/4	5	3/4			20.0
3	48	60	3	3/4	1	8	14 1/2	5	4	3 1/2	15 1/4	15 3/8	17 3/8	17 1/4	17 3/4	10 1/2		4 3/4	9 3/4	19 1/2	3/4	8 3/4	5	3/4			20.0
4	72	90	6	1	1 1/2	12	22	8	6	5	23	23	26 1/8	26 1/8	26 %	16		6 1/2	15	30	2	15	7	1			45.0
5	72	90	6	1	1 1/2	12	22	8	6	5	23	23	26 1/8	26 1/8	26 %	16		6 1/2	15	30	2	15	7	1			45.0

W9-62

STANDARD SIGN W9-62

WISCONSIN DEPT OF TRANSPORTATION

APPROVED

Matthew R Rauch

For State Traffic Engineer

DATE 11/13/2023 PLATE NO. W9-62.12

SHEET NO:

PROJECT NO:

FILE NAME: C:\CAEfiles\Projects\tr_stdplate\W962.dgn

PLOT DATE: 13-NOV 2023 7:53

PLOT BY : dotc4c

WISDOT/CADDS SHEET 42

Ε

TEOT BATE .

7

- 1. Sign is Type II Type F Reflective
- 2. Color:

Background - Yellow Message - Black

F
A DE
W11-2

SIZE	Δ	В		П	F	l F	G	Гн	Т		K		М	l N	Ι ο	Р	Q	R	S	Т	Ιυ	l v	l w	l x	Y	7	Area sq. ft.
1	24		1 1/2	3/8	1/2	9 3/4		7 1/8	2 1/8	5 1/8		_		.,		<u>'</u>				'		•	- "	,,	·		4.0
25	30		1 7/8	1/2	5/8	12 1/8		9 7/8	3 1/2	6 3/8																	6.25
2M	36		2 1/4	5/8	3/4	14 1/2		11 7/8	4 1/4	7 5/8																	9.0
7	36		2 1/4	5/8	3/4	14 1/2		11 7/8		7 5/8																	9.0
	48		3	3/4	1	10 3/		15 3/4																			16.0
				/4	1	19 %		15 /4	J /8	10 /4																	10.0
PRC	JECT	NO:						HWY:						COUNT	Y:												

STANDARD SIGN

W11-2

WISCONSIN DEPT OF TRANSPORTATION

APPROVED Matthew K For State Traffic Engineer

DATE <u>6/15/2023</u>

PLATE NO. <u>W11-2.9</u>

SHEET NO:

PLOT DATE: 15-JUNE 2023 3:50

PLOT BY : dotc4c

PLOT NAME :

PLOT SCALE :

WISDOT/CADDS SHEET 42


FILE NAME : C:\CAEFiles\Projects\tr_stdplate\W112.DGN



- 1. Sign is Type II Type F Reflective
- 2. Color:

Background - Yellow Message – Black

3. Message Series - C

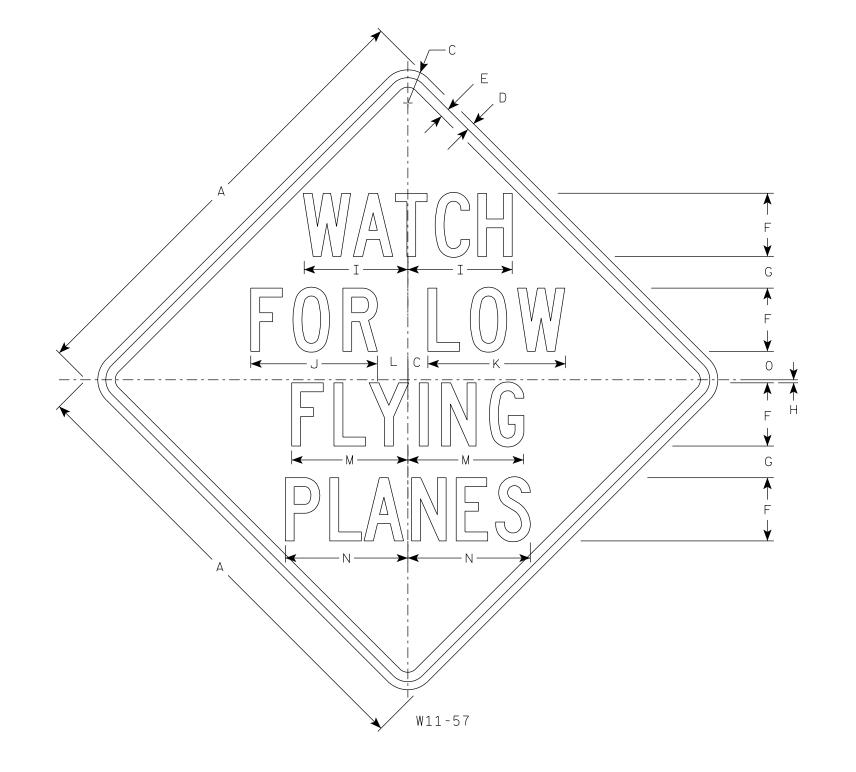

SIZE	А	В	С	D	E	F	G	Н	I	J	K	L	М	N	0	Р	Q	R	S	Т	U	V	W	X	Y	Z	Area sq. ft.
1																											
25	36		2 1/4	5/8	3/4	5	2 1/2	1/4	8 1/4	10	10 1/8	2 3/8	9 1/8	9 3/4	2 1/4												9.0
2M	36		2 1/4	5/8	3/4	5	2 1/2	1/4	8 1/4	10	10 1/8	2 3/8	9 1/8	9 3/4	2 1/4												9.0
3	48		3	3/4	1	7	3	1/2	11 5/8	14 1/8	15 1/8	3 1/2	12 1/8	13 1/2	2 1/2												16.0
4	48		3	3/4	1	7	3	1/2	11 5/8	14 1/8	15 1/8	3 1/2	12 1/8	13 1/2	2 1/2												16.0
5	48		3	3/4	1	7	3	1/2	11 5/8	14 1/8	15 1/8	3 1/2	12 1/8	13 1/2	2 1/2												16.0
PRO	JECT	NO:					Тни	VY:					Соп	NTY:													

STANDARD SIGN W11 - 57

WISCONSIN DEPT OF TRANSPORTATION

APPROVED

DATE 11/28/2023 PLATE NO. W11-57.9 SHEET NO:

PLOT DATE : 28-NOV 2023 7:41

PLOT BY : dotc4c


PLOT SCALE: \$\$.....plotscale.....\$\$ WISDOT/CADDS SHEET 42

PROJECT NO: FILE NAME : C:\CAEfiles\Projects\tr_stdplate\W1157.dgn

2. Color:

Background - Yellow Message - Black

3. W16-7R is the same as W16-7L except the arrow is reversed along the vertical centerline.

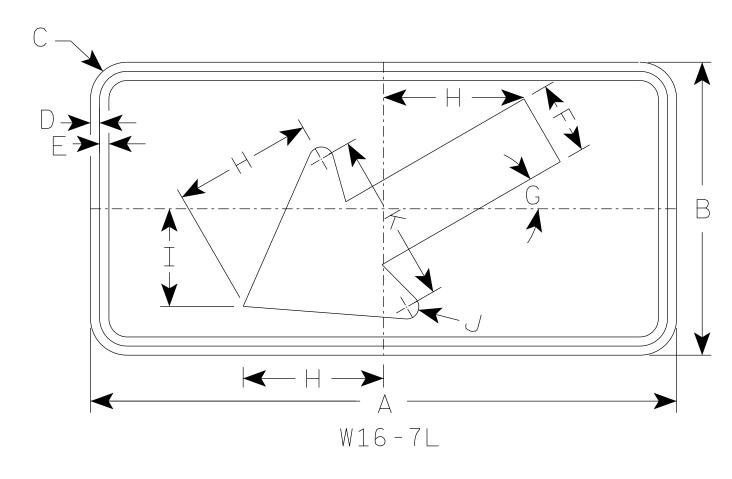

 \star For 36" \times 36" Warning Signs, use 30" \times 18" W16-7L signs.

* For 48" x 48" Warning Signs, use 48" x 24" W16-7L signs.

SIZE	Α	В	С	D	E	F	G	Н	I	J	K	L	М	N	0	Р	Q	R	S	Т	U	٧	W	X	Y	Z	Area sq. ft.
1																											
25	24	12	1 1/2	3/8	3/8	3	30°	5 3/4	4	1/2	7																2.0
* 2M	30	18	1 1/2	3/8	1/2	4 1/2	30°	8 1/2	6	5/8	10 1/4																3.75
* 3	30	18	1 1/2	3/8	1/2	4 1/2	30°	8 1/2	6	5/8	10 1/4																3.75
* 4	48	24	1 7/8	1/2	5/8	6	30°	11 1/2	8	1	14																8.0
5																											

COUNTY:

STANDARD SIGN W16-7

WISCONSIN DEPT OF TRANSPORTATION

APPROVED Matther

For State Traffic Engineer

DATE 1/9/2024 PLATE NO. W16-7.9 SHEET NO:

FILE NAME : C:\CAEfiles\Projects\tr_stdplate\W167.dgn

PROJECT NO:

HWY:

PLOT DATE: 9-Jan 2024 2:34

PLOT BY : dotc4c

PLOT NAME :


PLOT SCALE: \$\$.....plo†scale.....\$\$ WISDOT/CADDS SHEET 42

Ε

- 1. Sign is Type II Type F Reflective
- 2. Color:

Background - Yellow Message - Black

3. Message Series - C

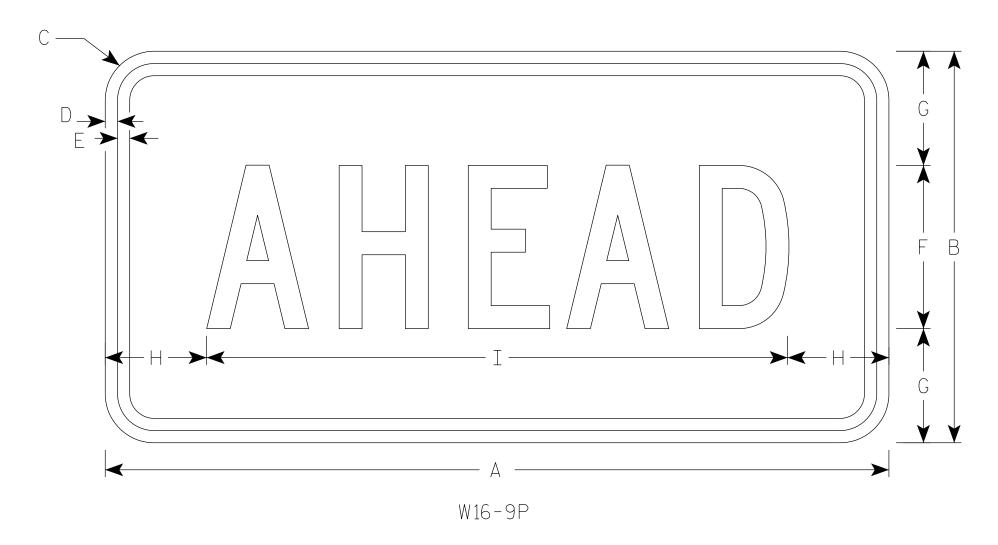

For 36" x 36" Warning Signs, use 30" x 18" W16-9P signs.
 For 48" x 48" Warning Signs, use 48" x 24" W16-9P signs.

HWY:

SIZE	А	В	С	D	E	F	G	Н	I	J	К	L	М	N	0	Р	Q	R	S	Т	U	V	W	X	Y	Z	Area sq. ft.
25	24	12	1 1/2	3/8	3/8	5	3 1/2	3 1/8	17 3/4																		2.0
<u></u> ★ 2M	30	18	1 1/2	3/8	1/2	7	5 1/2	2 3/4	24 1/2																		3.75
X 3	30	18	1 1/2	3/8	1/2	7	3 1/2	2 3/4	24 1/2																		3.75
\times 4	48	24	1 1/8	1/2	5/8	10	7	6 1/8	35 ¾																		8.0
5																											

COUNTY:

STANDARD SIGN W16-9P

WISCONSIN DEPT OF TRANSPORTATION

APPROVED

DATE 1/9/2024 PLATE NO. W16-9P.9 SHEET NO:

FILE NAME : C:\CAEFiles\Projects\tr_stdplate\W169P.DGN

PROJECT NO:

PLOT DATE: 9-Jan 2024 3:47


PLOT BY : dotc4c


PLOT NAME :


- 1. Sign is Type II Type F Reflective
- 2. Color:

Background - Orange Message - Black

- 3. Message Series C
- 4. Corners may be square or rounded when base material is plywood but borders shall be rounded as shown. When base material is metal, the corners and borders shall be rounded.

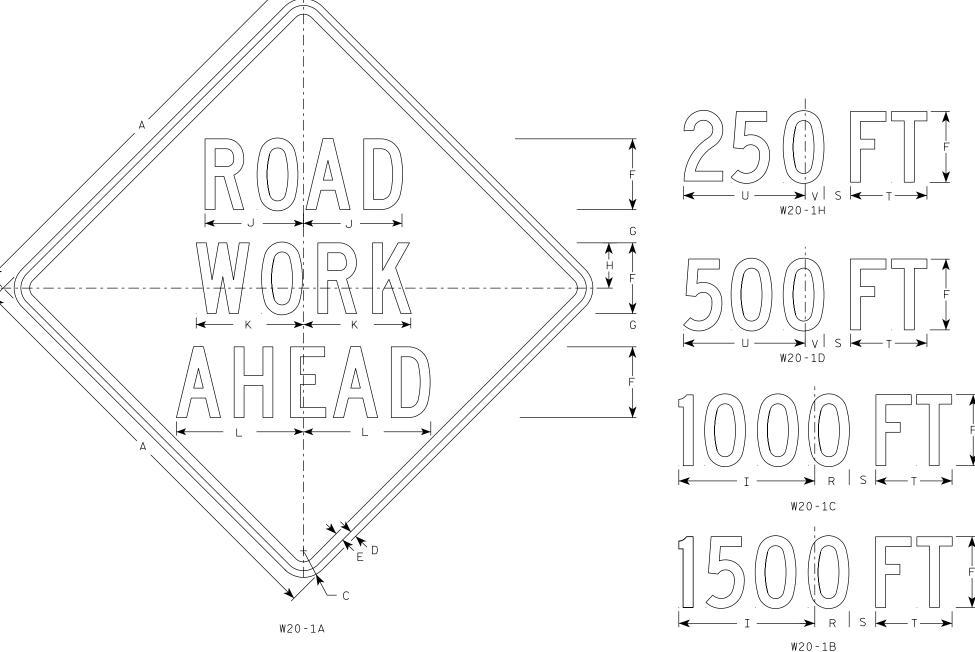

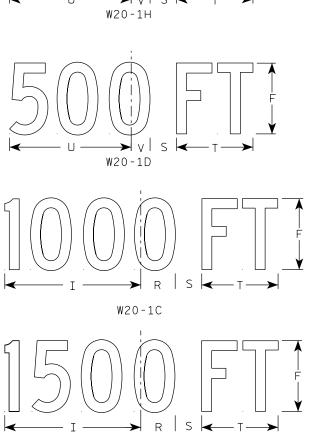

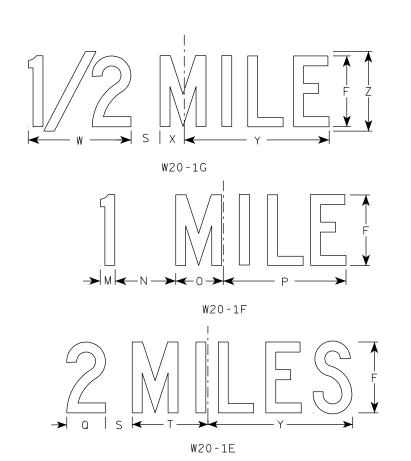

SIZE	Α	В	С	D	E	F	G	Н	I	J	K	L	М	N	0	Р	Q	R	S	Т	U	V	W	X	Y	Z	Area sq. ft.
1	36		2 1/4	5/8	3/4	5	2 5/8	3 1/4	10 1/8	7	7 5/8	8 1/8	1 1/8	4 1/2	3 1/2	9	3 1/4	2 1/2	2 1/4	5 5/8	9	1 3/8	8	1 3/4	10 3/4	6	9.0
25	48		3	3/4	1	8	3 3/4	5 1/8	15 3/8	11 1/8	12 1/8	14 3/8	1	6 1/8	5 3/8	13 1/8	4 3/8	3 1/8	3	8 5/8	13 ¾	2 1/8	11 1/8	2 3/4	16 3/8	9	16.0
2M	48		3	3/4	1	8	3 3/4	5 1/8	15 3/8	11 1/8	12 1/8	14 3/8	1	6 1/8	5 3/8	13 1/8	4 3/8	3 1/8	3	8 5/8	13 ¾	2 1/8	11 7/8	2 3/4	16 3/8	9	16.0
3	48		3	3/4	1	8	3 3/4	5 1/8	15 3/8	11 1/8	12 1/8	14 3/8	1	6 %	5 3/8	13 1/8	4 3/8	3 1/8	3	8 5/8	13 ¾	2 1/8	11 7/8	2 3/4	16 3/8	9	16.0
4	48		3	3/4	1	8	3 3/4	5 1/8	15 3/8	11 1/8	12 1/8	14 3/8	1	6 1/8	5 3/8	13 1/8	4 3/8	3 1/8	3	8 5/8	13 ¾	2 1/8	11 7/8	2 3/4	16 3/8	9	16.0
5	48		3	3/4	1	8	3 3/4	5 1/8	15 3/8	11 1/8	12 1/8	14 ¾	1 5/8	6 1/8	5 3/8	13 1/8	4 3/8	3 1/8	3	8 %	13 ¾	2 1/8	11 1/8	2 3/4	16 3/8	9	16.0

STANDARD SIGN W2O-1A, B, C, D, E, F, G & H

WISCONSIN DEPT OF TRANSPORTATION

APPROVED $f_{\it or}$ State Traffic Engineer

DATE 1/10/2024 PLATE NO. W20-1.12

SHEET NO:

PROJECT NO:





- 1. Sign is Type II Type F Reflective
- 2. Color:

Background - Orange Message - Black


- 3. Message Series See note 5
- 4. Corners may be square or rounded when base material is plywood but borders shall be rounded as shown. When base material is metal, the corners and borders shall be rounded.
- 5. Line 1 is Series D.
 Line 2 is Series D for AHEAD and
 Series C for all other distances.

S N O P
W20-2D

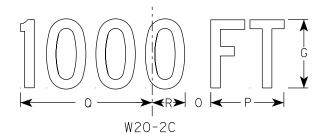

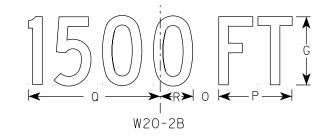



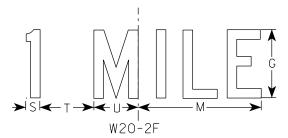

SIZE	А	В	С	D	E	F	G	Н	I	J	K	L	М	N	0	Р	Q	R	S	Т	U	٧	W	Х	Υ	Z	Area sq. ft.
	36		2 1/4	5/8	3/4	6	5	1	2 1/4	14 3/4	15	11 5/8	9	1 3/8	1 1/8	5 5/8	10 1/8	2 1/2	1 1/8	4 1/2	3 1/2	8	1 3/4	10 3/4			9.0
25	48		3	3/4	1	8	7	1 1/4	3	19 3/4	20	15 1/2	12	1 1/8	2 5/8	7 1/2	13 ½	3 3/8	1 1/2	6	4 5/8	10	2 3/8	14 3/8			16.0
2M	48		3	3/4	1	8	7	1 1/4	3	19 ¾	20	15 1/2	12	1 1/8	2 5/8	7 1/2	13 1/2	3 3/8	1 1/2	6	4 5/8	10	2 3/8	14 3/8			16.0
3	48		3	3/4	1	8	7	1 1/4	3	19 3/4	20	15 1/2	12	1 1/8	2 5/8	7 1/2	13 ½	3 3/8	1 1/2	6	4 5/8	10	2 3/8	14 3/8			16.0
4	48		3	3/4	1	8	7	1 1/4	3	19 3/4	20	15 1/2	12	1 1/8	2 5/8	7 1/2	13 1/2	3 3/8	1 1/2	6	4 5/8	10	2 3/8	14 3/8			16.0
5	48		3	3/4	1	8	7	1 1/4	3	19 3/4	20	15 1/2	12	1 1/8	2 5/8	7 1/2	13 ½	3 3/8	1 1/2	6	4 5/8	10	2 3/8	14 3/8			16.0

COUNTY:

STANDARD SIGN W20-2A,B,C,D,F & G

WISCONSIN DEPT OF TRANSPORTATION

APPROVED Matthew R

DATE 1/10/2024 PLATE NO. W20-2.7

SHEET NO:

FILE NAME : C:\CAEfiles\Projects\tr_stdplate\W202.DGN

PROJECT NO:

PLOT DATE: 10-JAN 2024 11:36

PLOT BY : dotc4c

PLOT NAME :

PLOT SCALE: \$\$.....plo†scale.....\$\$WISDOT/CADDS SHEET 42

W20-2A


HWY:



- 1. Sign is Type II Type F Reflective
- 2. Color:

Background - Orange Message – Black

- 3. Message Series see note 5
- 4. Corners may be square or rounded when base material is plywood but borders shall be rounded as shown. When base material is metal, the corners and borders shall be rounded.
- 5. Lines 1 and 2 are Series D. Line 3 is Series D for AHEAD and Series C for all other distances.

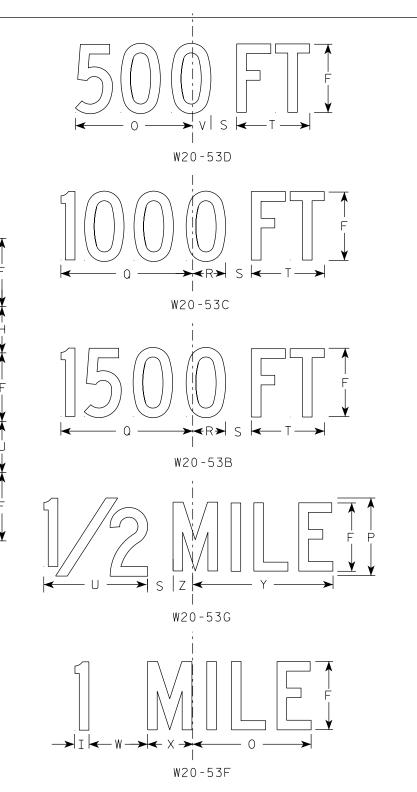

W20-53A

S	ΙZΕ	Α	В	С	D	E	F	G	Н	I	J	К	L	М	N	0	Р	Q	R	S	Т	U	٧	W	Х	Y	Z	Area sq. ft.
	1	36		2 1/4	5/8	3/4	5	3 3/8	3 1/2	1 1/8	4	9 1/4	9 1/4	12 1/2	11	9	6	10 1/8	2 1/2	1 1/8	5 %	8	1 3/8	4 1/2	3 1/2	10 3/4	1 3/4	9.0
2	25	48		3	3/4	1	7	4 1/2	4 3/4	1 1/2	5 1/4	12 1/8	12 1/8	17 1/4	14 5/8	12	8	13 1/2	3 3/8	2 5/8	7 1/2	10 %	1 1/8	6	4 5/8	14 3/8	2 3/8	16.0
2	M.	48		3	3/4	1	7	4 1/2	4 3/4	1 1/2	5 1/4	12 1/8	12 1/8	17 1/4	14 5/8	12	8	13 1/2	3 3/8	2 5/8	7 1/2	10 %	1 1/8	6	4 5/8	14 3/8	2 3/8	16.0
	3	48		3	3/4	1	7	4 1/2	4 3/4	1 1/2	5 1/4	12 1/8	12 1/8	17 1/4	14 5/8	12	8	13 1/2	3 3/8	2 5/8	7 1/2	10 %	1 1/8	6	4 5/8	14 3/8	2 3/8	16.0
	4	48		3	3/4	1	7	4 1/2	4 3/4	1 1/2	5 1/4	12 1/8	12 1/8	17 1/4	14 5/8	12	8	13 1/2	3 3/8	2 5/8	7 1/2	10	1 1/8	6	4 5/8	14 3/8	2 3/8	16.0
	5	48		3	3/4	1	7	4 1/2	4 3/4	1 1/2	5 1/4	12 1/8	12 1/8	17 1/4	14 5/8	12	8	13 1/2	3 3/8	2 5/8	7 1/2	10 5/8	1 1/8	6	4 5/8	14 3/8	2 3/8	16.0

STANDARD SIGN W20-53A,B,C,D,F,G

WISCONSIN DEPT OF TRANSPORTATION

APPROVED Matthew

SHEET NO:

DATE 1/10/2024 PLATE NO. W20-53.2

PROJECT NO: FILE NAME : C:\CAEfiles\Projects\tr_stdplate\W2053.DGN COUNTY:

PLOT BY : dotc4c

PLOT NAME :

PLOT SCALE: \$\$.....plotscale.....\$\$ WISDOT/CADDS SHEET 42

HWY:

PLOT DATE: 10-JAN 2024 2:38

Notes



Wisconsin Department of Transportation

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