Section No.

Section No.

Section No.

TOTAL SHEETS = 90

#### MARCH 2025 STATE OF WISCONSIN ORDER OF SHEETS Section No. Typical Sections and Details (Includes Erosion Control Plans)

PLAN OF PROPOSED IMPROVEMENT

## C WI RAPIDS, WOOD AVENUE

**STH 13 INTERSECTION MODIFICATION** 

### **LOC STR WOOD COUNTY**

STATE PROJECT NUMBER 6999-11-85

# R-6-E Wisconsin Rapids **END PROJECT** STA. 72+06.89 T-22-N 13 **BEGIN PROJECT** STA. 71+68.89 X = 731,816.617Y = 446,657.758 0.5 MI HORIZONTAL POSITIONS SHOWN ON THIS PLAN ARE WISCONSIN SCALE I

# **DEPARTMENT OF TRANSPORTATION**



Estimate of Quantities

Miscellaneous Quantities


Standard Detail Drawings


Computer Earthwork Date


#### DESIGN DESIGNATION


AADT (2021) = 21,200A.A.D.T. = N/A = N/A D.H.V. D.D. = N/A DESIGN SPEED = 40 MPH

#### CONVENTIONAL SYMBOLS

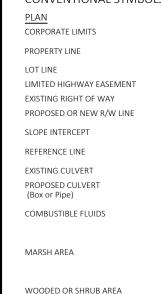

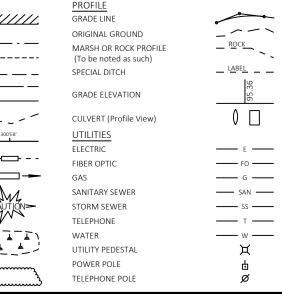

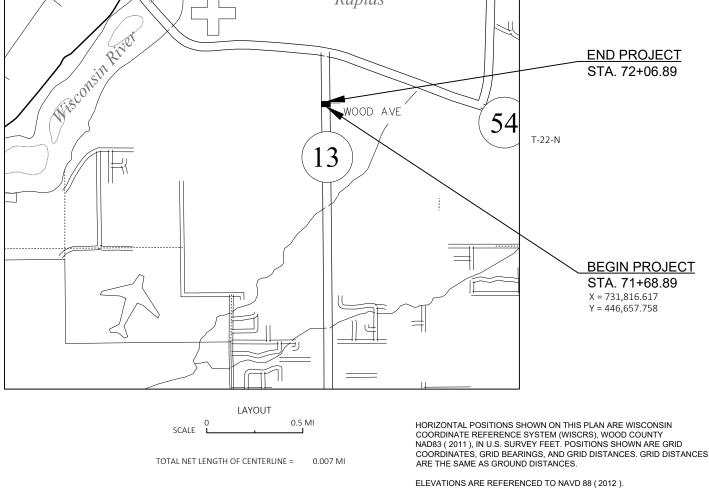

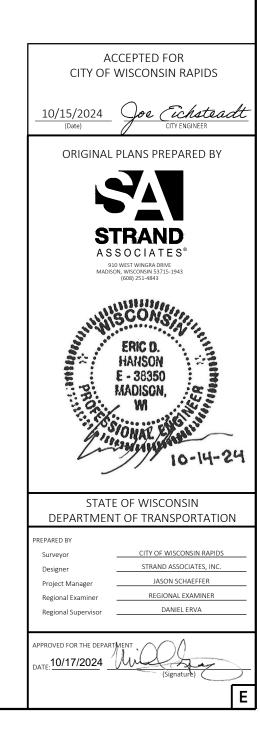

FEDERAL PROJECT

PROJECT

WISC 2025387

CONTRACT

STATE PROJECT

6999-11-85

FILE NAME : S:\MAD\3800--3899\3860\015\DRAWINGS\CAD\69991115\SHEETS\010101-TI.DWG

10/15/2024 11:12 AM

JURECZEK, JESSIE

UTILITY TYPE

GAS

THE LOCATIONS OF EXISTING AND PROPOSED UTILITY INSTALLATIONS AS SHOWN ON THE PLANS ARE APPROXIMATE. THERE MAY BE OTHER UTILITY INSTALLATIONS WITHIN THE PROJECT AREA THAT ARE NOT

NO TREES OR SHRUBS ARE TO BE REMOVED WITHOUT THE APPROVAL OF THE ENGINEER.

ANY SIGNS REMOVED DUE TO THE CONTRACTOR MEANS AND METHODS SHALL BE REPLACED BY CONTRACTOR AT THEIR OWN EXPENSE.

SECTION 2 ORDER OF SHEETS

GENERAL NOTES TYPICAL SECTIONS CONSTRUCTION DETAILS PLAN DETAILS CURB RAMP DETAILS PAVEMENT MARKING TRAFFIC CONTROL - TYPICAL SECTIONS TRAFFIC CONTROL - PEDESTRIAN ROUTING TRAFFIC CONTROL - ADVANCED WARNING SIGNING TRAFFIC CONTROL - ROADWAY PLAN

CITY OF WISCONSIN RAPIDS\* JOE EICHSTEADT SANITARY SEWER

444 WEST GRAND AVENUE WISCONSIN RAPIDS, WI 54495

CONTACT/ADDRESS

(715) 421-8251 JEICHSTEADT@WIRAPIDS.ORG

ELECTRIC JACOB JOHNSON

WATER WORKS AND LIGHTING 221 16TH STREET SOUTH WISCONSIN RAPIDS, WI 54494

(715) 423-6328 JACOB.JOHNSON@WRWWLC.COM

WATER ADAM BREUNIG

WATER WORKS AND LIGHTING 221 16TH STREET SOUTH COMMISSION\* WISCONSIN RAPIDS, WI 54494

(715) 423-6330

ADAM.BREUNIG.WRRWWLC.COM

LARRY KOCH WE ENERGIES\* (715) 421-7249

CELL: (715) 421-9293 1921 8TH STREET SOUTH WISCONSIN RAPIDS, WI 54494 LARRY.KOCH@WE-ENERGIES.COM

\*DENOTES DIGGERS HOTLINE MEMBER

UTILITIES/MUNICIPALITY

COMMISSION\*

#### OTHER CONTACTS

#### MUNICIPALITY

PLOT BY:

JURECZEK, JESSIE

JOE EICHSTEADT, P.E. CITY OF WISCONSIN RAPIDS 444 WEST GRAND AVENUE WISCONSIN RAPIDS, WI 54495 (715) 421-8251 E-MAIL: JEICHSTEADT@WIRAPIDS.ORG **DESIGN CONTACT** 

PLOT NAME :

ERIC HANSON, P.E. STRAND ASSOCIATES, INC. 910 WEST WINGRA DRIVE MADISON, WI 53715 (608) 251-4843 E-MAIL: ERIC.HANSON@STRAND.COM **DNR LIAISON** 

PLOT SCALE :

1" = 1'

BRAD BETTHAUSER WISCONSIN DEPARTMENT OF NATURAL RESOURCES 473 GRIFFITH DRIVE WISCONSIN RAPIDS, WI 54494 (715) 213-9064

E-MAIL: BRADLEY.BETTHAUSER@WISCONSIN.GOV



WISDOT/CADDS SHEET 42


Ε PROJECT NO: 6999-11-85 HWY: WOOD AVENUE COUNTY: WOOD **GENERAL NOTES** SHEET

10/22/2024 8:23 AM

PLOT DATE :

FILE NAME :



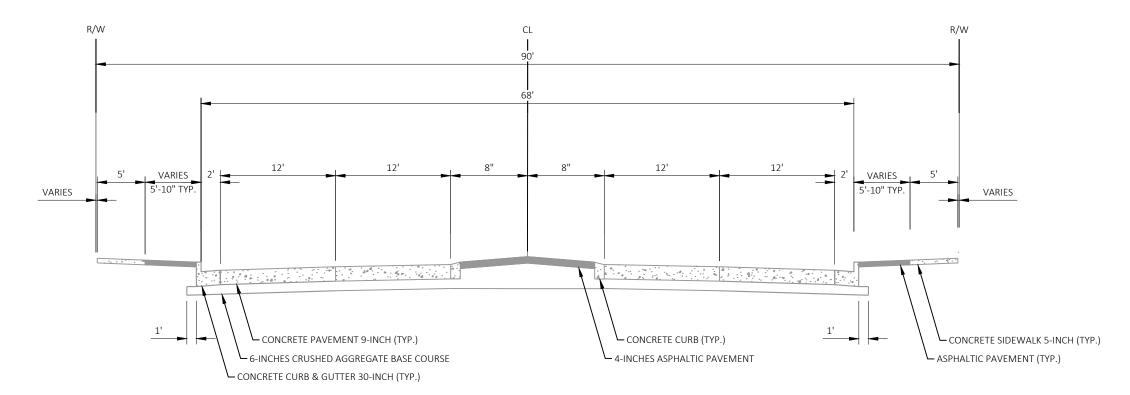


#### **EXISTING TYPICAL SECTION - STH 13** STA. 71+68.89 TO STA. 72+06.89

\*SEE PLAN DETAILS FOR SPOT REPLACEMENT LOCATIONS (TYP.).

\*\*SEE CURB RAMP DETAILS FOR ADDITIONAL GUTTER SLOPE REQUIREMENTS

\*\*\*LATERAL CLEARANCE

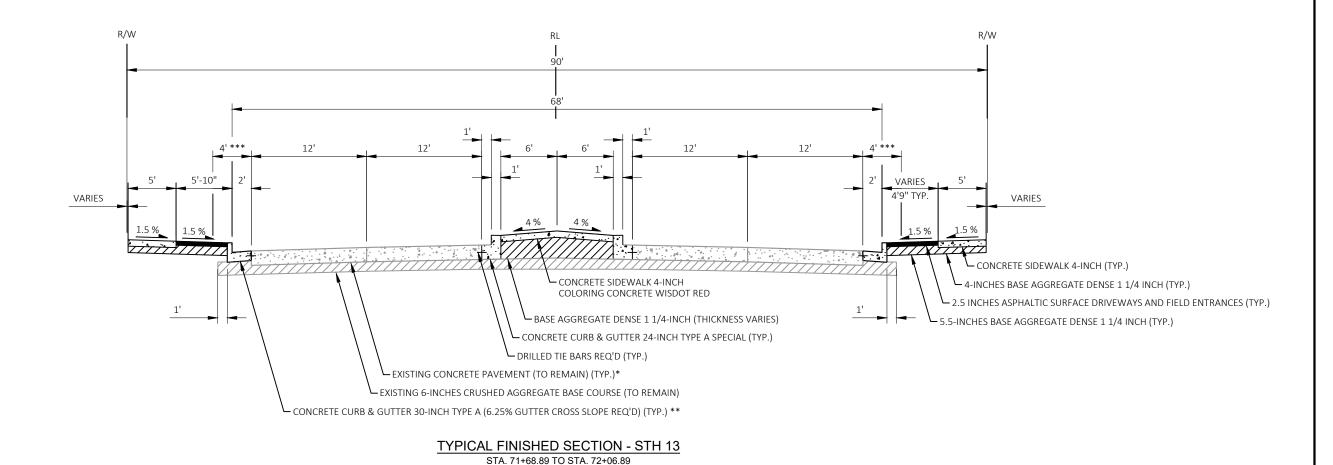

PROJECT NO: Ε 6999-11-85 HWY: WOOD AVENUE COUNTY: WOOD TYPICAL SECTIONS SHEET S:\MAD\3800--3899\3860\015\DRAWINGS\CAD\69991115\SHEETS\020301-TS.DWG PLOT DATE : PLOT BY : JURECZEK, JESSIE PLOT NAME : 1 IN:10 FT FILE NAME :

# 15" TIE BARS REQ'D

#### CONCRETE CURB & GUTTER 24-INCH TYPE A SPECIAL

#### RUNOFF COEFFICIENT TABLE

		HYDROLOGIC SOIL GROUP											
			A		В			С			D		
	SLOPE RANGE (PERCENT)		S	SLOPE RANGE (PERCENT)			SLOPE RANGE (PERCENT)			SLOPE RANGE (PERCENT)			
LAND USE:	0-2	2-6	6 & OVER	0-2	2-6	6 & OVER	0-2	2-6	6 & OVER	0-2	2-6	6 & OVER	
ROW CROPS	.08	.16 .30	.22 .38	.12 .26	.20 .34	.27 .44	.15 .30	.24 .37	.33 .50	.19 .34	.28 .41	.38 .56	
MEDIAN STRIP- TURF	.19 .24	.20 .26	.24 .30	.19 .25	.22 .28	.26 .33	.20 .26	.23 .30	.30 .37	.20 .27	.25 .32	.30 .40	
SIDE SLOPE- TURF			.25 .32			.27 .34			.28 .36			.30 .38	
PAVEMENT:	_				<b>_</b>	l	1						
ASPHALT						.7095							
CONCRETE						.8095							
BRICK						.7080							
DRIVES, WALKS						.7585							
ROOFS						.7595							
GRAVEL ROADS, SH	OULDERS				_	.4060		_					

TOTAL PROJECT AREA = 0.10 ACRES


TOTAL AREA EXPECTED TO BE DISTURBED BY CONSTRUCTION ACTIVITIES = 0.04 ACRES

Ε HWY: WOOD AVENUE COUNTY: WOOD SHEET PROJECT NO: 6999-11-85 CONSTRUCTION DETAILS S:\MAD\3800--3899\3860\015\DRAWINGS\CAD\69991115\SHEETS\021001-CD.DWG LAYOUT NAME - 021001-cd FILE NAME : 10/18/2024 4:41 PM PLOT BY: JURECZEK, JESSIE

PLOT DATE :


PLOT NAME :

PLOT SCALE : ##########

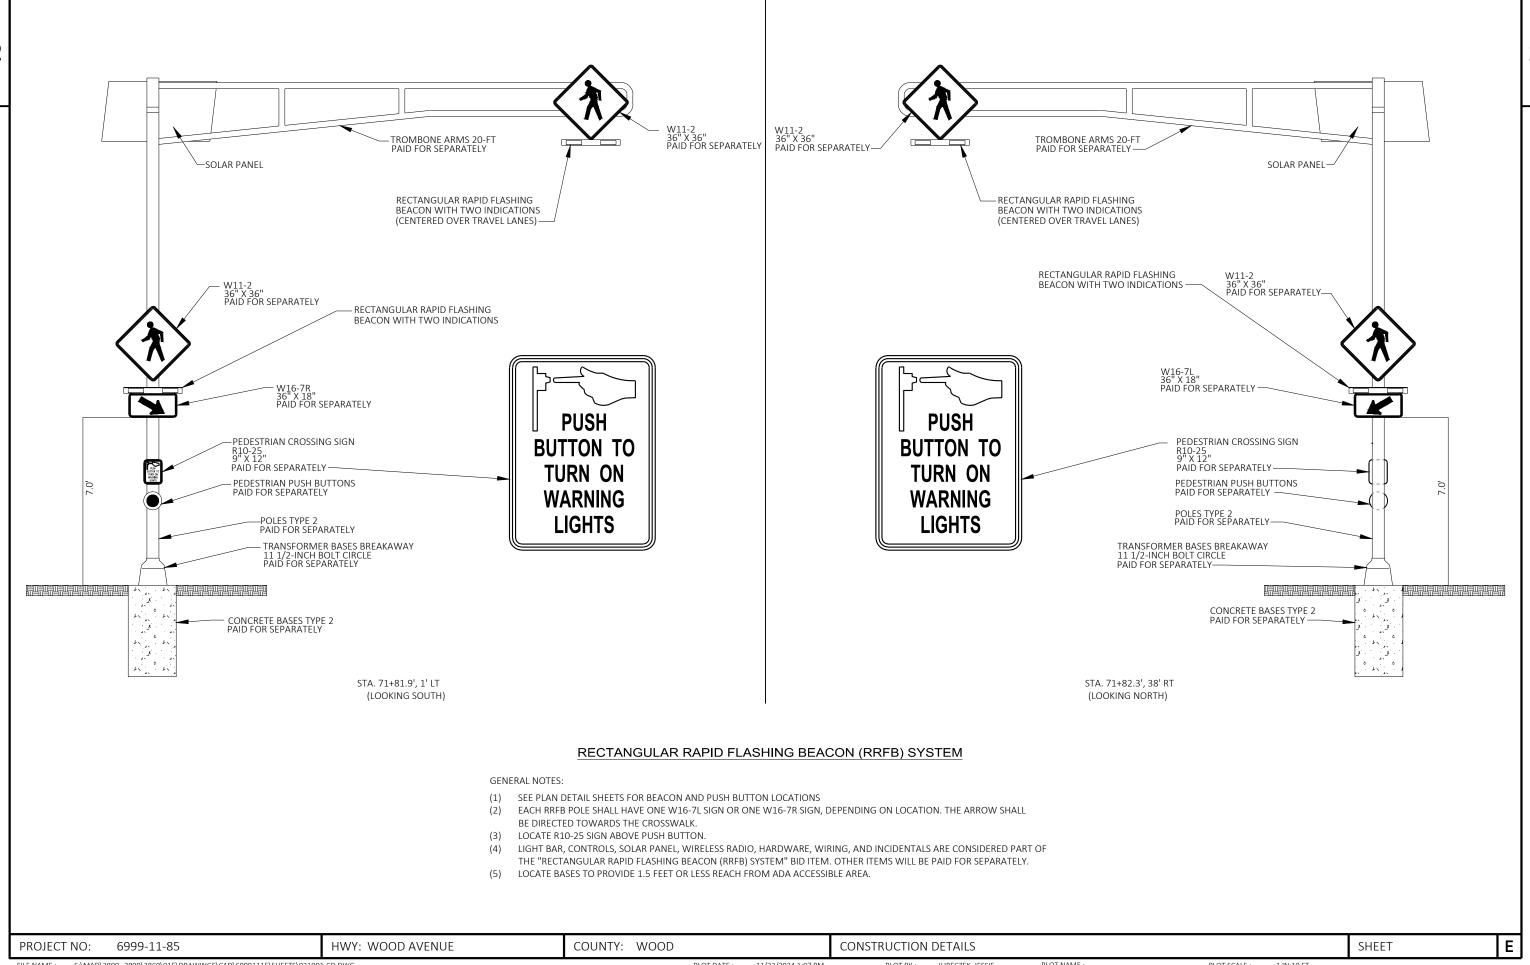


JURECZEK, JESSIE S:\MAD\3800--3899\3860\015\DRAWINGS\CAD\69991115\SHEETS\021001-CD.DWG PLOT DATE : PLOT BY: PLOT NAME PLOT SCALE : 1 IN:10 FT FILE NAME : 11/22/2024 1:07 PM WISDOT/CADDS SHEET 42

LAYOUT NAME - 021002-cd

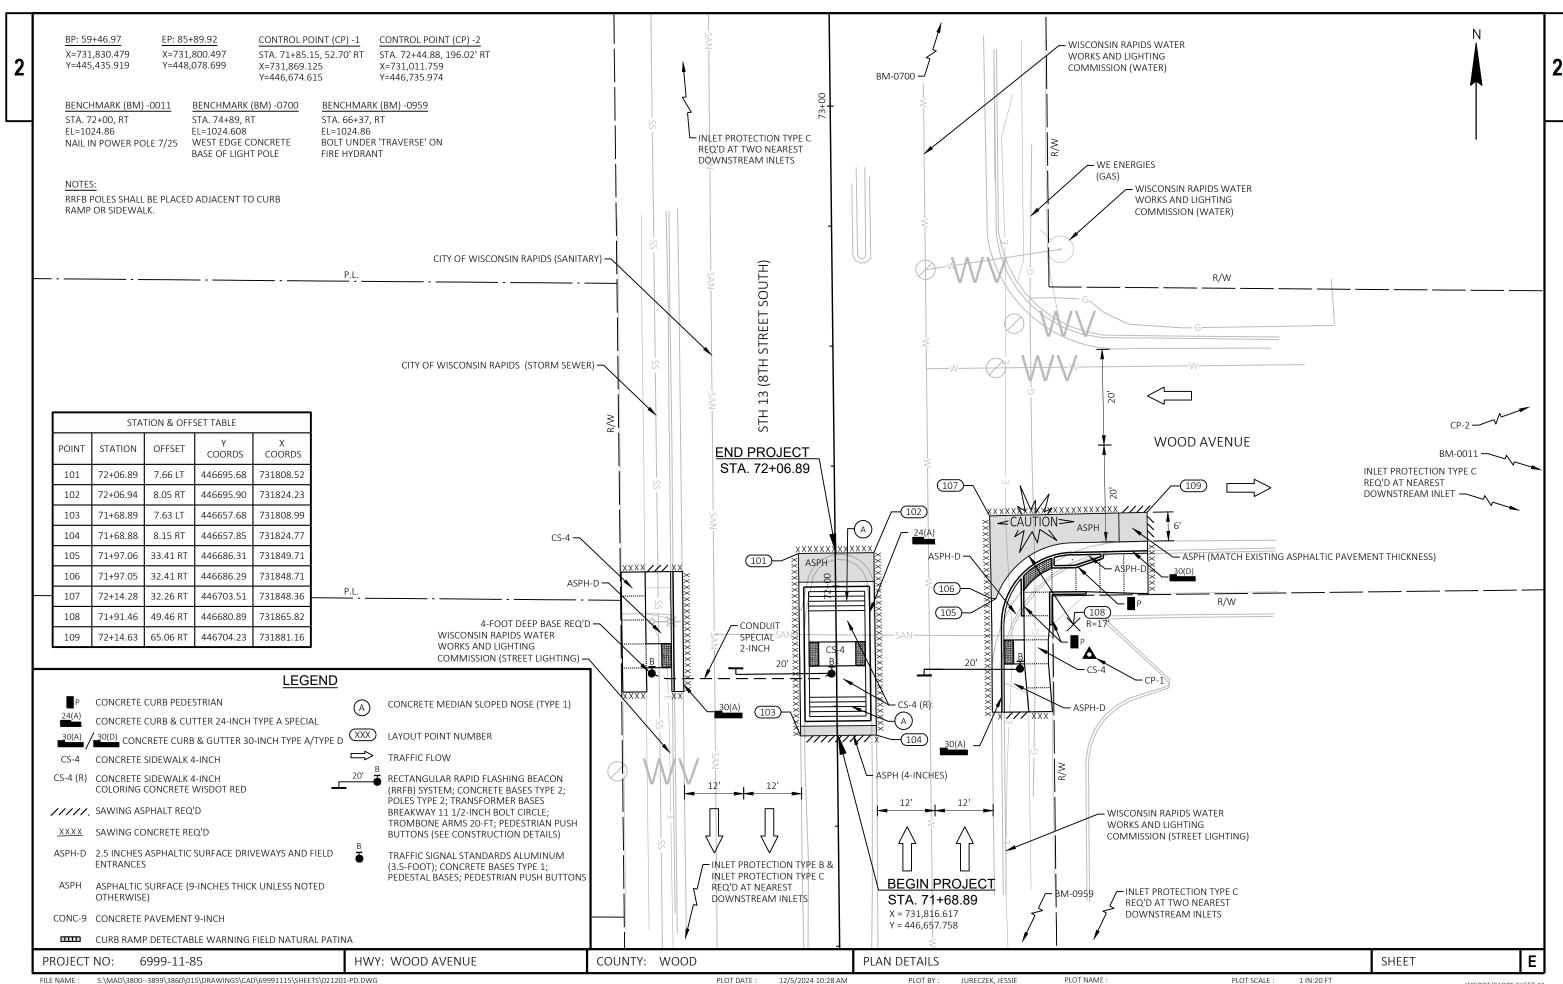

: S:\MAD\3800--3899\3860\015\DRAWINGS\CAD\69991115\SHEETS\021201-PD.DWG LAYOUT NAME - 021201-pd

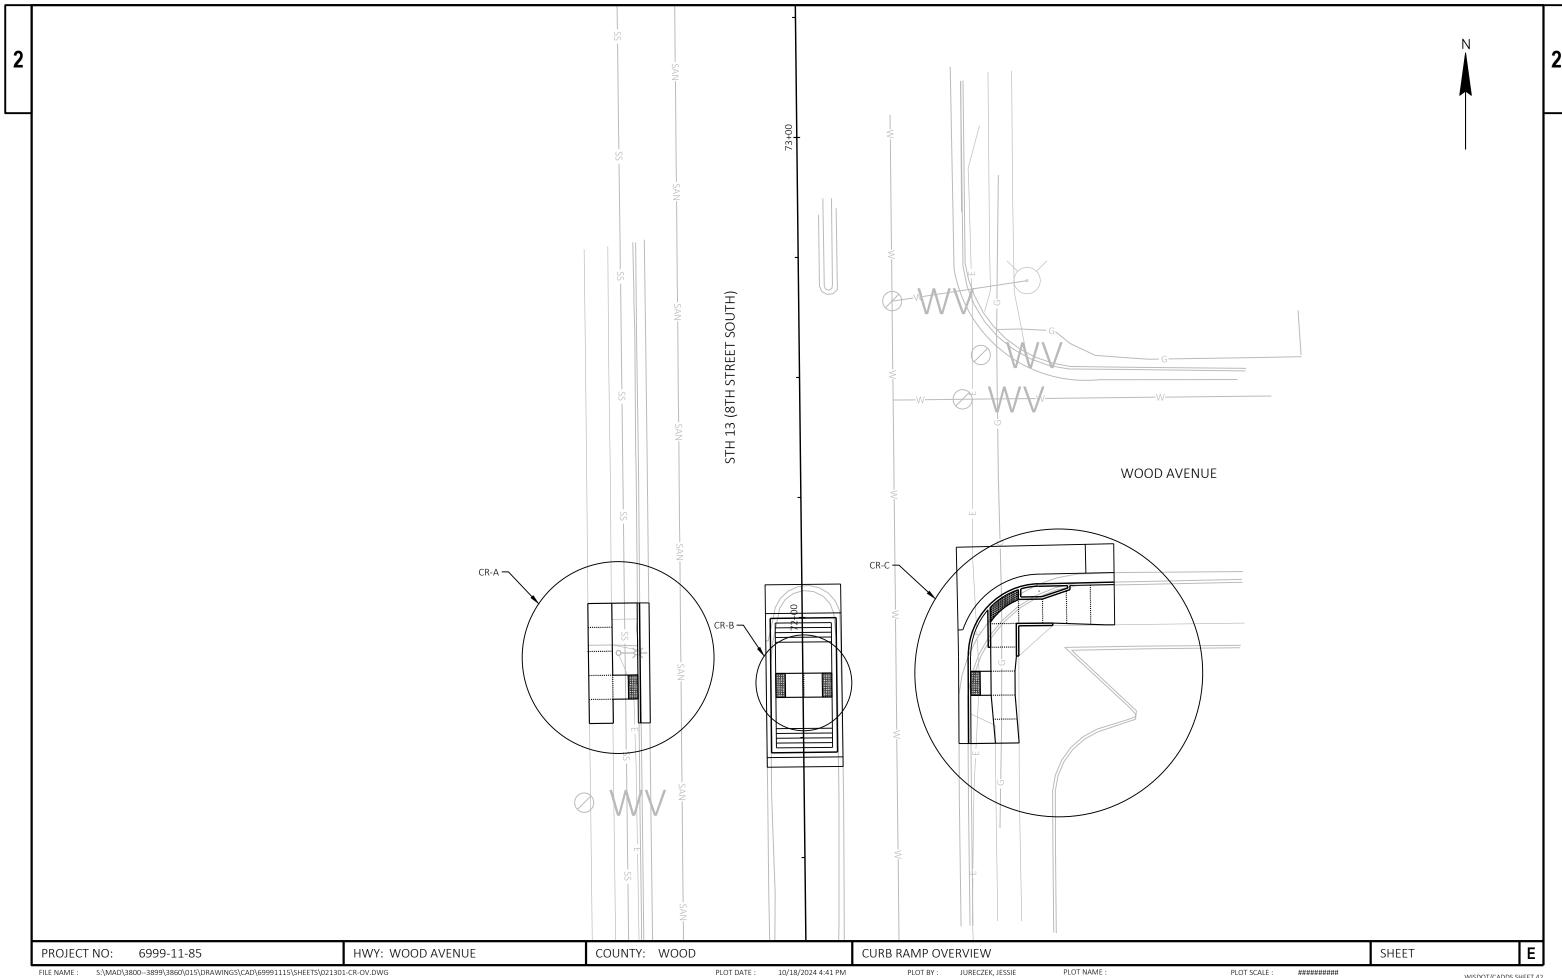

LEGEND

NOTES


- GT GRASS TERRACE 6:1 (MAX.) GRADED FLARE; CURB HEAD TRANSITION REQ'D 1. SEE STANDARD DETAIL DRAWING "CURB RAMPS" FOR ADDITIONAL INFORMATION

- LL LEVEL LANDING AREA
- PT PAVED TERRACE 10:1 (MAX.) FLARE; CURB HEAD TRANSITION REQ'D

CR - A CURB RAMP TYPE 3 (MODIFIED)


STATION & OFFSET TABLE							
POINT	STATION	OFFSET	Y COORDS	X COORDS	ELEVATION		
A01	71+88.41	31.87 LT	446676.923	731784.525	1023.73		
A02	71+83.41	31.88 LT	446671.923	731784.578	1023.76		
A03	71+88.42	33.87 LT	446676.901	731782.525	1023.68		
A04	71+83.42	33.88 LT	446671.902	731782.578	1023.71		
A05	71+88.42	39.62 LT	446676.841	731776.776	1024.07		
A06	71+83.42	36.38 LT	446671.875	731780.078	1023.88		
A07	71+83.42	39.60 LT	446671.841	731776.854	1024.08		
A08	71+78.42	39.58 LT	446666.842	731776.932	MATCH		
A09	71+78.42	44.58 LT	446666.789	731771.932	MATCH		
A10	71+83.42	44.60 LT	446671.788	731771.854	1024.16		
A11	71+88.42	44.62 LT	446676.788	731771.776	1024.14		
A12	71+93.42	44.62 LT	446681.788	731771.723	1024.12		
A13	71+98.42	44.64 LT	446686.787	731771.641	1024.12		
A14	72+03.42	44.64 LT	446691.787	731771.593	MATCH		
A15	72+03.42	39.64 LT	446691.840	731776.593	MATCH		
A16	71+98.42	39.61 LT	446686.840	731776.670	1024.04		
A17	71+93.42	39.62 LT	446681.840	731776.723	1024.05		
A18	71+88.42	36.37 LT	446676.875	731780.025	1023.85		
A19	72+03.42	34.36 LT	446691.895	731781.867	MATCH		
A20	71+93.42	34.37 LT	446681.896	731781.972	1023.93		
A21	71+80.42	34.38 LT	446668.897	731782.110	1024.00		
A22	71+78.42	34.38 LT	446666.897	731782.131	MATCH		
A23	72+03.41	31.86 LT	446691.922	731784.366	MATCH		
A24	71+78.41	31.88 LT	446666.923	731784.631	MATCH		


HWY: WOOD AVENUE

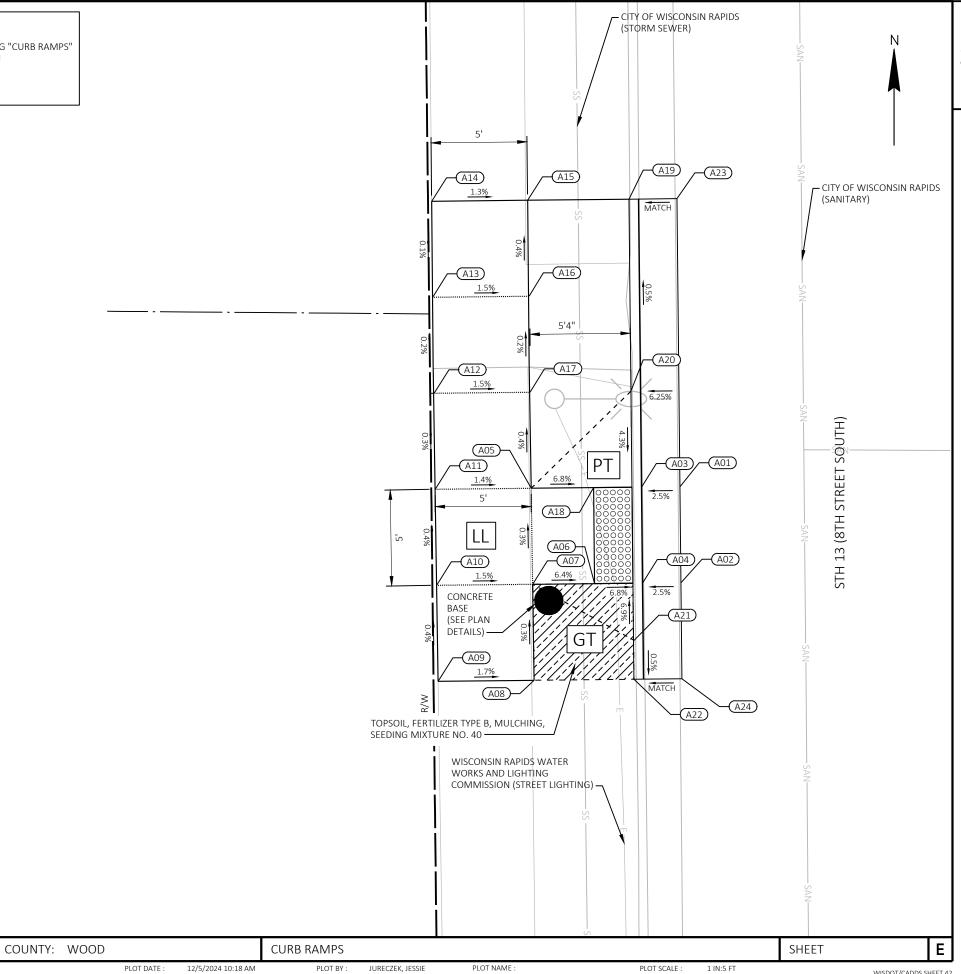


6999-11-85


PROJECT NO:

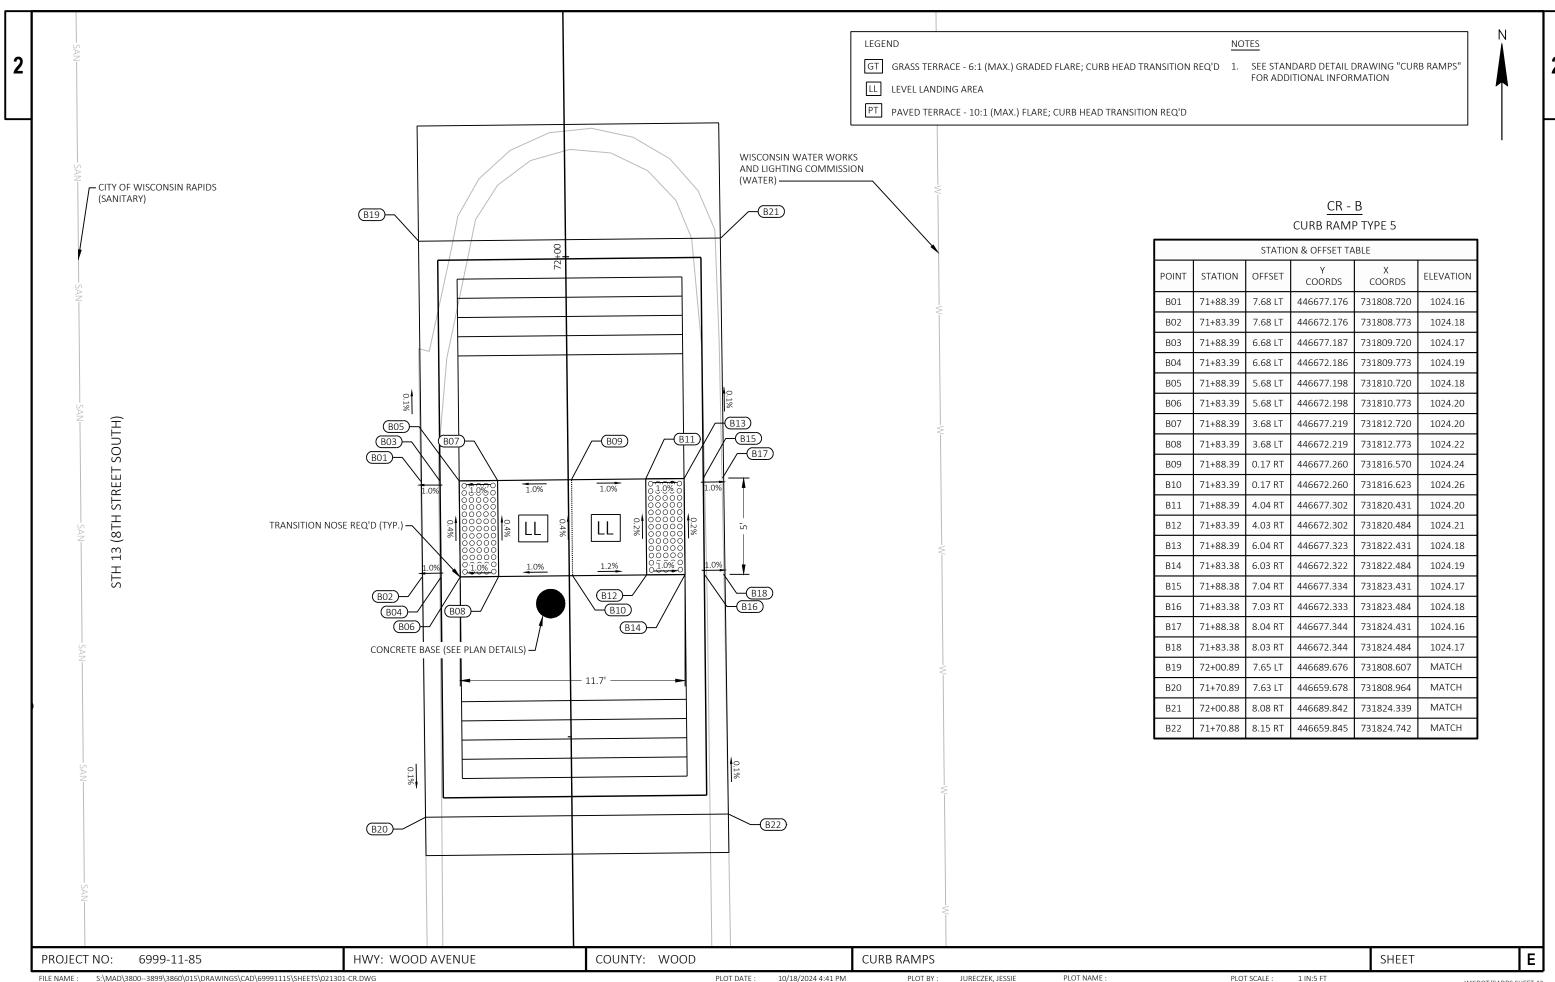

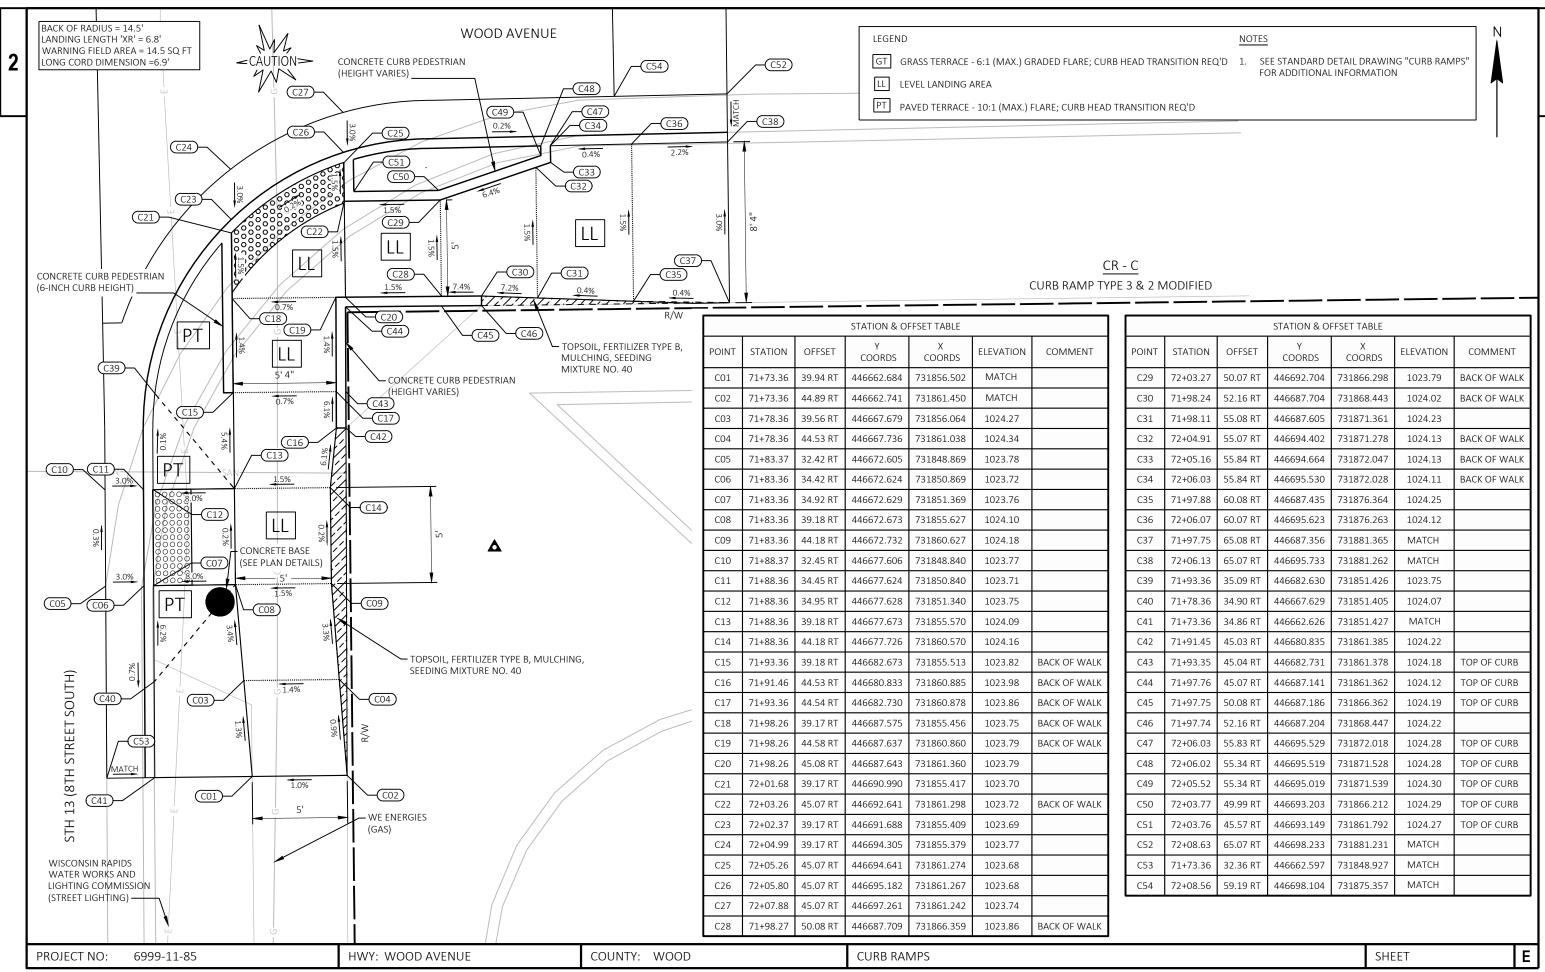

FILE NAME: S:\MAD\3800--3899\3860\015\DRAWINGS\CAD\69991115\SHEETS\021301-CR.DWG PLOT DATE: 1/9/2025 11:50 AM PLOT BY: JURECZEK, JESSIE PLOT NAME: PLOT SCALE: 1 IN:5 FT WISDOT/CADDS SHEET 42 UNIT NAME - 021303-cr

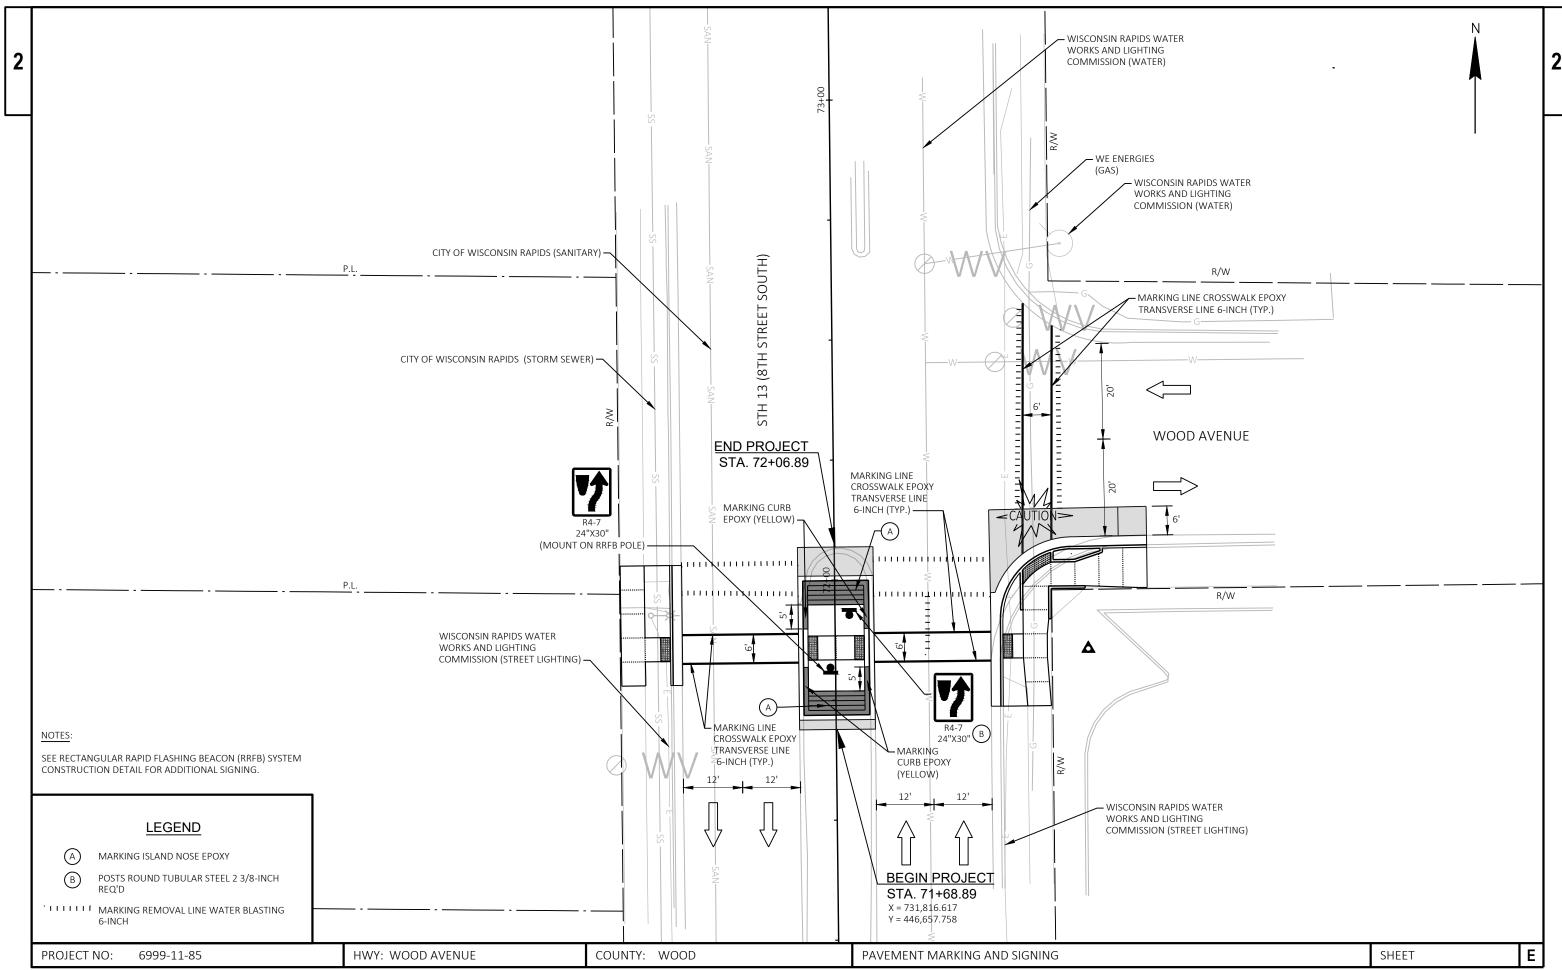

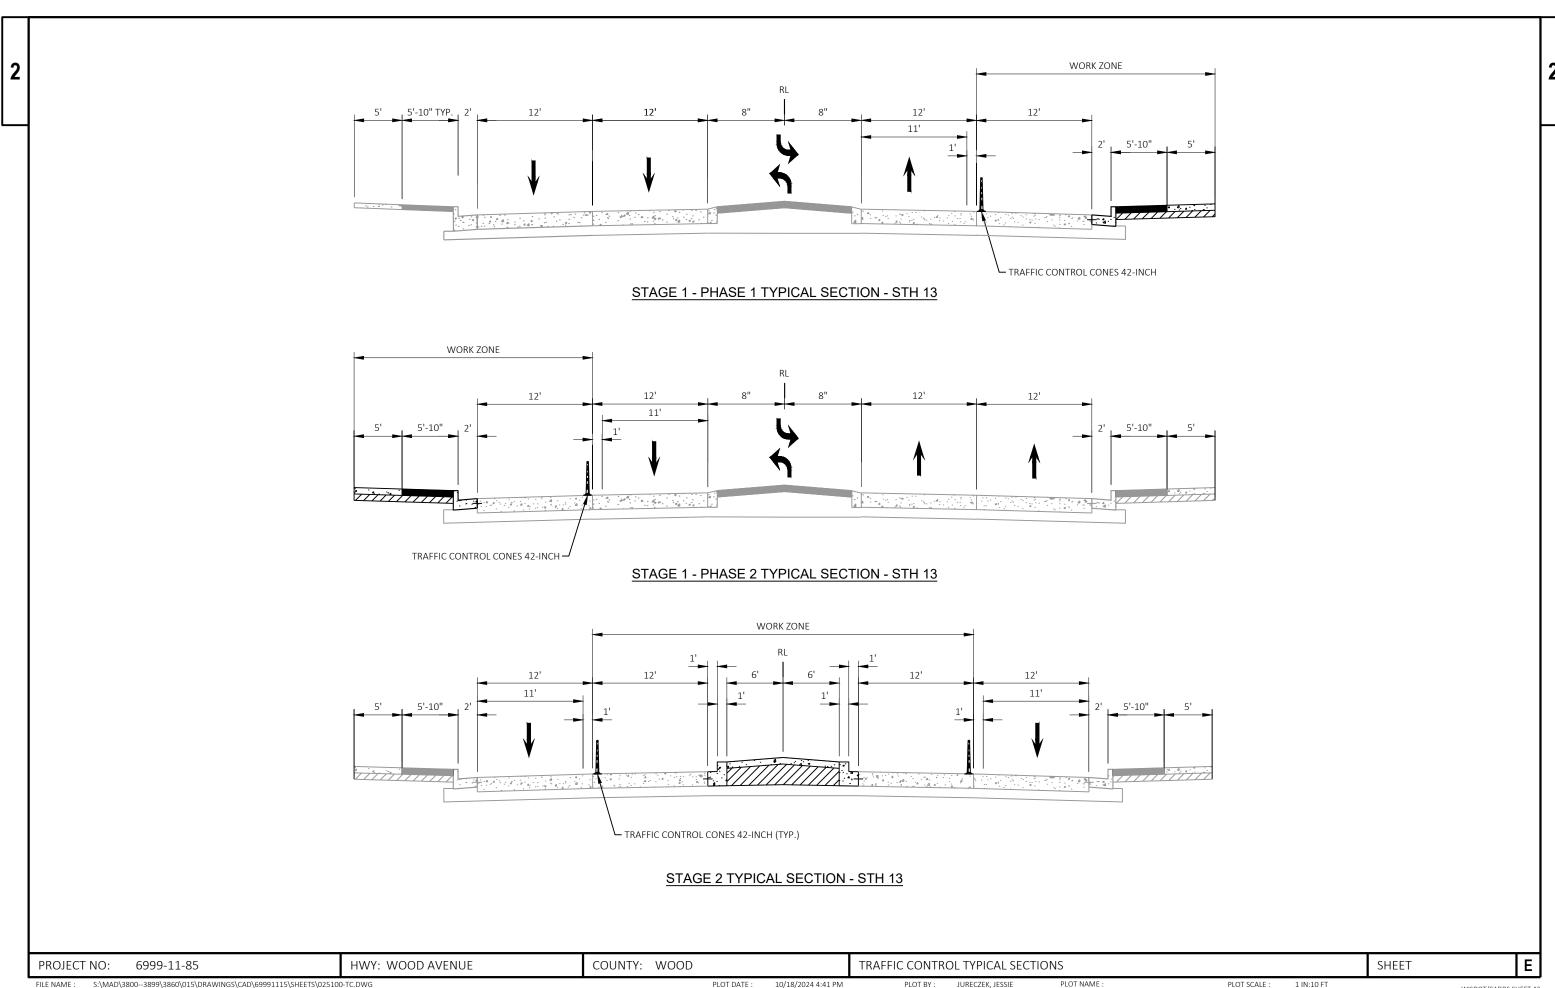



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S:\MAD\3809-3899\3860\015\DRAWINGS\CAD\69991115\SHEETS\027001-DT.DWG PLOT BY: JURECZEK, JESSIE PLOT NAME: PLOT SCALE: 1 IN:200 FT WISDOT/CADDS SHEET 42 LAYOUT NAME - 027002-dt




S:\MAD\3800--3899\3860\015\DRAWINGS\CAD\69991115\SHEETS\027001-DT.DWG PLOT BY: JURECZEK, JESSIE PLOT NAME: PLOT BY: JURECZEK, JESSIE PLOT NAME: 1 IN:200 FT WISDOT/CADDS SHEET 42 LAYOUT NAME - 027003-dt

LEGEND ROAD ROAD LEFT LANE CLOSED AHEAD END Road Work FOR ADDITIONAL INFORMATION USE STANDARD DETAIL DRAWINGS: WORK CLOSED "TRAFFIC CONTROL, SINGLE LANE CLOSURE, DIVIDED NON-FREEWAY/EXPRESSWAY" AHEAD "BARRICADES AND SIGNS FOR SIDEROAD CLOSURE" PCMS TRAFFIC CONTROL SIGNS PCMS (PRIOR TO CONSTRUCTION OR SIDEROAD CLOSURE: SEE SPECIAL PROVISIONS FOR ADDITIONAL INFORMATION) ① USE DETAIL 1 ON "BARRICADES AND SIGNS FOR SIDEROAD CLOSURES" DURING ALLOWABLE SIDEROAD CLOSURES CLOSED AHEAD TRAFFIC CONTROL SIGN ATTACHED TO PERMANENT OR TEMPORARY SUPORT 7TH STREET SOUTH STH 13 (8TH STREET SOUTH) WORKZONE (WHEN SIDEROAD OPEN TO THRU TRAFFIC) B (DURING ALLOWABLE SIDEROAD CLOSURE) 1 11 COUNTY: WOOD PROJECT NO: 6999-11-85 HWY: WOOD AVENUE ADVANCED WARNING SIGNING - STAGE 1 - PHASE 1 SHEET PLOT NAME : PLOT SCALE : FILE NAME : S:\MAD\3800--3899\3860\015\DRAWINGS\CAD\69991115\SHEETS\025000-AW.DWG WISDOT/CADDS SHEET 42

JURECZEK, JESSIE PLOT DATE : 10/18/2024 4:41 PM PLOT BY: 1 IN:200 FT LAYOUT NAME - 025000-aw

LEGEND ROAD ROAD LEFT LANE CLOSED AHEAD END ROAD WORK FOR ADDITIONAL INFORMATION USE STANDARD DETAIL DRAWINGS: WORK CLOSED "TRAFFIC CONTROL, SINGLE LANE CLOSURE, DIVIDED NON-FREEWAY/EXPRESSWAY" AHEAD "BARRICADES AND SIGNS FOR SIDEROAD CLOSURE" PCMS TRAFFIC CONTROL SIGNS PCMS (PRIOR TO CONSTRUCTION OR SIDEROAD CLOSURE: SEE SPECIAL PROVISIONS FOR ADDITIONAL INFORMATION) ① USE DETAIL 1 ON "BARRICADES AND SIGNS FOR SIDEROAD CLOSURES" DURING ALLOWABLE SIDEROAD CLOSURES CLOSED AHEAD TRAFFIC CONTROL SIGN ATTACHED TO PERMANENT OR TEMPORARY SUPORT 7TH STREET SOUTH STH 13 (8TH STREET SOUTH) 1 11 PROJECT NO: 6999-11-85 HWY: WOOD AVENUE COUNTY: WOOD ADVANCED WARNING SIGNING - STAGE 1 - PHASE 2 SHEET PLOT SCALE : FILE NAME : 1 IN:200 FT

LEGEND ROAD ROAD LEFT LANE CLOSED AHEAD END ROAD WORK FOR ADDITIONAL INFORMATION USE STANDARD DETAIL DRAWINGS: WORK CLOSED "TRAFFIC CONTROL, SINGLE LANE CLOSURE, DIVIDED NON-FREEWAY/EXPRESSWAY" AHEAD AHEAD "BARRICADES AND SIGNS FOR SIDEROAD CLOSURE" PCMS TRAFFIC CONTROL SIGNS PCMS (PRIOR TO CONSTRUCTION OR SIDEROAD CLOSURE: SEE SPECIAL PROVISIONS FOR ADDITIONAL INFORMATION) ① USE DETAIL 1 ON "BARRICADES AND SIGNS FOR SIDEROAD CLOSURES" DURING ALLOWABLE SIDEROAD CLOSURES CLOSED AHEAD TRAFFIC CONTROL SIGN ATTACHED TO PERMANENT OR TEMPORARY SUPORT 7TH STREET SOUTH WORKZONE -STH 13 (8TH STREET SOUTH) 1 11 PROJECT NO: 6999-11-85 HWY: WOOD AVENUE COUNTY: WOOD ADVANCED WARNING SIGNING - STAGE 2 SHEET PLOT BY: FILE NAME : 1 IN:200 FT

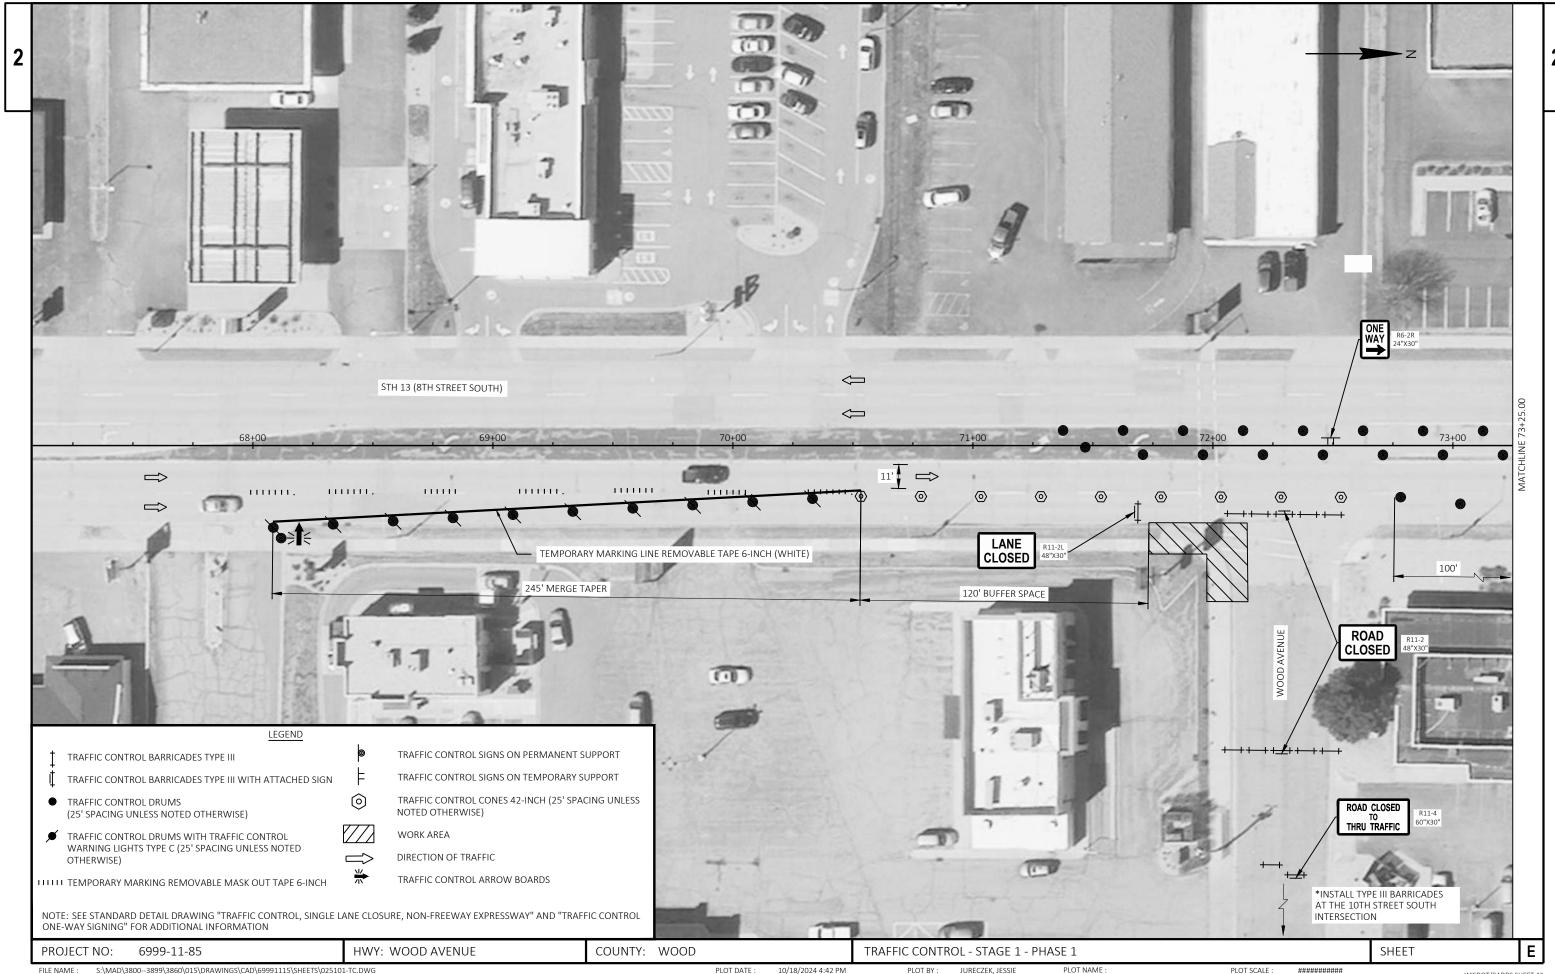

S:\MAD\3800--3899\3860\015\DRAWINGS\CAD\69991115\SHEETS\025101-TC.DWG LAYOUT NAME - 025101-tc

PLOT DATE :


10/18/2024 4:42 PM

JURECZEK, JESSIE

PLOT SCALE:


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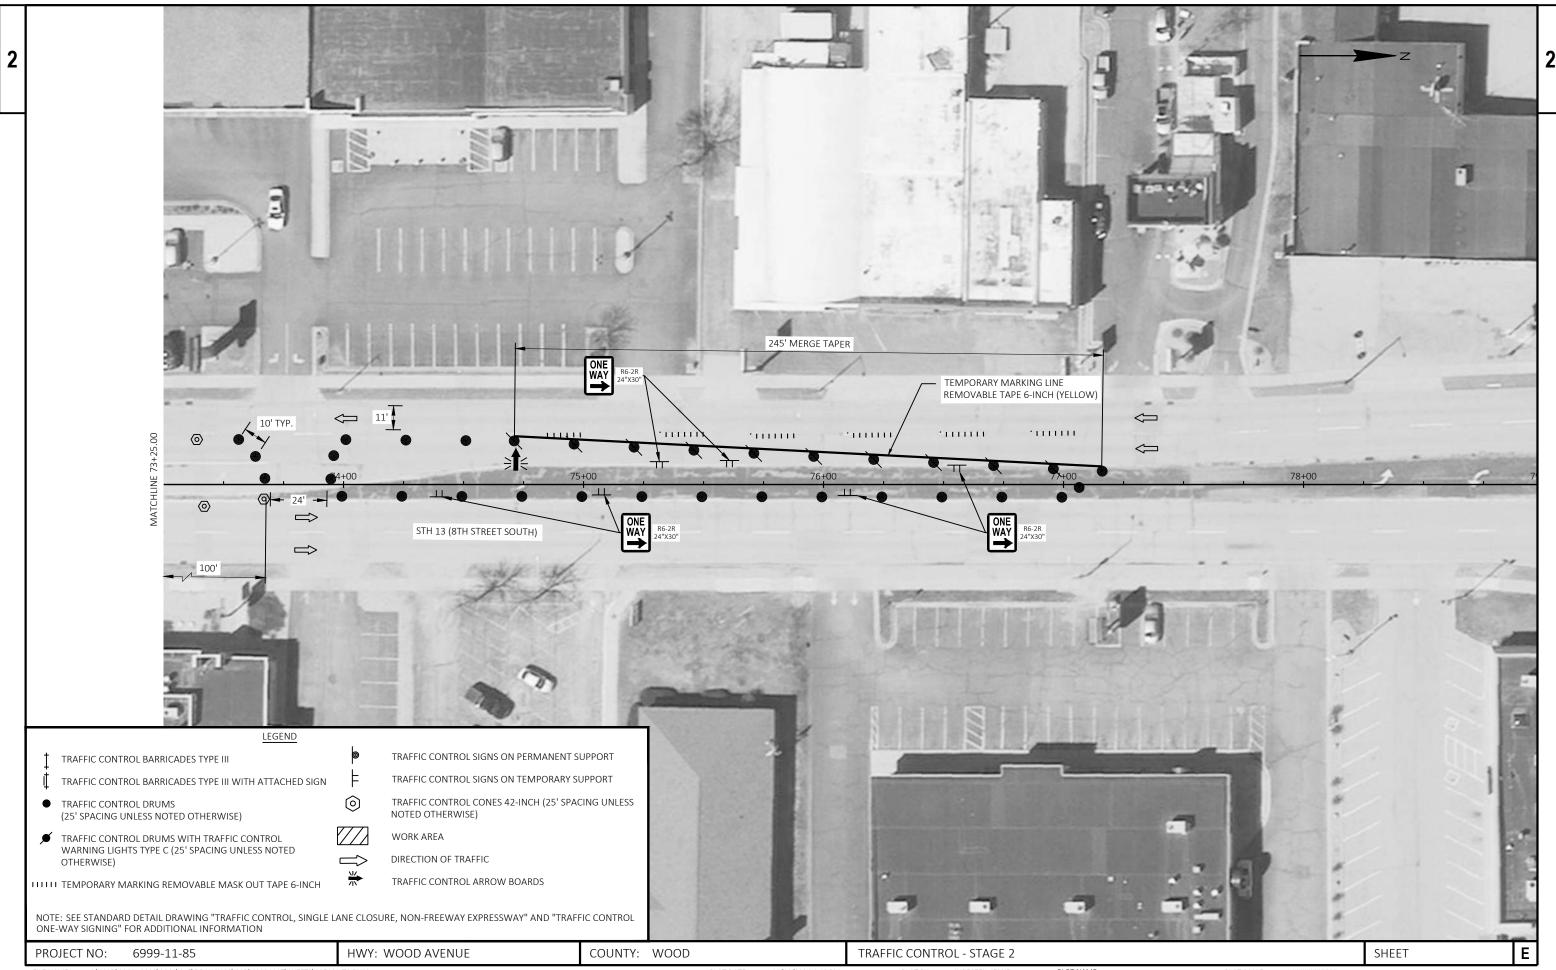


S:\MAD\3800--3899\3860\015\DRAWINGS\CAD\69991115\SHEETS\025101-TC.DWG PLOT DATE : PLOT BY : JURECZEK, JESSIE PLOT NAME : 10/18/2024 4:42 PM PLOT SCALE : ########### WISDOT/CADDS SHEET 42 LAYOUT NAME - 025103-tc

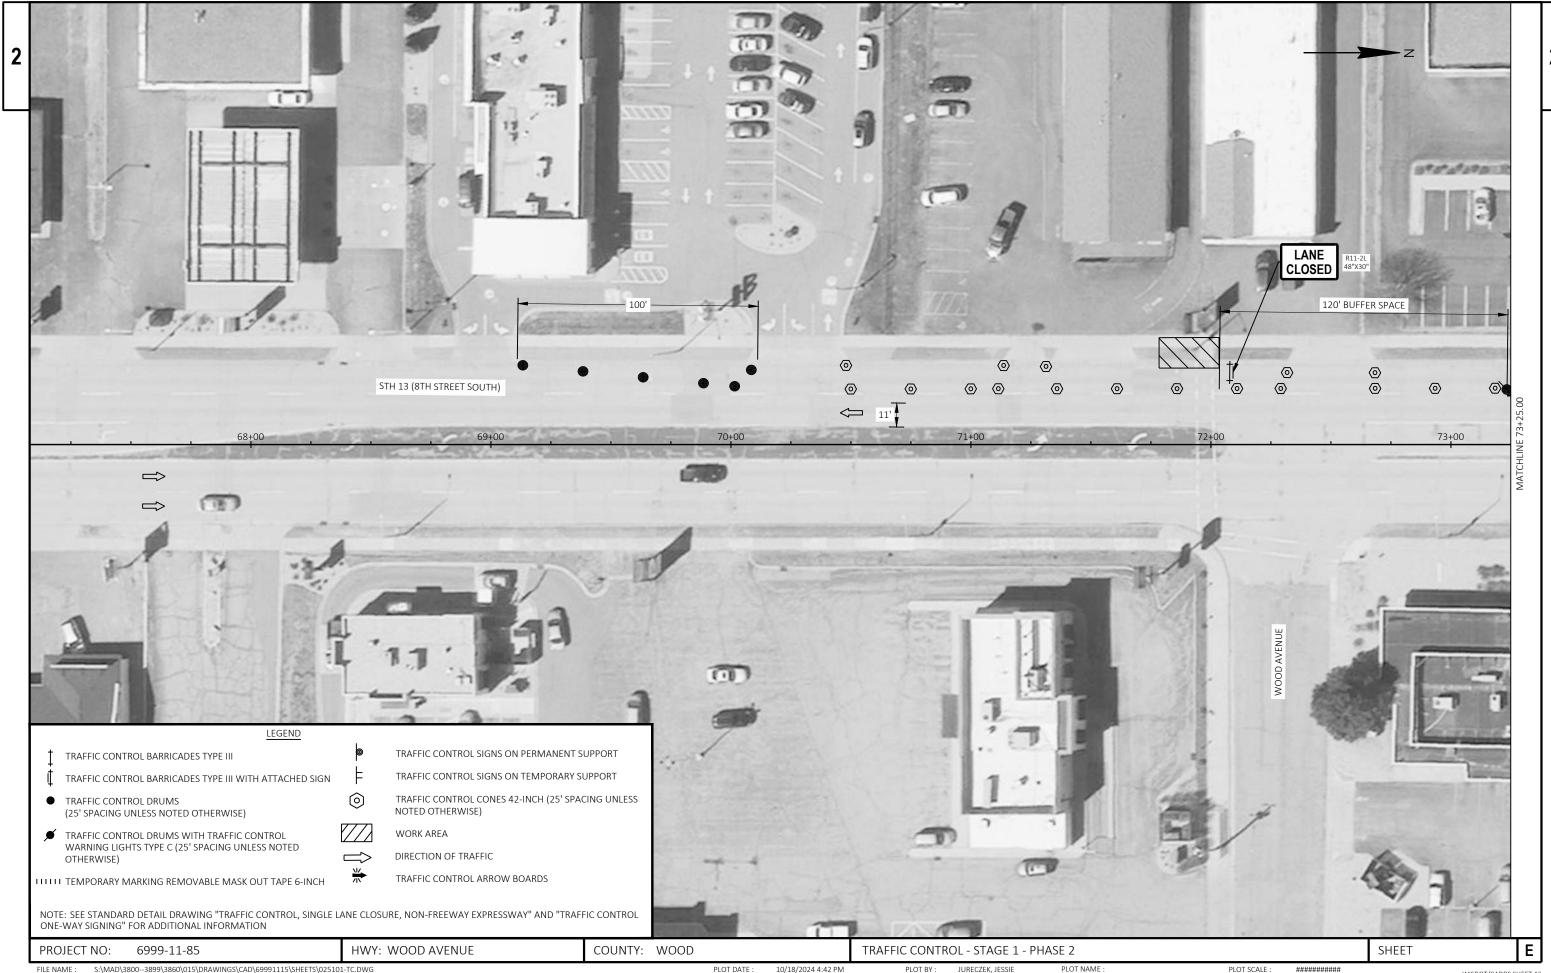



S:\MAD\3800--3899\3860\015\DRAWINGS\CAD\69991115\SHEETS\025101-TC.DWG JURECZEK, JESSIE PLOT NAME : PLOT DATE : 10/18/2024 4:42 PM PLOT BY: PLOT SCALE : ########### WISDOT/CADDS SHEET 42 LAYOUT NAME - 025105-tc

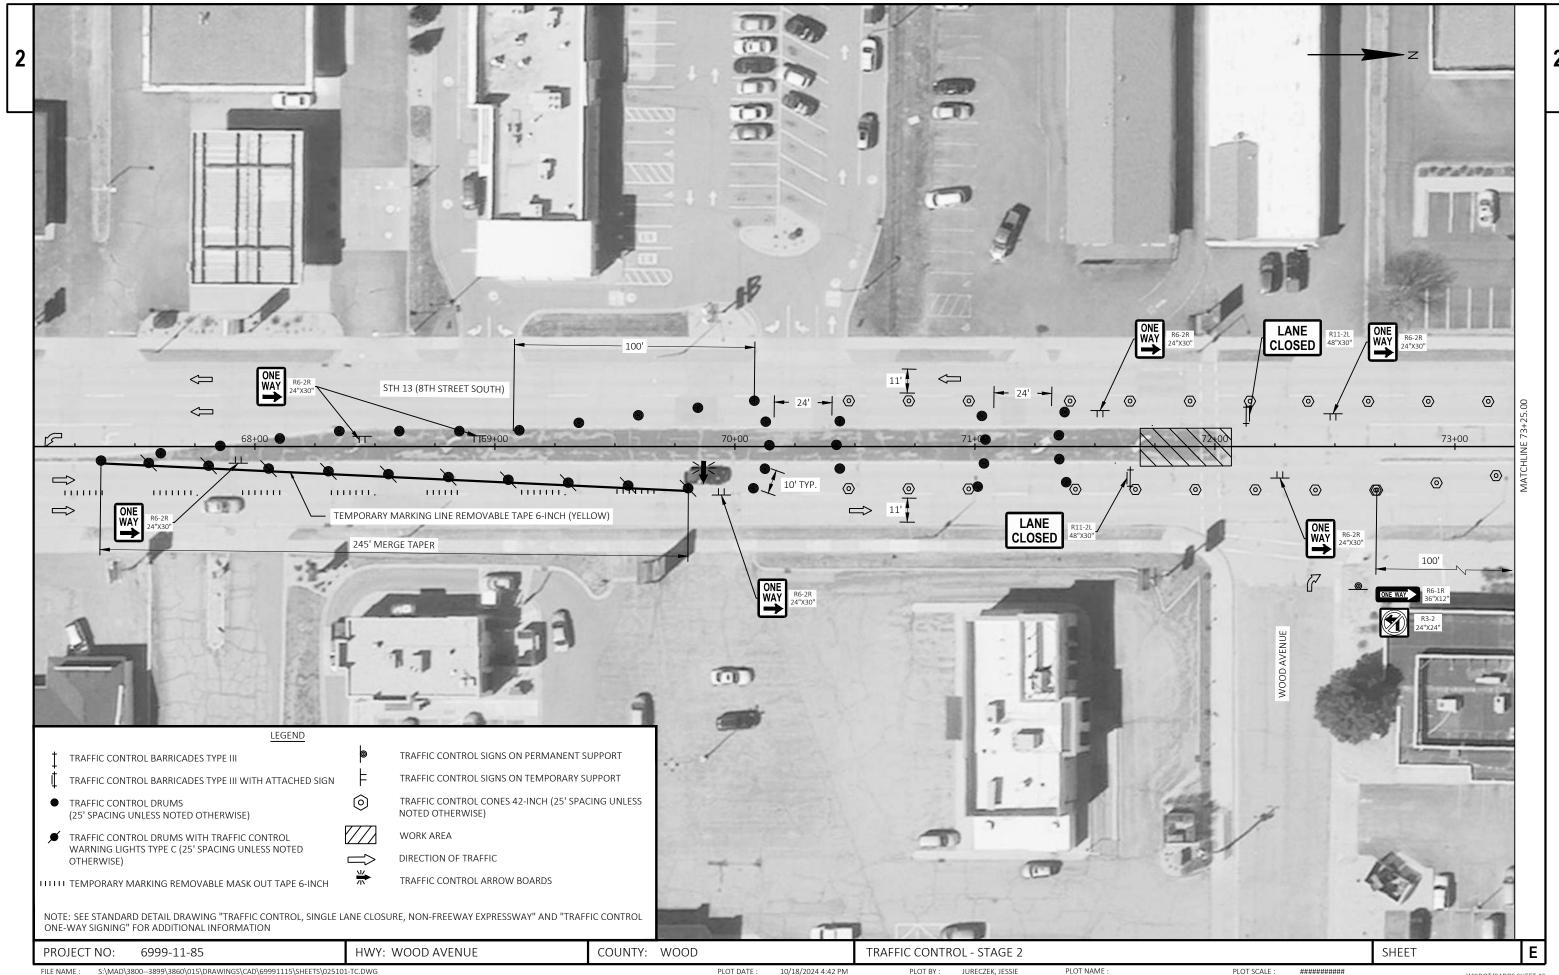

3

6999-11-85

					6999-11-85	
Line	Item	Item Description	Unit	Total	Qty	
0002	204.0100	Removing Concrete Pavement	SY	50.000	50.000	
0004	204.0110	Removing Asphaltic Surface	SY	60.000	60.000	
0006	204.0150	Removing Curb & Gutter	LF	110.000	110.000	
8000	204.0155	Removing Concrete Sidewalk	SY	60.000	60.000	
0010	211.0101	Prepare Foundation for Asphaltic Paving (project) 01. 6669-11-85	EACH	1.000	1.000	
0012	213.0100	Finishing Roadway (project) 01. 6999-11-85	EACH	1.000	1.000	
0014	305.0120	Base Aggregate Dense 1 1/4-Inch	TON	40.000	40.000	
0016	405.0100	Coloring Concrete WisDOT Red	CY	0.900	0.900	
0018	416.0610	Drilled Tie Bars	EACH	35.000	35.000	
0020	465.0105	Asphaltic Surface	TON	20.000	20.000	
0022	465.0120	Asphaltic Surface Driveways and Field Entrances	TON	3.000	3.000	
0024	601.0409	Concrete Curb & Gutter 30-Inch Type A	LF	50.000	50.000	
0026	601.0411	Concrete Curb & Gutter 30-Inch Type D	LF	36.000	36.000	
0028	601.0600	Concrete Curb Pedestrian	LF	40.000	40.000	
0030	602.0405	Concrete Sidewalk 4-Inch	SF	670.000	670.000	
0032	602.0515	Curb Ramp Detectable Warning Field Natural Patina	SF	40.000	40.000	
0034	602.0615	Curb Ramp Detectable Warning Field Radial Natural Patina	SF	14.500	14.500	
0036	619.1000	Mobilization	EACH	1.000	1.000	
0038	620.0300	Concrete Median Sloped Nose	SF	190.000	190.000	
0040	624.0100	Water	MGAL	1.200	1.200	
0042	625.0100	Topsoil	SY	4.000	4.000	
0044	627.0200	Mulching	SY	4.000	4.000	
0046	628.1905	Mobilizations Erosion Control	EACH	4.000	4.000	
0048	628.1910	Mobilizations Emergency Erosion Control	EACH	2.000	2.000	
0050	628.7010	Inlet Protection Type B	EACH	1.000	1.000	
0052	628.7015	Inlet Protection Type C	EACH	6.000	6.000	
0054	629.0210	Fertilizer Type B	CWT	0.100	0.100	
0056	630.0140	Seeding Mixture No. 40	LB	0.100	0.100	
0058	630.0500	Seed Water	MGAL	0.100	0.100	
0060	637.2210	Signs Type II Reflective H	SF	12.250	12.250	
0062	637.2230	Signs Type II Reflective F	SF	43.500	43.500	
0064	642.5001	Field Office Type B	EACH	1.000	1.000	
0066	643.0300	Traffic Control Drums	DAY	2,661.000	2,661.000	
0068	643.0420	Traffic Control Barricades Type III	DAY	321.000	321.000	
0070	643.0705	Traffic Control Warning Lights Type A	DAY	482.000	482.000	
0072	643.0715	Traffic Control Warning Lights Type C	DAY	789.000	789.000	
0074	643.0800	Traffic Control Arrow Boards	DAY	81.000	81.000	
0076	643.0900	Traffic Control Signs	DAY	1,437.000	1,437.000	
0078	643.1050	Traffic Control Signs PCMS	DAY	20.000	20.000	
0800	643.1070	Traffic Control Cones 42-Inch	DAY	1,037.000	1,037.000	
0082	643.3180	Temporary Marking Line Removable Tape 6-Inch	LF	990.000	990.000	
0084	643.3960	Temporary Marking Removable Mask Out Tape 6-Inch	LF	460.000	460.000	
0086	643.5000	Traffic Control	EACH	1.000	1.000	
0088	644.1810	Temporary Pedestrian Barricade	LF	72.000	72.000	
0090	646.7420	Marking Crosswalk Epoxy Transverse Line 6-Inch	LF	200.000	200.000	
0092	646.8120	Marking Curb Epoxy	LF	20.000	20.000	
0094	646.8220	Marking Island Nose Epoxy	EACH	2.000	2.000	
0096	646.9012	Marking Removal Line Water Blasting 6-Inch	LF	190.000	190.000	
0098	650.5500	Construction Staking Curb Gutter and Curb & Gutter	LF	166.000	166.000	

6999-11	-85
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Line	Item	Item Description	Unit	Total	Qty
0100	650.8501	Construction Staking Electrical Installations (project) 01. 6999-11-85	EACH	1.000	1.000
0102	650.9000	Construction Staking Curb Ramps	EACH	5.000	5.000
0104	650.9500	Construction Staking Sidewalk (project) 01. 6999-11-85	EACH	1.000	1.000
0106	650.9911	Construction Staking Supplemental Control (project) 01. 6999-11-85	EACH	1.000	1.000
0108	652.0605	Conduit Special 2-Inch	LF	40.000	40.000
0110	654.0101	Concrete Bases Type 1	EACH	1.000	1.000
0112	654.0102	Concrete Bases Type 2	EACH	2.000	2.000
0114	657.0100	Pedestal Bases	EACH	1.000	1.000
0116	657.0255	Transformer Bases Breakaway 11 1/2-Inch Bolt Circle	EACH	2.000	2.000
0118	657.0305	Poles Type 2	EACH	2.000	2.000
0120	657.0405	Traffic Signal Standards Aluminum 3.5-FT	EACH	1.000	1.000
0122	657.0590	Trombone Arms 20-FT	EACH	2.000	2.000
0124	658.0500	Pedestrian Push Buttons	EACH	3.000	3.000
0126	690.0150	Sawing Asphalt	LF	40.000	40.000
0128	690.0250	Sawing Concrete	LF	230.000	230.000
0130	ASP.1T0A	On-the-Job Training Apprentice at \$5.00/HR	HRS	150.000	150.000
0132	ASP.1T0G	On-the-Job Training Graduate at \$5.00/HR	HRS	300.000	300.000
0134	SPV.0060	Special 01. Rectangular Rapid Flashing Beacon (RRFB) System - STA. 71+82 LT	EACH	1.000	1.000
0136	SPV.0060	Special 02. Rectangular Rapid Flashing Beacon (RRFB) System - STA. 71+82 RT	EACH	1.000	1.000
0138	SPV.0090	Special 01. Concrete Curb & Gutter 24-Inch Type A Special	LF	40.000	40.000
0140	SPV.0090	Special 02. Posts Round Tubular Steel 2 3/8-Inch	LF	10.500	10.500

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REMOVING CONCRETE PAVEMENT		REM	OVING ASP	PHALTIC SURF	ACE			l	<u>REMOVI</u>	ING CURB	& GUTTE	R		
204.0100 CATEGORY STATION - STATION LOCATION SY		CATEGORY	STATION -	STATION LOCATI	204.0110 ON SY			CATEGORY	STATI	ON - STATI	ON LOCATI	204.015 ON LF	50	
0010 71+69 - 72+07 LT/RT 50		0010	71+69 -	72+07 LT/R				0010		69 - 72+0			_	
REMOVING CONCRETE SIDEWALK		PREPARE FC	OUNDATION	I FOR ASPHAL	TIC PAVING			FINISI	HING RO	YAWDAC				
204.0155 CATEGORY STATION - STATION LOCATION SY		CATEGORY	DD(	O IFOT	211.0101			0475005	21/	213.0100				
0010 71+69 - 72+07 LT/RT 60		CATEGORY 0010		OJECT 9-11-85	EACH 1			CATEGOR 0010	<del>₹</del> Υ	EACH 1				
									BAS	SE AGGREC	GATE SUN	/IMARY		
DRILLED BAR SUMMARY			ASPHALTI	IC SURFACE					BAS	SE AGGREC	GATE SUN	305.0		624
416.0610 DRILLED TIE BARS	CATEGORY	STATION		IC SURFACE		DRIVEWAYS AND FIELD ENTRANCES 465.0120 TON	CATEG	GORY S			GATE SUN		se Te dense Inch	٧
416.0610 DRILLED	CATEGORY 0010	STATION 71+69	- STATION		465.0105	FIELD ENTRANCES 465.0120	CATEG		Station -			305.0 BA AGGREGA 1 1/4-	SE Te dense Inch N	62 V ř
416.0610 DRILLED TIE BARS CATEGORY STATION - STATION LOCATION EACH			- STATION	LOCATION	465.0105 TON	FIELD ENTRANCES 465.0120 TON			Station -	- STATION	LOCATION	305.0 BA' AGGREGA' 1 1/4- TO	SE Te dense Inch N	V
416.0610 DRILLED TIE BARS CATEGORY STATION - STATION LOCATION EACH	0010		- STATION	LOCATION	465.0105 TON	FIELD ENTRANCES 465.0120 TON		0	STATION - 71+69 -	- STATION - 72+07	LOCATION	305.0 BA' AGGREGA' 1 1/4- TO	SE Te dense Inch N	١
CATEGORY STATION - STATION LOCATION EACH  0010 71+69 - 72+07 LT/RT 35	0010 R SUMMARY 1 601.0600 SPV.0090.01	71+69 650.55	- STATION - 72+07	LOCATION	465.0105 TON	FIELD ENTRANCES 465.0120 TON	001	0	STATION - 71+69 -	- STATION - 72+07 MMARY	LOCATION  LT/RT  5 60	305.0 BA AGGREGA 1 1/4- TO 40	SE Te dense Inch N	•
CATEGORY   STATION   STATION   STATION   LOCATION   EACH	O010  R SUMMARY  1 601.0600 SPV.0090.01 CONCRETE CUE URB & GUTTER	71+69 650.55	- STATION - 72+07	LOCATION	465.0105 TON	FIELD ENTRANCES 465.0120 TON	CONCRETE 40	SIDEWA	STATION - 71+69 - ALK SUN 502.0405	- STATION - 72+07  /MARY  602.0511	LOCATION  LT/RT  5 60 CUI	305.C BA' AGGREGA' 1 1/4- TO 40 40 2.0615 RB RAMP ECTABLE	SE TE DENSE INCH N  650.900	10
CATEGORY STATION - STATION LOCATION EACH  0010 71+69 - 72+07 LT/RT 35  CONCRETE CURB & GUTTER  601.0409 601.0417  CONCRETE CURB CONCRETE C & GUTTER & GUTTER	O010  R SUMMARY  1 601.0600 SPV.0090.01 CONCRETE CUE URB & GUTTER R CONCRETE 24-INCH	71+69 650.55	- STATION - 72+07 000	LOCATION	465.0105 TON	FIELD ENTRANCES 465.0120 TON	CONCRETE  40  CO	SIDEWA 05.0100 & 0LORING 0NCRETE C	STATION - 71+69 - ALK SUM 502.0405	- STATION - 72+07  /MARY  602.0511	LOCATION  LT/RT  5 60 CUI  MP DET  ILE WARI	305.0 BA' AGGREGA' 1 1/4- TO 40 2.0615	SE TE DENSE INCH N  650.900	)O
CATEGORY STATION - STATION LOCATION EACH  0010 71+69 - 72+07 LT/RT 35  CONCRETE CURB & GUTTER  601.0409 601.0412  CONCRETE CURB CONCRETE C  & GUTTER  30-INCH  TYPE A  TYPE D	O010  R SUMMARY  1 601.0600 SPV.0090.01 CONCRETE CUF URB & GUTTER R CONCRETE 24-INCH CURB TYPE A PEDESTRIAN SPECIAL	71+69 650.55 RB CONSTRUCTIO CURB GUTT CURB & G	- STATION - 72+07 - 000  N STAKING ER AND UTTER	LOCATION	465.0105 TON 20	FIELD ENTRANCES 465.0120 TON  3	CONCRETE 40 CO CC W	SIDEWA 05.0100 & 0LORING 0NCRETE C VISDOT S RED	STATION - 71+69 - 602.0405 CONCRETE SIDEWALK 4-INCH	- STATION - 72+07 - 72+07 - 602.051! - CURB RAN DETECTAB WARNING FI NATURAL PA	LOCATION  LT/RT  5 60 CUI  MP DET  ILE WART	305.C BA' AGGREGA' 1 1/4- TO 40 40 2.0615 RB RAMP FECTABLE VING FIELD ADIAL RAL PATINA	GE TE DENSE INCH N  650.900  CONSTRUC STAKIN CURB RAM	100 TIC G
CATEGORY STATION - STATION LOCATION EACH  0010 71+69 - 72+07 LT/RT 35  CONCRETE CURB & GUTTER  601.0409 601.041  CONCRETE CURB CONCRETE CURB & GUTTER  8 GUTTER  8 GUTTER  30-INCH 30-INCH	O010  R SUMMARY  1 601.0600 SPV.0090.01 CONCRETE CUF URB & GUTTER R CONCRETE 24-INCH CURB TYPE A	71+69 650.55 RB CONSTRUCTIO CURB GUTT	- STATION - 72+07 - 000  N STAKING ER AND UTTER	LOCATION	465.0105 TON	FIELD ENTRANCES 465.0120 TON  3	CONCRETE 40 CO CC W	SIDEWA 05.0100 & 0LORING 0NCRETE C	STATION - 71+69 - 602.0405 CONCRETE GIDEWALK	- STATION - 72+07 - 72+07 - 602.051! - CURB RAN DETECTAB WARNING FI	LOCATION  LT/RT  5 60 CUI  MP DET  SILE WART  IELD F  TINA NATUI	305.C BA' AGGREGA' 1 1/4- TO 40 40 22.0615 RB RAMP FECTABLE NING FIELD	SE TE DENSE INCH N  650.900  CONSTRUC STAKIN	100 TIC G

MISCELLANEOUS QUANTITIES

PLOT BY : \_\_\_\_\_

PLOT NAME :

COUNTY: WOOD

HWY: WOOD AVENUE

PROJECT NO: 6999-11-85

Ε

SHEET:

PLOT SCALE: 1" = 1"

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	MOBILIZATION		CONCRETE MEDI	AN SLOPED NC	SE					FINISHING	SUMMARY			
		619.1000			620.0300					625.0100	627.0200	629.0210	630.0140 SEEDING	630.0500
CATEGORY	PROJECT	EACH	<u>CATEGORY STATION - :</u>	STATION LOCATION	N SF							FERTILIZER	MIXTURE	SEED
										TOPSOIL	MULCHING	TYPE B	NO. 40	WATER
0010	6999-11-85	1	0010 71+69 -	72+07 LT/RT	190	CATEG	ory station	- STATION	LOCATION	SY	SY	CWT	LB	MGAL
						001	0 71+69	- 72+07	RT/LT	4	4	0.1	0.1	0.1

MOBILIZATIONS EROSION CONTRO
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	CATEGORY	PROJECT	628.1905 EACH	
_	0010	6999-11-85	4	

#### MOBILIZATIONS EMERGENCY EROSION CONTROL

		628.1910	
 CATEGORY	PROJECT	EACH	
0010	6999-11-85	2	

INLET P	ROTECTION	SUMMARY
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			628.7010	628.7015	
			INLET	INLET	
			PROTECTION	PROTECTION	
			TYPE B	TYPE C	
CATEGORY	STATION - STATION	LOCATION	EACH	EACH	
0010	71+69 - 72+07	LT/RT	1	6	

FIELD OFFICE TYPE B							
		/ 42 F001					
CATEGORY	PROJECT	642.5001 EACH					
0010	6999-11-85	1					

TRAF	FIC CONTROL	
CATEGORY	PROJECT	643.5000 EACH
0010	6999-11-85	1

	:	SA	WING S	UMMAR\	1	
					690.0150	690.0250
					SAWING	SAWING
					ASPHALT	CONCRETI
CATEGORY	STATION	-	STATION	LOCATION	LF	LF
0010	71+69	-	72+07	LT/RT	40	230

PROJECT NO: 6999-11-85 HWY: WOOD AVENUE COUNTY: WOOD MISCELLANEOUS QUANTITIES SHEET: **E** 

FILE NAME : \_\_\_\_\_ PLOT DATE : \_\_\_\_ PLOT NAME : PLOT SCALE : 1" = 1" WISDOT/CADDS SHEET 42

#### 3

#### PERMANENT SIGNING SUMMARY

									637.2210 SIGNS	637.2230 SIGNS	SPV.0090.02 POSTS ROUND
							SI	GN	TYPE II	TYPE II	TUBULAR STEEL
							SI	ZE	REFLECTIVE H	REFLECTIVE F	2 3/8-INCH
	APPROX.		SIGN	SIGN	SIGN		(W	x H)			
CATEGORY	STA.	LOC.	TYPE	SIZE	CODE	SIGN MESSAGE	l	N	SF	SF	LF
0010											
		==									
	71+82	MEDIAN	_	2M	W11-2	PEDESTRIAN CROSSING SYMBOL	36	х 36		9	
	71+82	MEDIAN	2	2M	W11-2	PEDESTRIAN CROSSING SYMBOL	36	х 36		9	
	71+82	MEDIAN	2	2M	W16-7R	RIGHT DIAGONAL DOWNWARD POINTING ARROW (YELLOW)	30	x 18		3.75	
	71+82	MEDIAN	2	2M	R10-25	PUSH BUTTON TO TURN ON WARNING LIGHTS	9	x 12	0.75		
	71+82	MEDIAN	2	2M	R4-7	KEEP RIGHT	24	x 30	5		
	71+82	LT	2	2M	R10-25	PUSH BUTTON TO TURN ON WARNING LIGHTS	9	x 12	0.75		
	71+89	RT	2	2M	W11-2	PEDESTRIAN CROSSING SYMBOL	36	x 36		9	
	71+89	RT	2	2M	W11-2	PEDESTRIAN CROSSING SYMBOL	36	x 36		9	
	71+89	RT	2	2M	W16-7L	LEFT DIAGONAL DOWNWARD POINTING ARROW (YELLOW)	30	x 18		3.75	
	71+89	RT	2	2M	R10-25	PUSH BUTTON TO TURN ON WARNING LIGHTS	9	x 12	0.75		
	71+93	MEDIAN	2	2M	R4-7	KEEP RIGHT	24	x 30	5		10.5
						-	TO	TALS	12.25	43.5	10.5

#### TRAFFIC CONTROL SUMMARY

				0300 CONTROL	TRAFFIC	.1070 Control Ones	TRAFFIC	.0420 CONTROL ICADES	TRAFFIC	0705 Control G Lights	TRAFFIC	.0715 CONTROL IG LIGHTS	643.	0800 CONTROL		.0900 CONTROL	643. TRAFFIC (	1050 CONTROL	644.1810 TEMPORAR PEDESTRIA
		DURATION		JMS		INCH		PE III		EA		PE C	ARROW			GNS		PCMS	BARRICADE
CATEGORY	DESCRIPTION	(DAYS)	EACH	DAY	EACH	DAY	EACH	DAY	EACH	DAY	EACH	DAY	EACH	DAY	EACH	DAY	EACH	DAY	LF
0010	STAGE 1 - PHASE 1																		
	PEDESTRIAN ROUTING	<u> </u>													7	140			36
	ADVANCED WARNING	20													10	200	3	13	
	ROADWAY	20	41	820	9	180	13	260	18	360	10	200	1	20	7	140			
		STAGE 1 - PHASE 1 SUBTOTALS		820		180		260		360		200		20		480		13	36
0010	STAGE 1 - PHASE 2																		
	PEDESTRIAN ROUTING	21													7	147			36
	ADVANCED WARNING	21													9	189	1	7	
	ROADWAY	21	21	441	17	357	1	21	2	42	9	189	1	21	1	21			
		STAGE 1 - PHASE 2 SUBTOTALS		441		357		21		42		189		21		357		7	36
		STAGE 1 SUBTOTALS		1,261		537		281		402		389		41		837		20	72
0010	STAGE 2																		
	PEDESTRIAN ROUTING	<del></del> 20													2	40			
	ADVANCED WARNING	20													11	220			
	ROADWAY	20	70	1,400	25	500	2	40	4	80	20	400	2	40	17	340			
		STAGE 2 SUBTOTALS		1,400		500		40		80		400		40		600		0	0
		TOTALS		2,661		1,037		321		482		789		81		1,437		20	72

PROJECT NO:	6999-11-85	HWY: WOOD AVENUE	COUNTY: WOOD	MISCELLANEOUS QUANTITIES			SHEET:	E
EII E NAME :			DLOT DATE .	DLOT DV .	DI OT NAME :	DIOT COALE. 4" 4"	WIEDOT/CADDS SI	JEET 42

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	TEM	IP(	ORARY N	/IARKING	ITEMS		
					643.3960 TEMPORARY MARKING REMOVABLE MASK OUT	643.3180 TEMPORARY MARKING LINE REMOVABLE	
CATEGORY	STATION	-	STATION	LOCATION	TAPE 6-INCH LF	TAPE 6-INCH LF	
0010	71+69	-	72+07	LT/RT	460	990	

	PAVEMENT MARKING ITEMS								
					646.7420 MARKING	646.8120	646.8220	646.9012 MARKING	
					CROSSWALK	MARKING	MARKING	REMOVAL	
					EPOXY TRANSVERSE	CURB	ISLAND NOSE	LINE WATER	
					6-INCH	EPOXY	EPOXY	BLASTING	
					(WHITE)	(YELLOW)	(YELLOW)	6-INCH	
CATEGORY	STATION	-	STATION	LOCATION	LF	LF	EACH	LF	
0010	71+69	-	72+07	LT/RT	200	20	2	190	

CONSTRUCTION S	STAKING ELECTRICAL	INSTALLATIONS
CATEGORY	PROJECT	650.8501 EACH
0010	6999-11-85	1

CATEGORY

SPECIAL

2-INCH

STATION LOCATION

71+81.9' 1' LT 71+81.9' 38' LT 71+82.3' 38' RT BASES

TYPE 1

EACH

CONSTRUCTION STAKING SIDEWALK		
	650.9500	
CATEGORY	EACH	
0010	1	

RECTANGULAR RAPID FLASHING BEACON EQUIPMENT SUMMARY

CATEGORY	650.9911 EACH	
0010	1	_

1

CONSTRUCTION STAKING SUPPLEMENTAL CONTROL


#### 652.0605 654.0101 654.0102 657.0100 657.0305 657.0255 657.0405 657.0590 658.0500 SPV.0060.01 SPV.0060.02 TRANSOFRMER TRAFFIC SIGNAL CONDUIT CONCRETE CONCRETE PEDESTRIAN RECTANGULAR RAPID RECTANGULAR RAPID BASES BREAKAWAY STANDARDS BASES PEDESTAL POLES 11 1/2-INCH ALUMINUM TROMBONE ARMS PUSH FLASHING BEACON (RRFB) FLASHING BEACON (RRFB) TYPE 2 BASES TYPE 2 BOLT CIRCLE 3.5-FT 20-FT BUTTONS SYSTEM - STA. 71+82 LT SYSTEM - STA. 71+82 RT EACH EACH EACH EACH EACH EACH EACH EACH


PROJECT NO: 6999-11-85 HWY: WOOD AVENUE COUNTY: WOOD MISCELLANEOUS QUANTITIES SHEET: Ε


PLOT DATE : \_\_\_ PLOT BY: PLOT NAME : PLOT SCALE: 1" = 1" WISDOT/CADDS SHEET 42

### Standard Detail Drawing List

08D01-23A	CONCRETE CURB & GUTTER
08D01-23B	CONCRETE CURB, TIES AND CURB AND GUTTER APPLICATIONS
08D05-21A	CURB RAMPS TYPES 1 AND 1-A
08D05-21B	CURB RAMPS TYPES 2 AND 3
08D05-21C	CURB RAMPS TYPES 4A AND 4A1
08D05-21D	CURB RAMPS TYPE 4B AND 4B1
08D05-21E	CURB RAMPS TYPES 5, 6, 7A, 7B & 8
08D05-21F	CURB RAMPS RADIAL DETECTABLE WARNING FIELD APPLICATIONS
08D05-21G	CURB RAMPS RECTANGULAR AND RADIAL DETECTABLE WARNING PLATES
08E10-02	INLET PROTECTION TYPE A, B, C AND D
09в02-10	CONDUIT
09C02-09	CONCRETE BASES, TYPES 1, 2, 5, & 6
09C03-04	TRANSFORMER/PEDESTAL BASES
09E01-15A	POLE MOUNTINGS FOR TRAFFIC SIGNALS TYPE 2
09E07-06	TRAFFIC SIGNAL STANDARD PEDESTRIAN AND FLASHER TYPICAL MOUNTING DETAILS
11B02-02	CONCRETE MEDIAN NOSE
15C02-09A	BARRICADES AND SIGNS FOR MAINLINE CLOSURES
15С02-09В	BARRICADES AND SIGNS FOR VARIOUS CLOSURES
15C03-05	BARRICADES AND SIGNS FOR SIDEROAD CLOSURES
15С11-10В	CHANNELIZING DEVICES DRUMS, CONES, BARRICADES AND VERTICAL PANELS
15С18-08В	MEDIAN ISLAND MARKING MEDIAN ISLAND NOSE
15C33-05	STOP LINE AND CROSSWALK PAVEMENT MARKING
15D20-08A	TRAFFIC CONTROL, SINGLE LANE CLOSURE, DIVIDED NON-FREEWAY/EXPRESSWAY
15D21-07A	TRAFFIC CONTROL, INTERSECTION WITHIN SINGLE LANE CLOSURE
15D21-07B	TRAFFIC CONTROL, INTERSECTION WITHIN SINGLE LANE CLOSURE
15D30-09A	TRAFFIC CONTROL, PEDESTRIAN ACCOMMODATION
15D30-09B	TRAFFIC CONTROL, PEDESTRIAN ACCOMMODATION
15D30-09C	TRAFFIC CONTROL, PEDESTRIAN ACCOMMODATION
15D30-09K	TRAFFIC CONTROL, PEDESTRIAN ACCOMMODATION
15D46-01	TRAFFIC CONTROL, ONE - WAY SIGNING

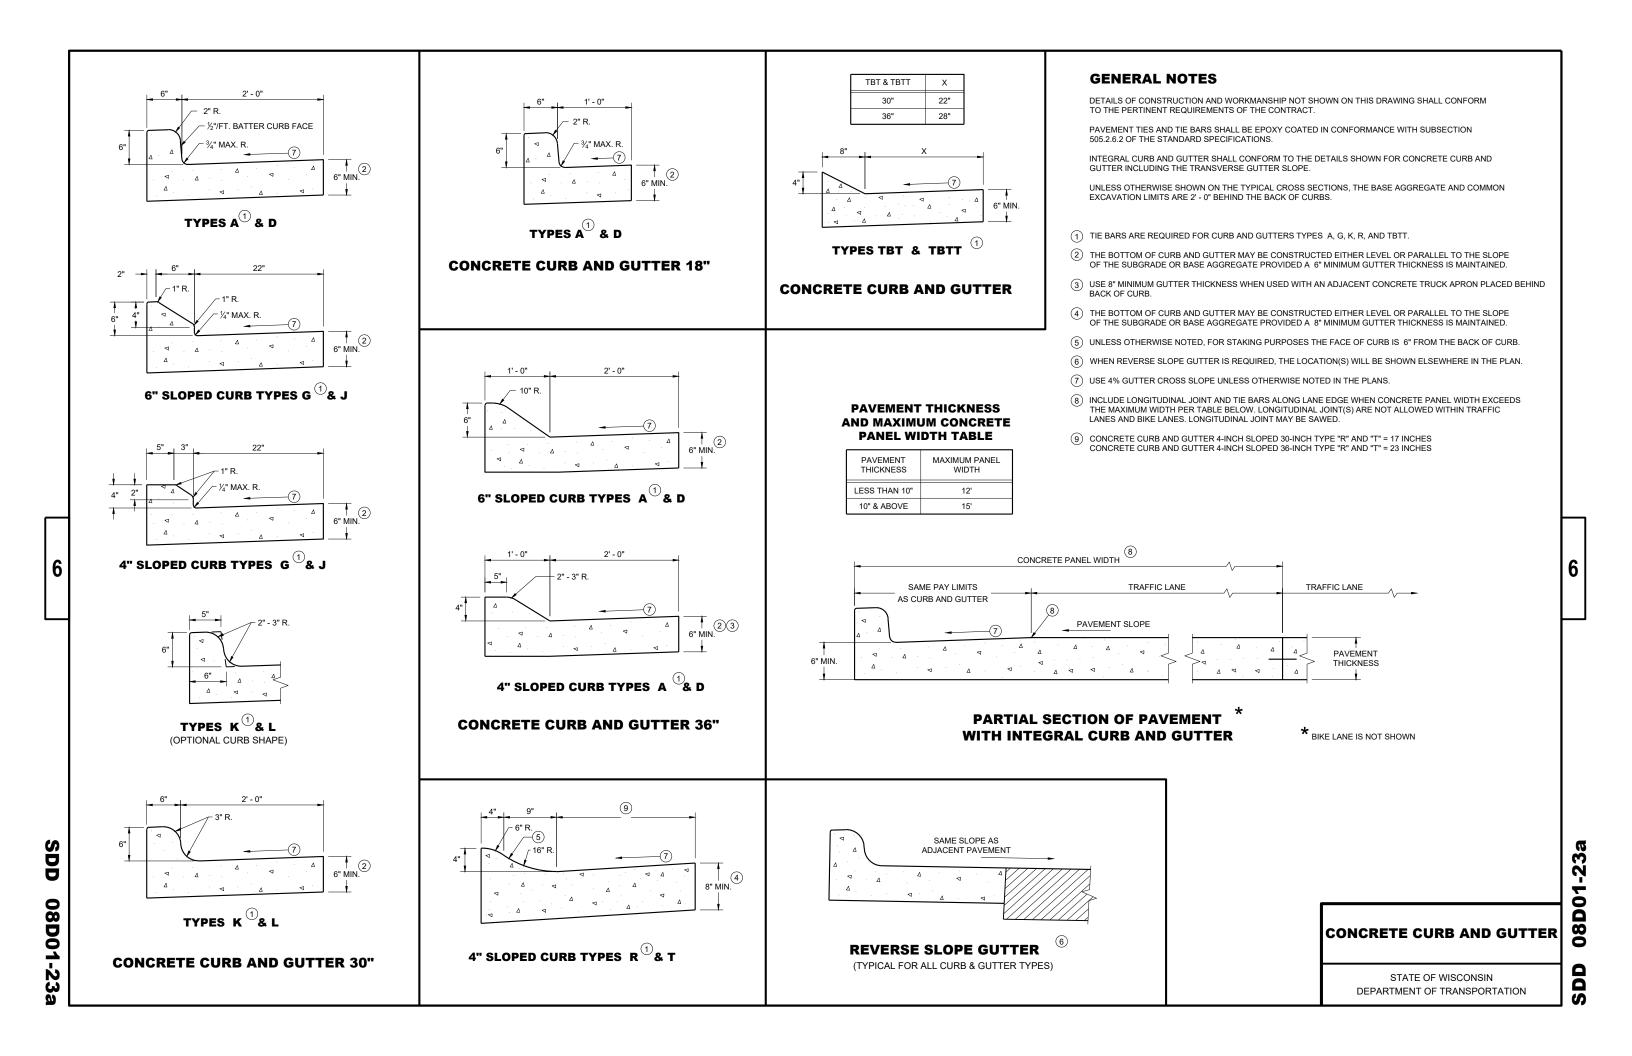

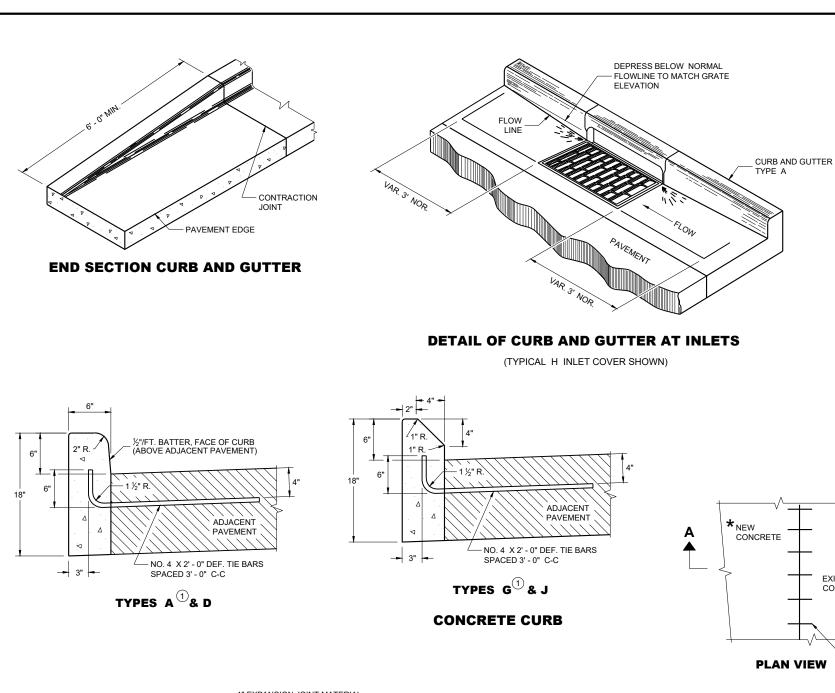

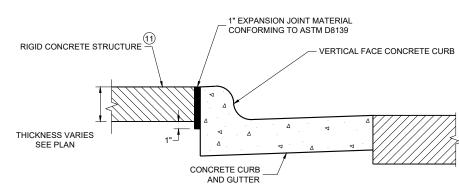

EXPANSION JOINT DETAIL FOR VERTICAL CURB ABUTTING A RIGID STRUCTURE 119

#### CONCRETE **EXISTING** CONCRETE \* NEW CURB AND GUTTER, SURFACE DRAINS, CONCRETE PAVEMENT OR OTHER NEW CONCRETE. **PLAN VIEW** NO. 6 TIE BARS SPACED 2' - 6" C-C, INSTALLED PERPENDICULAR TO THE CONCRETE MAXIMUM DRILL HOLE SIZE IS 1/8" GREATER THAN TIE BAR DIAMETER 1/2 THICKNESS OF\_ NEW CONCRETE **EXISTING**

TIE BARS DRILLED INTO EXISTING PAVEMENT

**SECTION A - A** 


#### **GENERAL NOTES**

DETAILS OF CONSTRUCTION AND WORKMANSHIP NOT SHOWN ON THIS DRAWING SHALL CONFORM TO THE PERTINENT REQUIREMENTS OF THE CONTRACT.


PAVEMENT TIES AND TIE BARS SHALL BE EPOXY COATED IN CONFORMANCE WITH SUBSECTION 505.2.6.2 OF THE STANDARD SPECIFICATIONS.

UNLESS OTHERWISE SHOWN ON THE TYPICAL CROSS SECTIONS, THE BASE AGGREGATE AND COMMON EXCAVATION LIMITS ARE 2'- 0" BEHIND THE BACK OF CURBS.

- 1) TIE BARS ARE REQUIRED FOR CURB AND GUTTERS TYPES A, G, K, R, AND TBTT.
- (2) THE BOTTOM OF CURB AND GUTTER MAY BE CONSTRUCTED EITHER LEVEL OR PARALLEL TO THE SLOPE OF THE SUBGRADE OR BASE AGGREGATE PROVIDED A 6" MINIMUM GUTTER THICKNESS IS MAINTAINED.
- 10 REFER TO SDD 08D18 AND 08D19 FOR ADDITIONAL DRIVEWAY ENTRANCE CURB DETAILS.
- (1) PLACE 1" THICK EXPANSION JOINT MATERIAL BETWEEN VERTICAL FACE CURB TYPES EXTENDING FROM THE TOP OF CURB TO 1 INCH BELOW THE ADJOINING CONCRETE SURFACE. RIGID CONCRETE STRUCTURES INCLUDE RAISED CONCRETE MEDIANS, CONCRETE SAFETY ISLANDS, SPLITTER ISLANDS, OR LOCATIONS IDENTIFIED ON THE PLANS.

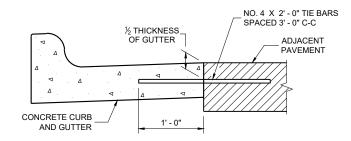

TYPICAL TIE BAR LOCATION

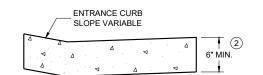

DRIVEWAY ENTRANCE CURB

(WHEN DIRECTED BY THE ENGINEER)

# CONCRETE CURB, TIES AND CURB AND GUTTER APPLICATIONS


STATE OF WISCONSIN
DEPARTMENT OF TRANSPORTATION


APPROVED

May 2023
DATE
ROADWAY STANDARDS DEVELOPMENT
UNIT SUPERVISOR

SDD 08D01-23b

08D01-2

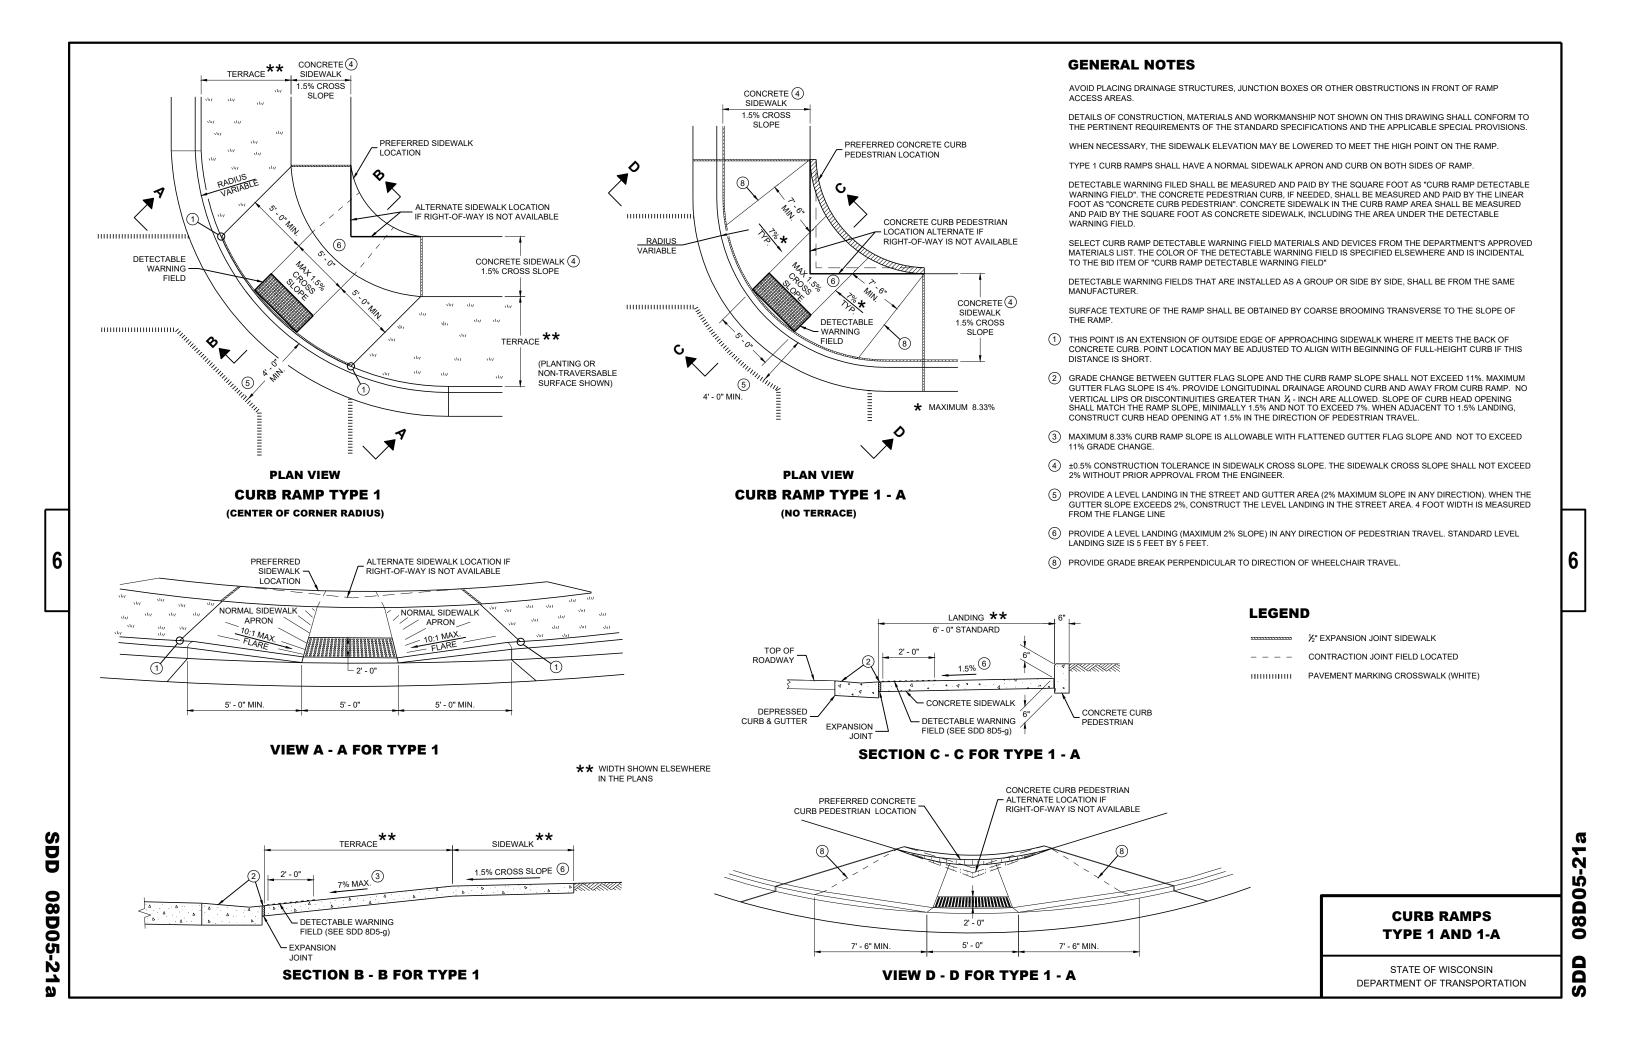


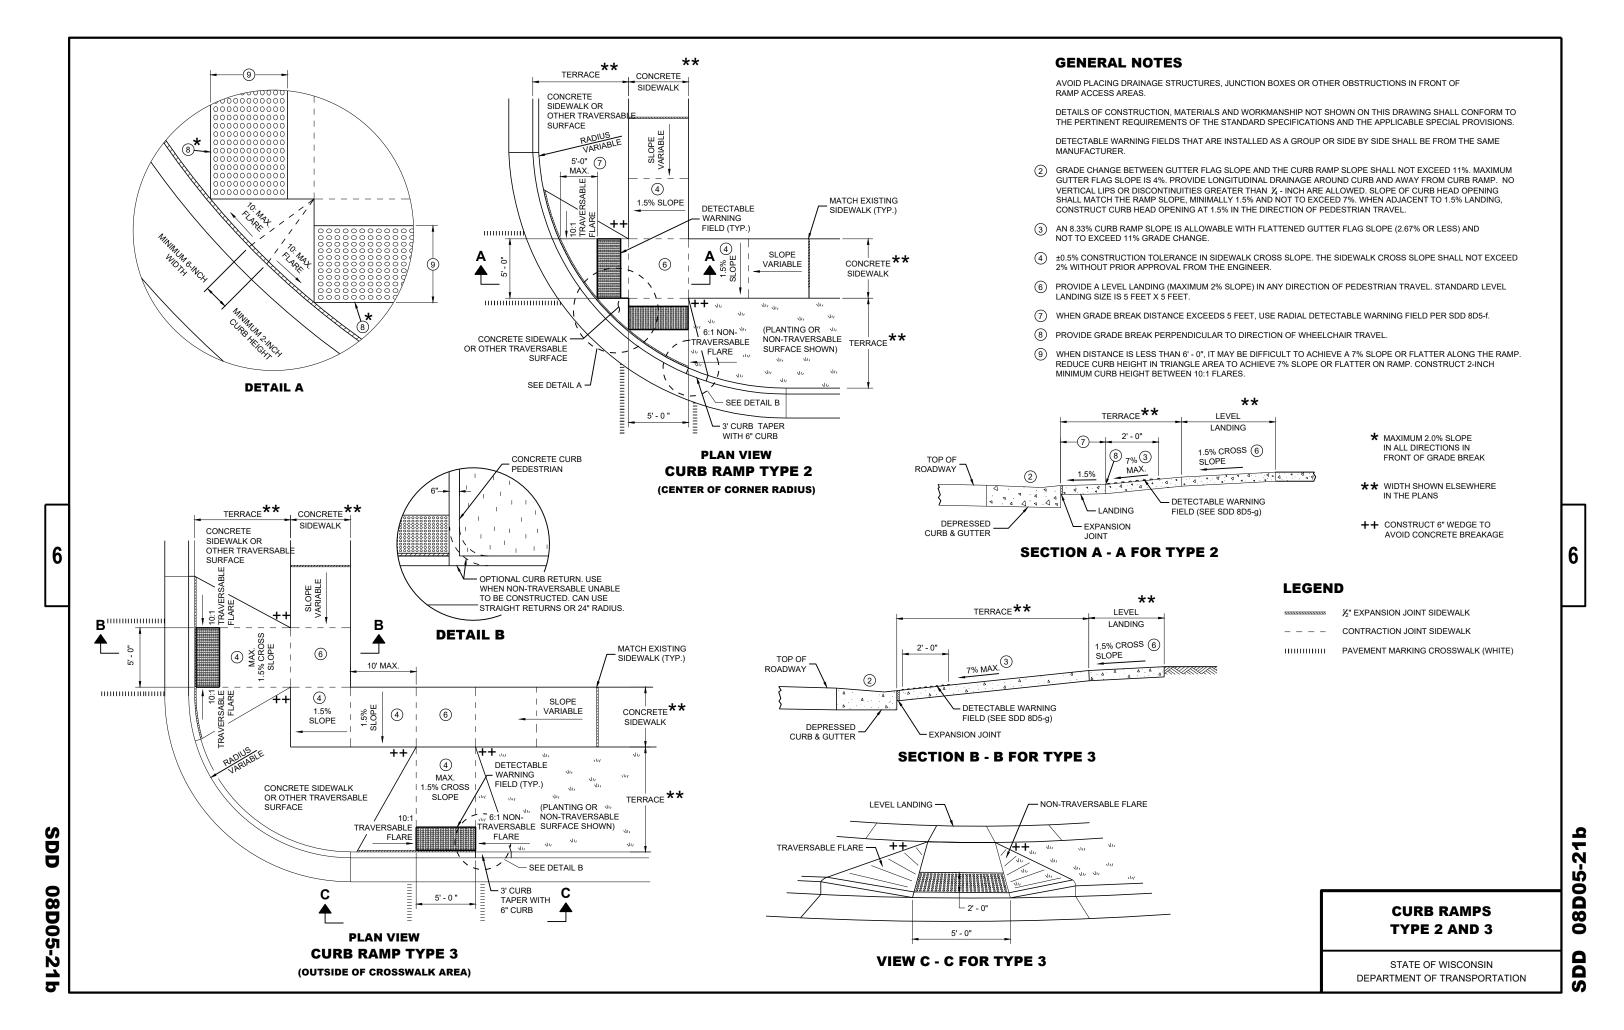



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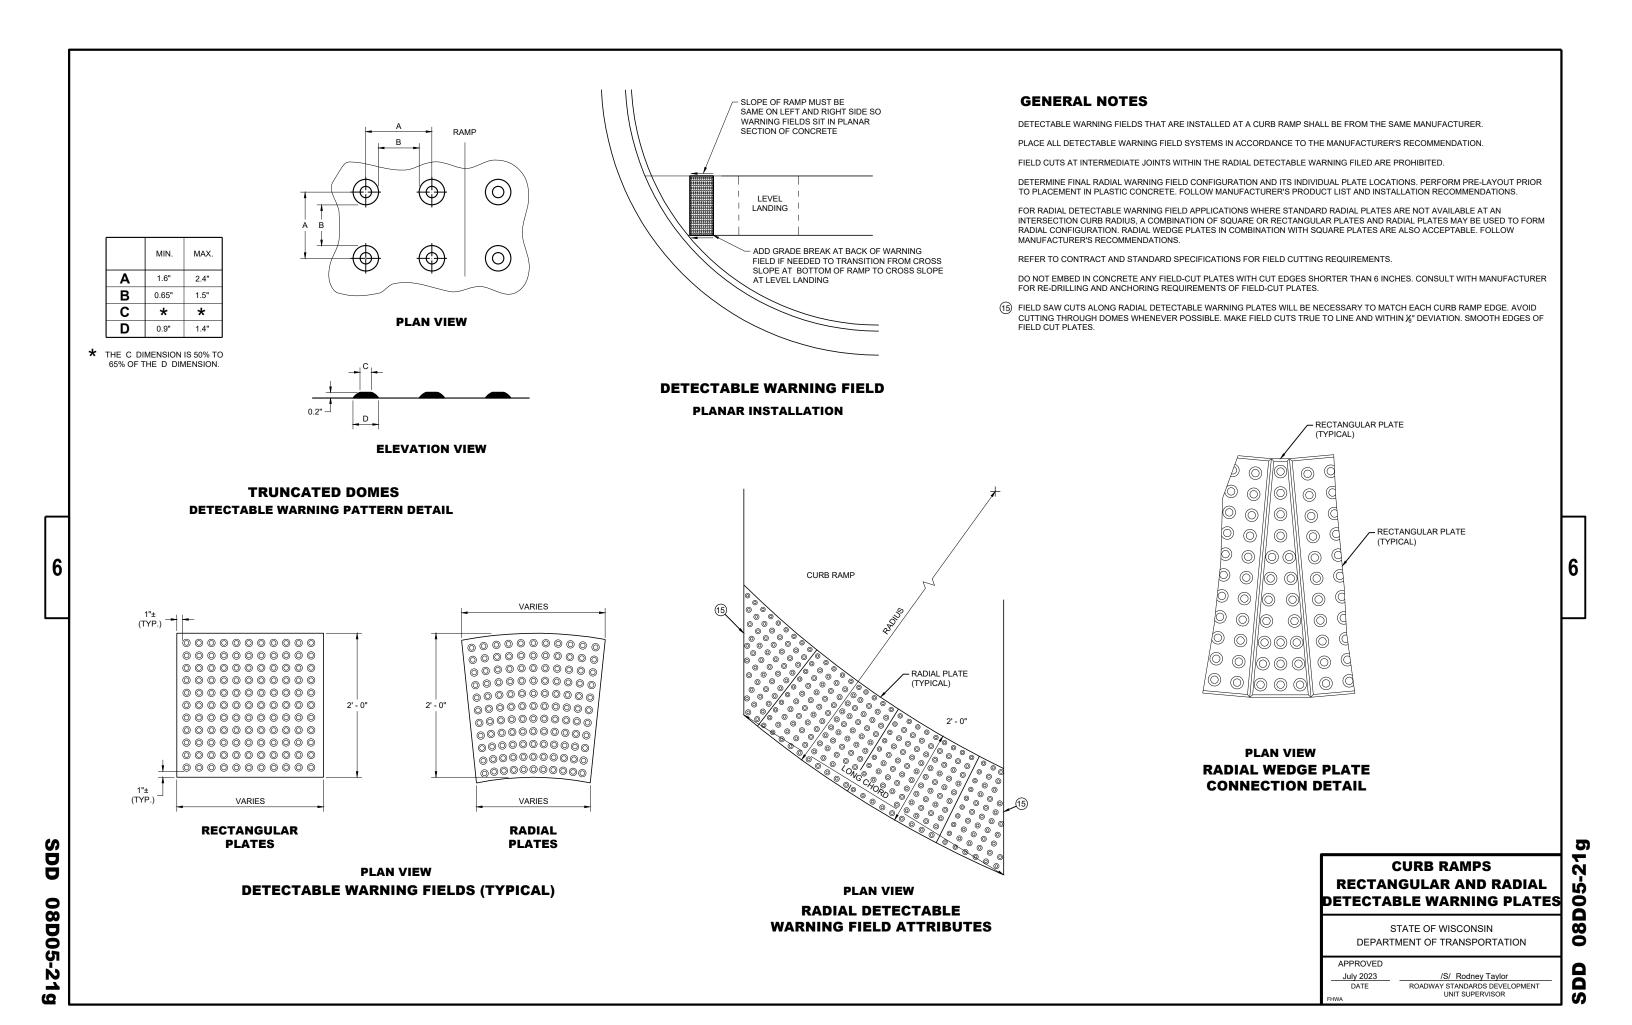
08D0


STATE OF WISCONSIN DEPARTMENT OF TRANSPORTATION




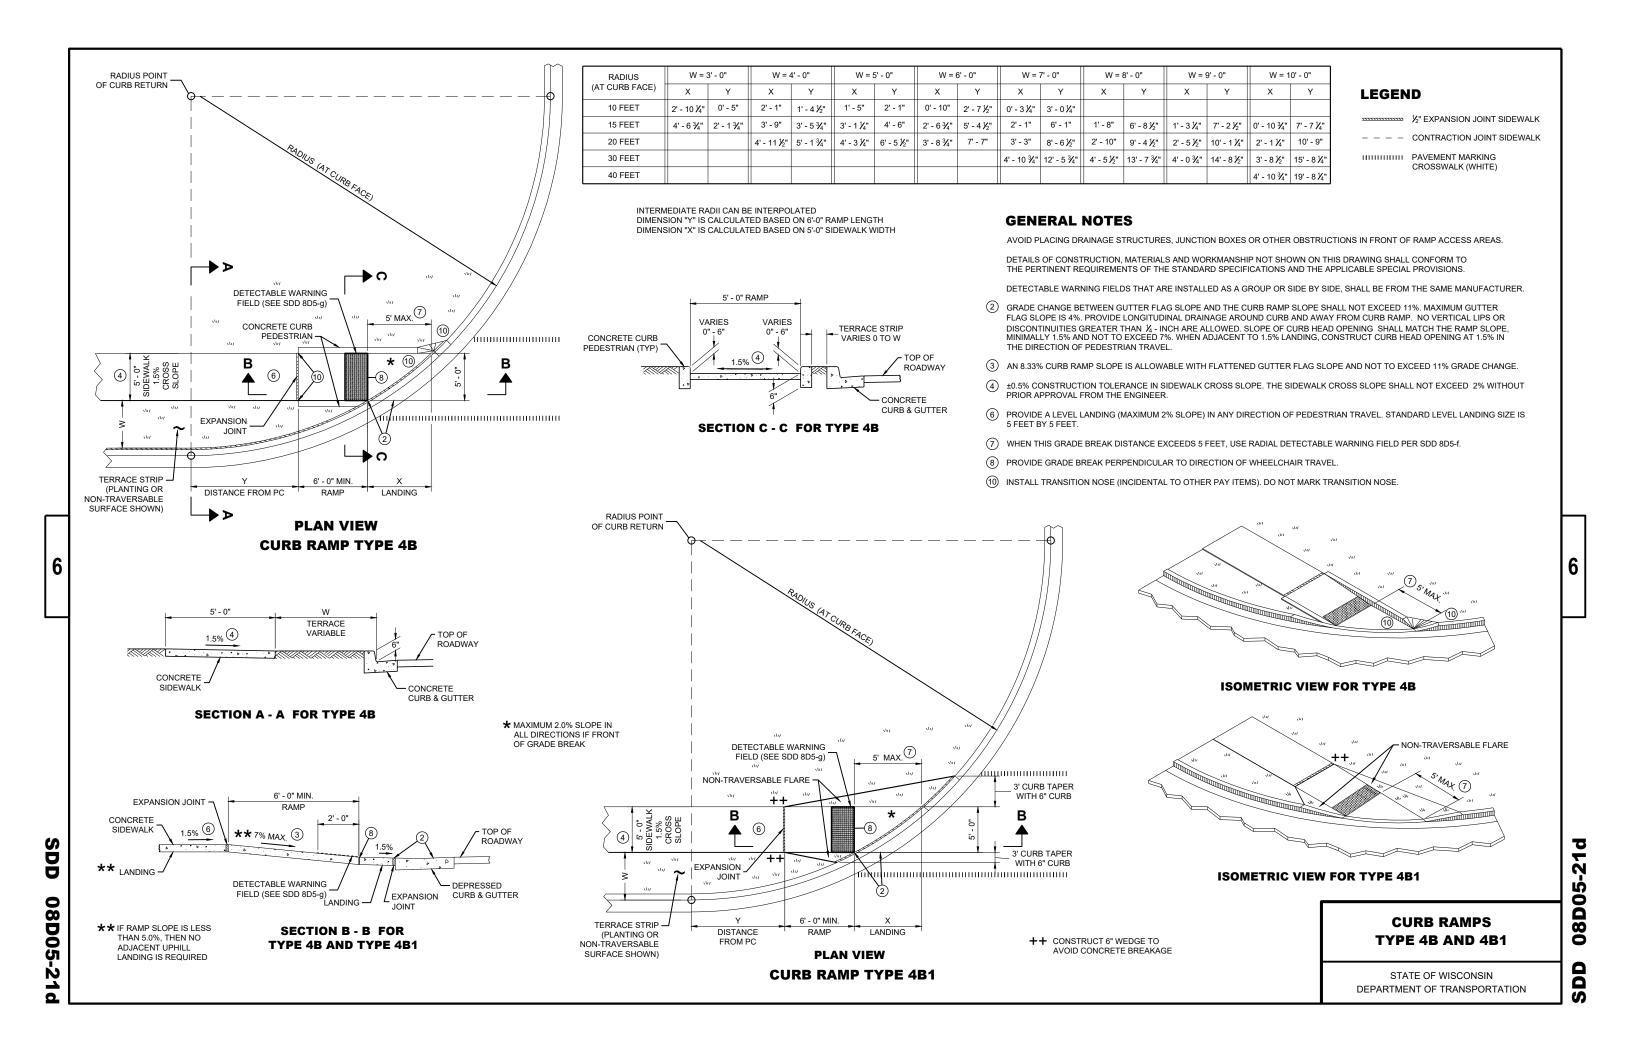

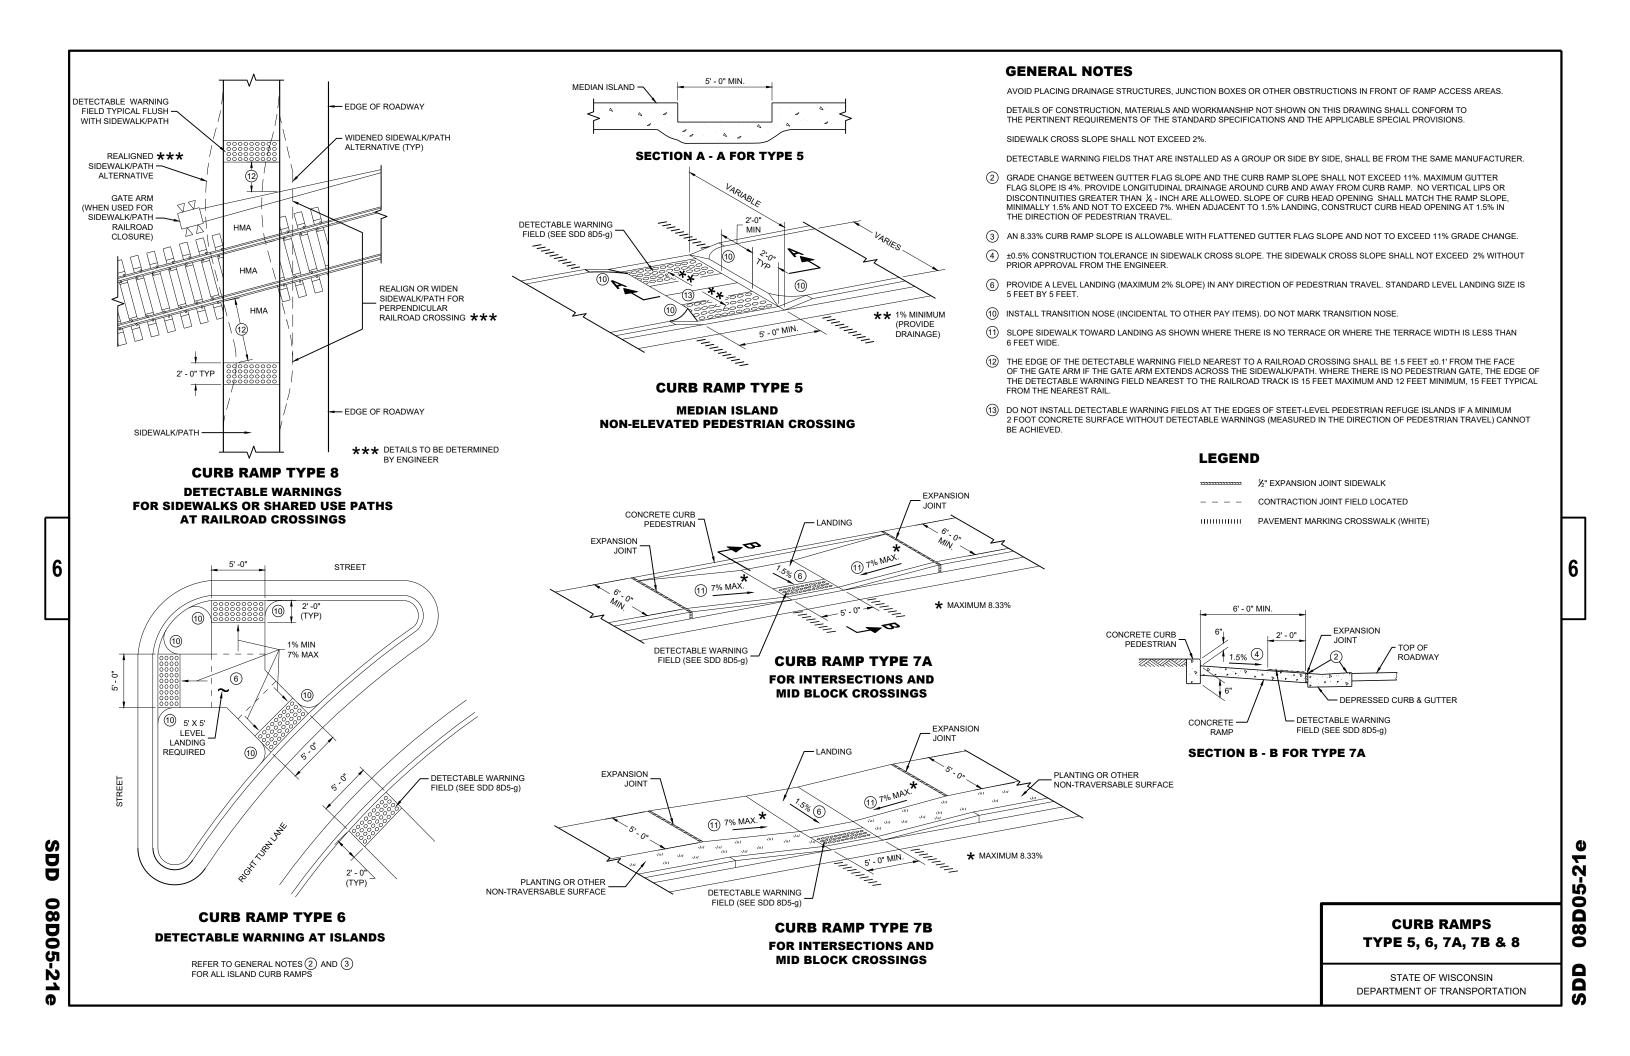

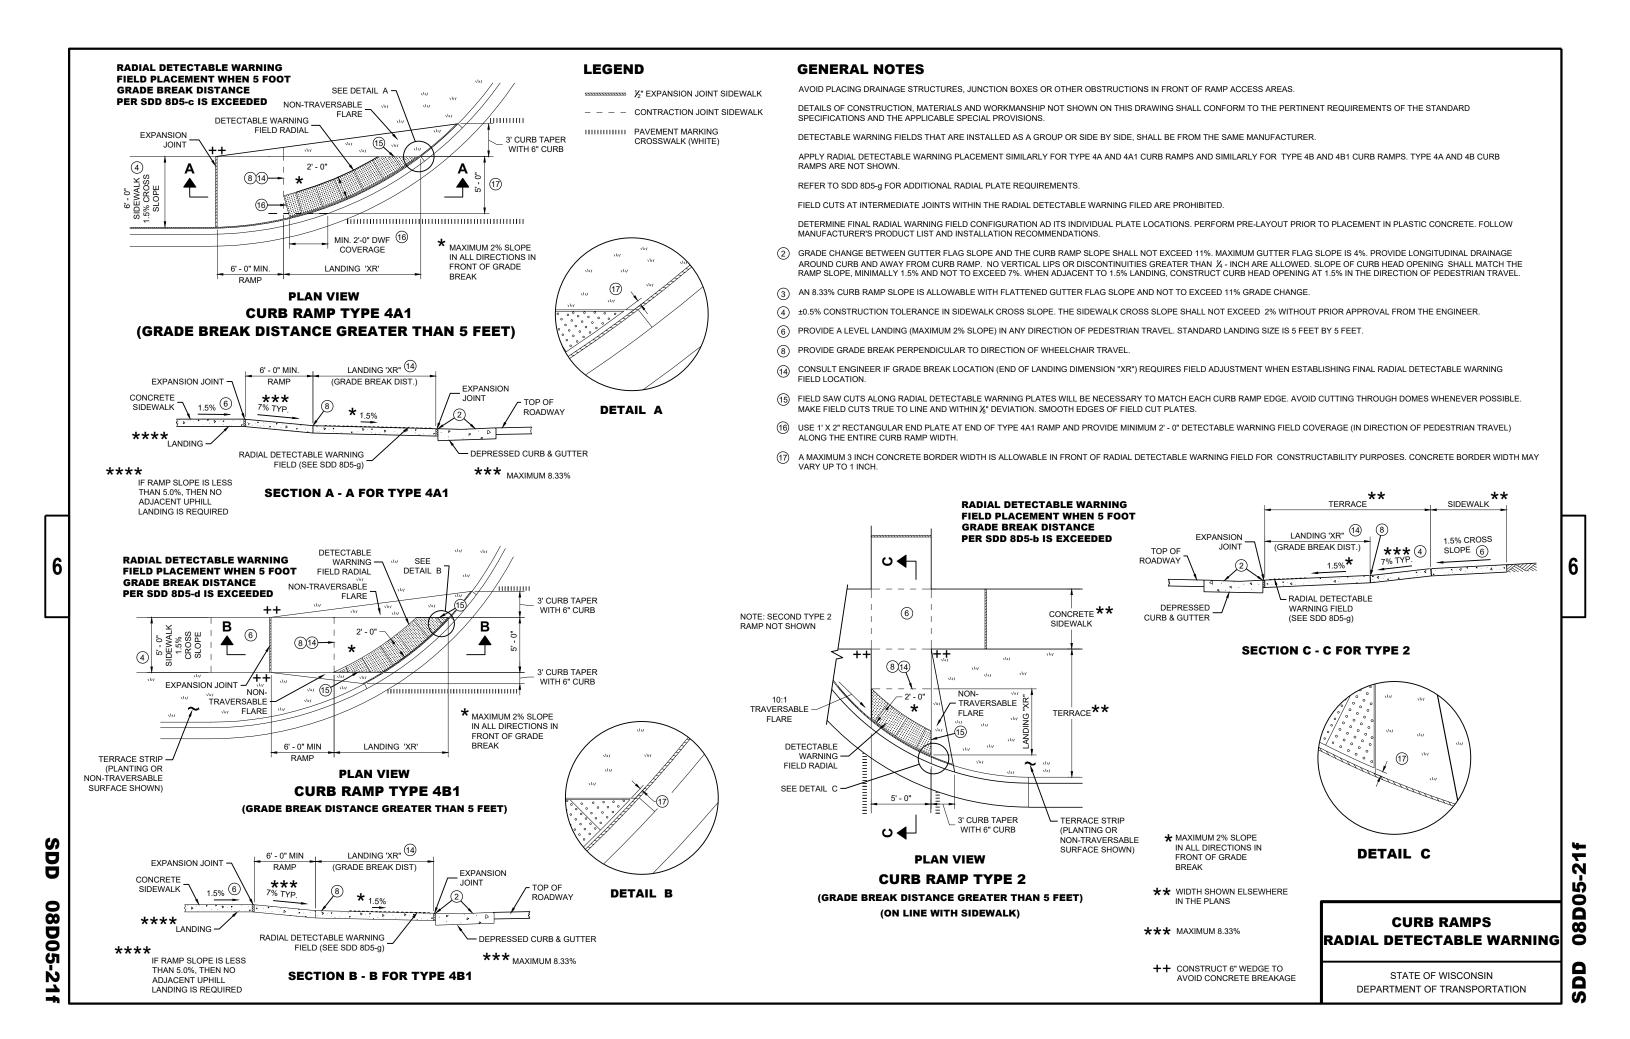

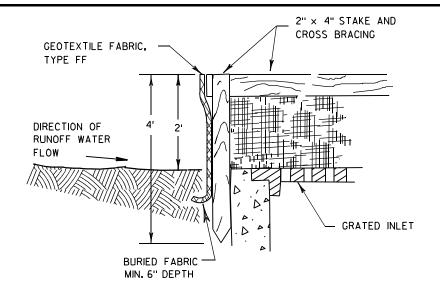

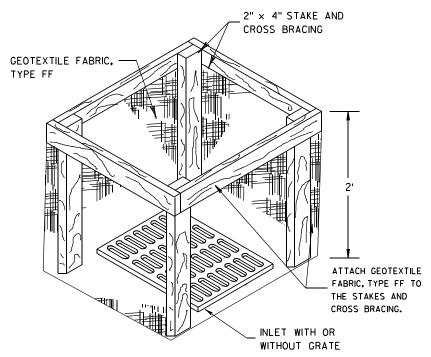

### INLET PROTECTION, TYPE A


### **GENERAL NOTES**

INLET PROTECTION DEVICES SHALL BE MAINTAINED OR REPLACED AT THE DIRECTION OF THE ENGINEER.

MANUFACTURED ALTERNATIVES APPROVED AND LISTED ON THE DEPARTMENT'S EROSION CONTROL PRODUCT ACCEPTABILITY LIST MAY BE

WHEN REMOVING OR MAINTAINING INLET PROTECTION, CARE SHALL BE TAKEN SO THAT THE SEDIMENT TRAPPED ON THE GEOTEXTILE FABRIC DOES NOT FALL INTO THE INLET. ANY MATERIAL FALLING INTO THE INLET SHALL BE REMOVED IMMEDIATELY.

- 1) FINISHED SIZE, INCLUDING FLAP POCKETS WHERE REQUIRED, SHALL EXTEND A MINIMUM OF 10" AROUND THE PERIMETER TO FACILITATE MAINTENANCE OR REMOVAL.
- (2) FOR INLET PROTECTION, TYPE C (WITH CURB BOX), AN ADDITIONAL 18" OF FABRIC IS WRAPPED AROUND THE WOOD AND SECURED WITH STAPLES. THE WOOD SHALL NOT BLOCK THE ENTIRE HEIGHT OF THE CURB BOX OPENING.
- (3) FLAP POCKETS SHALL BE LARGE ENOUGH TO ACCEPT WOOD 2X4.

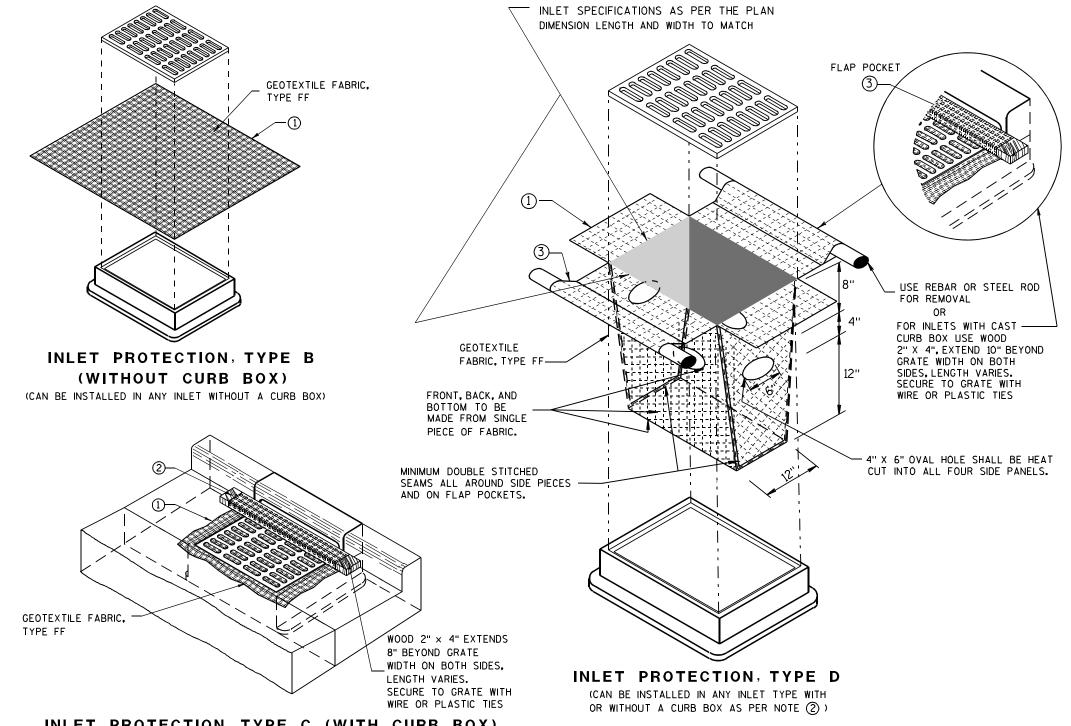

### INLET PROTECTION, TYPE C (WITH CURB BOX)

### **INSTALLATION NOTES**

### TYPE B & C

TRIM EXCESS FABRIC IN THE FLOW LINE TO WITHIN 3" OF THE GRATE.

THE CONTRACTOR SHALL DEMONSTRATE A METHOD OF MAINTENANCE, USING A SEWN FLAP, HAND HOLDS OR OTHER METHOD TO PREVENT ACCUMULATED SEDIMENT FROM ENTERING THE INLET.

### TYPE D

DO NOT INSTALL INLET PROTECTION TYPE D IN INLETS SHALLOWER THAN 30", MEASURED FROM THE BOTTOM OF THE INLET TO THE TOP OF THE GRATE.

TRIM EXCESS FABRIC IN THE FLOW LINE TO WITHIN 3" OF THE GRATE.

THE INSTALLED BAG SHALL HAVE A MINIMUM SIDE CLEARANCE, BETWEEN THE INLET WALLS AND THE BAG, MEASURED AT THE BOTTOM OF THE OVERFLOW HOLES, OF 3". WHERE NECESSARY THE CONTRACTOR SHALL CINCH THE BAG, USING PLASTIC ZIP TIES, TO ACHIEVE THE 3" CLEARANCE, THE TIES SHALL BE PLACED AT A MAXIMUM OF 4" FROM THE BOTTOM OF THE BAG.

### INLET PROTECTION TYPE A, B, C, AND D

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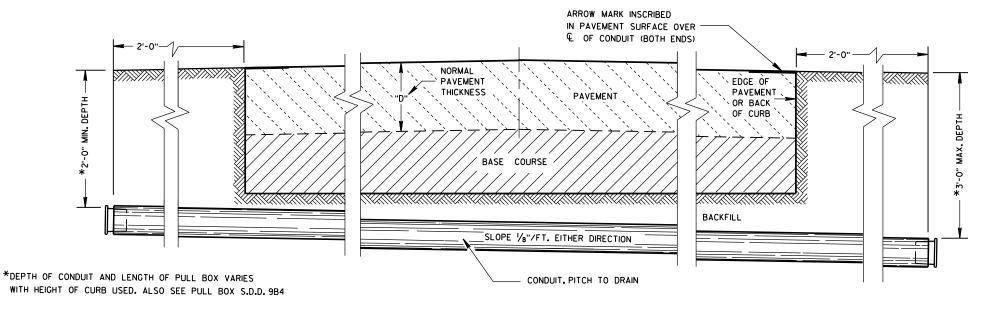
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STATE OF WISCONSIN DEPARTMENT OF TRANSPORTATION

APPROVED

/S/ Beth Cannestra CHIEF ROADWAY DEVELOPMENT ENGINEER

10/16/02



### SIDE ELEVATION DETAIL FOR CONDUIT UNDER PAVED HIGHWAYS

### **GENERAL NOTES**

DETAILS OF CONSTRUCTION, MATERIALS AND WORKMANSHIP NOT SHOWN ON THIS DRAWING SHALL CONFORM TO THE PERTINENT REQUIREMENTS OF THE CONTRACT.

METALLIC (STANDARD SPECIFICATION 652.2.2) OR NONMETALLIC (STANDARD SPECIFICATION 652.2.3) CONDUIT SHALL BE FURNISHED AND PLACED AS SHOWN.

DEPTH OF CONDUIT INSTALLED BELOW THE TRAVELED WAY SHALL BE 24 INCHES MINIMUM AND 36 INCHES MAXIMUM.

DEPTH OF CONDUIT INSTALLED THAT IS NOT BELOW THE TRAVELED WAY SHALL BE 18 INCHES MINIMUM AND 36 INCHES MAXIMUM.

ANY EXCEPTION TO THE MAXIMUM DEPTH SHALL BE ONLY WITH THE WRITTEN APPROVAL OF THE ENGINEER.

THE TRENCH SHALL NOT BE BACKFILLED PRIOR TO INSPECTION OF THE CONDUIT.

ALL METALLIC CONDUIT RACEWAY ENDS SHALL BE REAMED AND THREADED.

ALL METALLIC CONDUIT IN WHICH WIRE OR CABLE IS TO BE INSTALLED SHALL BE BUSHED WITH APPROVED THREADED BUSHINGS BEFORE INSTALLATION OF THE WIRE OR CABLE.

ALL METALLIC CONDUITS IN WHICH WIRE OR CABLE IS NOT TO BE INSTALLED SHALL BE CAPPED WITH THREADED PROTECTIVE CAPS, AS APPROVED BY THE ENGINEER.

ALL NONMETALLIC CONDUIT SHALL BE CAPPED OR PLUGGED IMMEDIATELY AFTER INSTALLATION AND SHALL REMAIN CAPPED OR PLUGGED UNTIL WIRE/CABLES ARE INSTALLED.

NONMETALLIC CONDUITS IN WHICH WIRE OR CABLE IS NOT BEING INSTALLED SHALL REMAIN CAPPED OR PLUGGED.

BENDING OF PVC ELECTRICAL CONDUIT SHALL BE ACCOMPLISHED BY USING A BLANKET OR EMERSION TYPE TANK DESIGNED FOR THE PURPOSE OF BENDING PVC ELECTRICAL CONDUIT.

ALL CUT ENDS SHALL BE TRIMMED INSIDE AND OUTSIDE TO REMOVE ALL ROUGH EDGES ON NONMETALLIC CONDUIT. (SEE NEC 347.5)

WHEN REQUIRED TO CONNECT NONMETALLIC CONDUIT TO METALLIC CONDUIT, ONLY U.L.LISTED ADAPTER FITTINGS SHALL BE USED.

PRIOR TO CONDUIT ACCEPTANCE, CONDUIT CAPS OR PLUGS SHALL BE REMOVED, AND THE CAPS, PLUGS AND CONDUIT ENDS SHALL BE THOROUGHLY CLEANED AND THEN THE CAPS OR PLUGS REIN-STALLED TO ENSURE THAT THE CAPS OR PLUGS CAN BE EASILY REMOVED IN THE FUTURE.

ALL CONDUIT BEING FURNISHED AND INSTALLED SHALL HAVE THE U.L. LABEL FIRMLY

CONDUIT RUNS SHALL BE THE SAME SIZE OF CONDUIT FROM ONE END TO THE OTHER (FROM PULL BOX TO PULL BOX-OR-JUNCTION BOX TO JUNCTION BOX-OR-BASE TO BASE, ETC.).

TRACER WIRE SHALL BE INSTALLED AS STATED IN THE STANDARD SPECIFICATION, ITEM 652.3.1.1.

ALL CONDUIT RUNS SHALL BE STRAIGHT (WITHOUT BENDS) FROM PULL BOX TO PULL BOX, PULL BOX TO BASE AND BASE TO BASE AS SHOWN ON THE PLANS.


CONDUIT

STATE OF WISCONSIN DEPARTMENT OF TRANSPORTATION

APPROVED /S/ Ahmet Demirbilek DATE STATE ELECTRICAL ENGINEER

FHWA

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<b>FORMING</b>	<b>DETAIL</b>

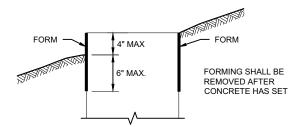QUANTITY	CONCRETE BASE TYPE								
REQUIREMENTS	1	2	5 & 6						
APPROX. CUBIC YARDS OF CONCRETE	0.40	0.57	0.40						
LBS. OF HOOP BAR STEEL	NONE	23	16						
LBS. OF VERTICAL BAR STEEL	NONE	60	18						

1" CONDUIT

**PURPOSES** 

CONDUIT WITHIN

6" DIA.

FOR GROUNDING

### **GENERAL NOTES**

CONDUIT

11 1/2" BOLT CIRCLE

(OUT TO OUT)

DETAILS OF CONSTRUCTION, MATERIALS AND WORKMANSHIP NOT SHOWN ON THIS DRAWINGSHALL CONFORM TO THE PERTINENT REQUIREMENTS OF THE CONTRACT.

BASES SHALL BE EXCAVATED BY USE OF A CIRCULAR AUGER.

TOP SURFACES OF CONCRETE BASES SHALL BE TROWEL FINISHED SMOOTH AND LEVEL.

CONDUIT SIZES AND LOCATIONS SHALL BE SHOWN ON THE PLANS

THE FINAL OR TERMINATING CONCRETE BASE IN A CONDUIT RUN SHALL HAVE A 6" EXIT STUB INSTALLED FOR FUTURE CABLING USE. THE EXIT STUB SHALL BE SIZED AS USED THROUGHOUT THE CONDUIT RUN AS SHOWN A THE ENTRANCE OF THE BASE.

ENDS OF CONDUIT INSTALLED BELOW GRADE FRO FUTURE USE SHALL BE CAPPED IF METALLIC OR PLUGGED IF NON-METALLIC.

MINIMUM BENDING RADIUS OF CONDUIT IS EQUAL TO 6X THE DIAMETER.

1" CONDUIT

**PURPOSES** 

6" DIA.

ANCHOR RODS SHALL BE

ORIENTED PARALLEL TO

THE ROADWAY

CONDUIT

11 1/2" BOLT CIRCLE

FOR GROUNDING

CONDUIT WITHIN

CONDUIT

CONDUIT HEIGHT ABOVE CONCRETE BASES SHALL BE 1 INCH. ALL METALLIC CONDUIT ENDS SHALL BE REAMED AND THREADED.

ALL CONDUIT ENDS AT THE TOP OF CONCRETE BASES SHALL BE CAPPED IF METALLIC OR PLUGGED IF NON-METALLIC IMMEDIATELY AFTER PLACEMENT AND BEFORE CONCRETE IS POURED. CONDUITS IN WHICH WIRE OR CABLE IS NOT INSTALLED SHALL REMAIN CAPPED

L 2"

**TYPE 5 & 6** 

BELL ENDS SHALL BE INSTALLED ON ALL PVC CONDUIT EXPOSED AT THE TOP OF CONCRETE BASES BEFORE INSTALLATION.

WHEN REQUIRED TO CONNECT NON-METALLIC CONDUIT TO METALLIC CONDUIT, ONLY ADAPTER FITTINGS, U.L. LISTED FOR ELECTRICAL USE, SHALL BE USED.

IF A BASE REQUIRES A DEEP FORM BECAUSE OF LOOSE DIRT OR FILL, THE FORM SHALL BE REMOVED BEFORE BACKFILLING AROUND THE BASE. BACKFILL SHALL BE TAMPED TIGHT AGAINST THE BARE CONCRETE BASE IN LAYERS OF 1 FOOT OR LESS.

A NO. 4 AWG STRANDED COPPER EQUIPMENT GROUNDING CONDUCTOR SHALL BE EXOTHERMICALLY WELDED TO THE EQUIPMENT GROUNDING ELECTRODE (GROUND ROD) FOR TYPE 2, TYPE 5 AND TYPE 6 BASES.

THE EQUIPMENT GROUNDING CONDUCTOR SHALL BE FURNISHED AND INSTALLED TO ENTER ALL BASE TYPES THROUGH A 1 INCH CONDUIT INSTALLED FOR GROUNDING PURPOSES, LEAVING A 4 FOOT COIL OF WIRE ABOVE THE CONCRETE BASE. THE EQUIPMENT GROUNDING CONDUCTOR SHALL BE NEATLY COILED AND THE COILS

ANCHOR RODS SHALL BE THREADED 12" IN LENGTH ON EACH END OF THE ROD. ANCHOR RODS SHALL BE MANUFACTURED IN ACCORDANCE WITH SECTION 654.2.1 OF THE STANDARD SPECIFICATIONS.

WASHERS AND LOCK WASHERS ARE REQUIRED ON ALL ANCHOR RODS.

WHEN ANCHOR RODS USING THE ALTERNATE "L" BEND ARE FURNISHED, THE 4 INCH"L" BEND SHALL BE IN ADDITION TO THE SPECIFIED ANCHOR ROD BAR LENGTH. THE "L" BEND SHALL NOT BE THREADED.

ANCHOR RODS SHALL BE INSTALLED WITH MISALIGNMENTS OF LESS THAN 1:40 FROM VERTICAL

WELDING OF THE ANCHOR RODS TO THE CAGE IS UNACCEPTABLE. TIE WIRES SHALL BE USED

BAR STEEL REINFORCEMENT SHALL BE COATED WITH POWDERED EPOXY RESIN IN ACCORDANCE WITH SECTION 505 OF THE STANDARD SPECIFICATIONS (LATEST EDITION).

- THE MINIMUM DEPTH OF CONDUIT EXITING THE CONCRETE BASE AND INSTALLED BELOW THE TRAVELED WAY SHALL BE 24 INCHES. THE MINIMUM DEPTH OF CONDUIT EXITING THE CONCRETE BASE THAT IS NOT INSTALLED BELOW THE TRAVELED WAY SHALL BE 18 INCHES. THE MAXIMUM DEPTH OF ALL CONDUIT SHALL BE 36 INCHES EXCEPT WITH WRITTEN APPROVAL OF THE ENGINEER.
- (2) (4) 1" DIA. X 3' 6" ANCHOR RODS.
- (3) (4) 1" DIA. X 5' 0" ANCHOR RODS.
- (6) NO. 6 X 6' 8" BAR STEEL REINFORCEMENT.
- (7) NO. 4 X 5' 1" BAR STEEL REINFORCEMENT @ 1' 0" C C.
- (4) 1" DIA. X 3' 6" ANCHOR RODS.
- (6) NO. 4 X 4' 8" BAR STEEL REINFORCEMENT.
- (8) (5) NO. 4  $\times$  5' 1" BAR STELL REINFORCEMENT @ 1' 0" C -C.
- EXOTHERMIC CONNECTION TO EUIPMENT GROUNDING CONDUCTOR
- (10) 5/8" DIA. X 8'-0" COPPERCLAD EQUIPMENT GROUNDING ELECTRODE REQUIRED
- ANY ANCHOR ROD PROJECTION SHORTER THAN 2 3/4" OR LONGER THAN 3 1/4" SHALL REQUIRE THE BASE TO BE REMOVED AND REPLACED AT THE CONTRACTORS EXPENSE.
- 12) FOR NON BREAKAWAY INSTALLATIONS, 4 ½" ± ANCHOR ROD PROJECTION WITH THE USE OF LEVELING NUTS, RODENT SCREEN REQUIRED.

### **CONCRETE BASES TYPES 1, 2, 5, & 6**

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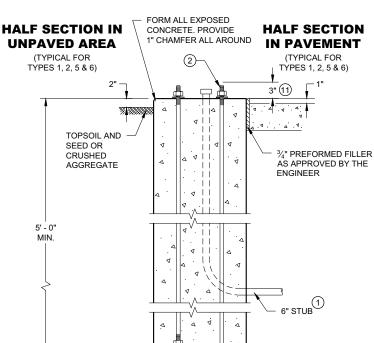
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STATE OF WISCONSIN DEPARTMENT OF TRANSPORTATION


APPROVED May 2019 DATE STATE ELECTRICAL ENGINEER


CONDUIT CONDUIT WITHIN 12 3/4" BOLT CIRCLE 6" DIA ANCHOR RODS SHALL BE ORIENTED PARALLEL TO THE ROADWAY



TYPE 1



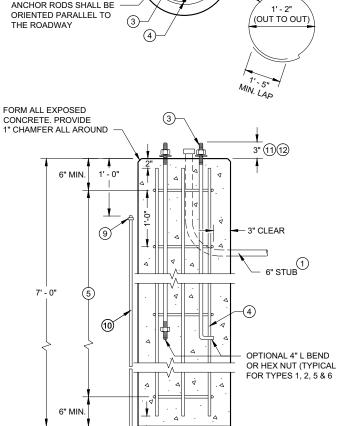


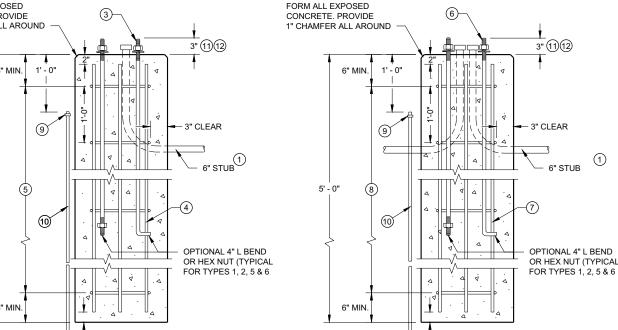

**CONCRETE BASES** 

TYPE 2

6

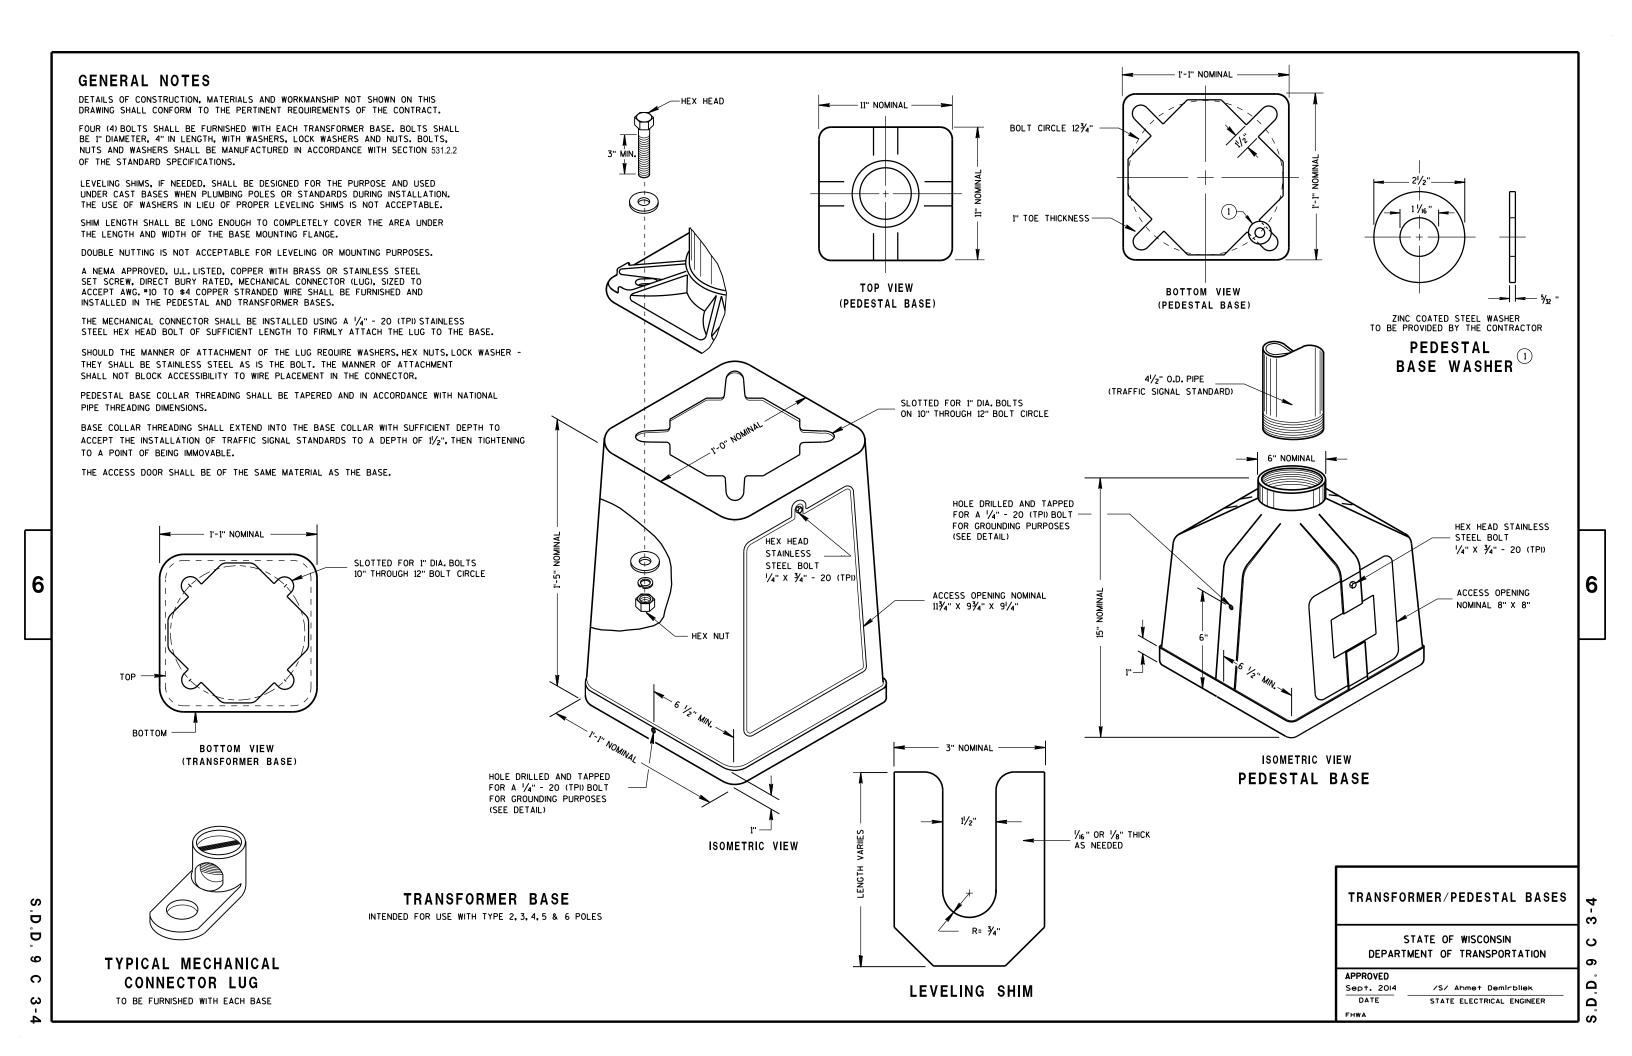


### **SECTION A-A** (10 DEGREES TILT REQUIREMENT OF

FACE(S) IN THE TROMBONE MOUNTING)


### FOR MANUFACTURERS USE ONLY

WELD TO BE 100% R.T. OR U.T. TESTED AS PER THE REQUIREMENTS OF AWS D 1.5-88. RECORDS OF COMPLIANCE OF SUCH TESTING SHALL BE FURNISHED TO THE OFFICE OF DESIGN / BRIDGE FOR VERIFICATION AND APPROVAL.

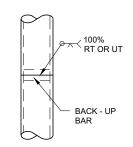


**POLE SPLICE DETAIL** 


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SIGNAL FACE MOUNTING DETAIL (BANDED)

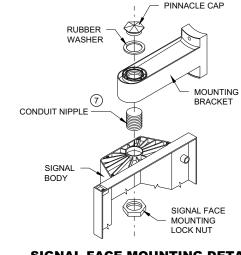

VARIABI F 25' - 0" LENGTH FOR DESIGN CALCULATION

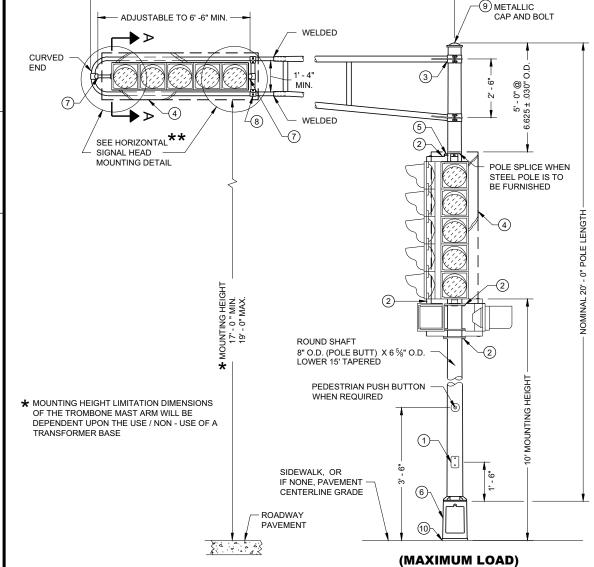

TYPICAL MOUNTING OF BACK TO BACK **3 AND 5 SECTION SIGNAL FACES** 

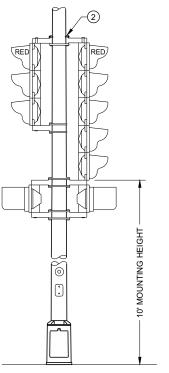**GENERAL NOTES** 

DETAILS OF CONSTRUCTION, MATERIALS AND WORKMANSHIP NOT SHOWN ON THIS DRAWING SHALL CONFORM TO THEPERTINENT REQUIREMENTS OF THE CONTRACT.

POLES SHALL BE EITHER ALUMINUM OR GALVANIZED STEEL AS CALLED FOR IN THE CONTRACT.


SECTION 657, POLES, OF THE STANDARD SPECIFICATIONS SHALL APPLY TO THIS DRAWING.

A PULL WIRE / ROPE SHALL BE INSTALLED IN EACH TROMBONE ARM RACEWAY DURING THE MANUFACTURING PROCESS.

TYPE 2 ALUMINUM POLES SHALL BE CONSTRUCTED OF 6063 - T6 ALUMINUM ALLOY. SLEEVING INSIDE THE POLE IS NOT ACCEPTABLE.

WHEN TRANSFORMER BASES ARE USED, WIRE CONNECTIONS SHALL BE MADE IN THE TRANSFORMER BASE

- 4" X 6" REINFORCED HANDHOLE AND COVER ASSEMBLY WITH TWO (2)  $\mbox{$\chi$}$ " 20 TPI , STAINLESS STEEL, HEX HEAD BOLTS.
- SIGNAL FACE MOUNTING BRACKETS. MOUNT WITH CAP SCREWS AND BANDING.
- ③ GROMMETS. 1" CHASE NIPPLES OR 1" CLOSE CONDUIT NIPPLES WITH BUSHINGS SHALL BE PROVIDED FOR 1 %" HOLE IN POLE SHAFT FOR WIRING.
- (4) SECURELY MOUNT DULL BLACK POLYCARBONATE BACKPLATES, PROJECTING 5" BEYOND ALL SIDES OF THE SIGNAL FACE HOUSING, PER MANUFACTURER'S RECOMMENDATIONS
- (5) POLE MOUNTED SIGNAL FACES SHALL REQUIRE ONE OR MORE MOUNTING SPACERS UNDER THE TOP MOUNTING BRACKET(S) ASREQUIRED, TO PLUMB THE SIGNAL FACES.
- (6) CAST ALUMINUM TRANSFORMER BASE, WHEN REQUIRED.
- (7) USE 1 ½" ID NIPPLES ZINC-COATED RIGID METAL CONDUIT, LONG ENOUGH TO ACCOMMODATE FULL DEPTH THREADING INTO THE HEAD MOUNTING LOCK NUT IN ORDER TO TIGHTEN THE FACE, BUT THAT DO NOTINTERFERE WITH REFLECTOR CLOSURE. THREAD THE NIPPLE INTO THE MOUNTING BRACKET/ELBOW UNTIL TIGHT. USE APPROVED PINNACLE TYPE HARDWARE FROM A DEPARTMENT APPROVED MANUFACTURER TO CLOSE THE UNUSED 1 ½" OPENING IN SIGNAL FACES AND BRACKET ENDS
- (%) VERTICAL STRUT (ADJUSTABLE). ONE (1) SET SCREW (¾" X ¾" 20 TPI STAINLESS STEEL, HEX HEAD) INTO EACH ARM MEMBER IF STRUTIS THE SLIDING TYPE.
- 9 FURNISH AND INSTALL VENTILATED, CAST METALLIC (ALUMINUM ALLOY) CAPS. FASTEN CAPS WITH ONE (1)  $\frac{1}{4}$ " X  $\frac{3}{4}$ " - 20 TPI STAINLESS STEEL, HEX HEAD BOLT.
- (1) SHIMMING, IF NEEDED, SHALL BE LOCATED BETWEEN THE CONCRETE FOUNDATION AND THE TRANSFORMER BASE.
- (11) USE SERRATED LOCK WASHERS WITH NOTCHES BETWEEN END TEE AND SIGNAL HEAD.

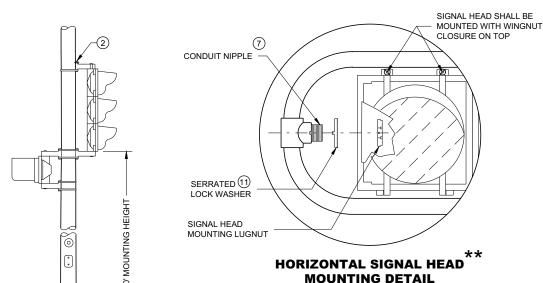

**MOUNTING DETAIL** \*\* SIGNAL HEAD ATTACHMENT ALSO APPLIES TO MOUNTING AT CROSS BAR


**TYPICAL MOUNTING OF 3 SECTION** SIGNAL FACE


**POLE MOUNTINGS FOR TRAFFIC SIGNALS** TYPE 2


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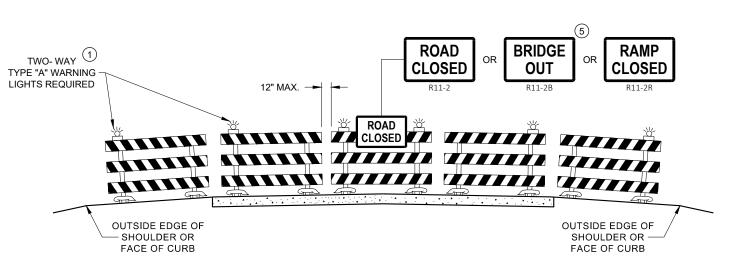
STATE OF WISCONSIN DEPARTMENT OF TRANSPORTATION

**TYPE 2 POLE MOUNTING CONFIGURATION** 




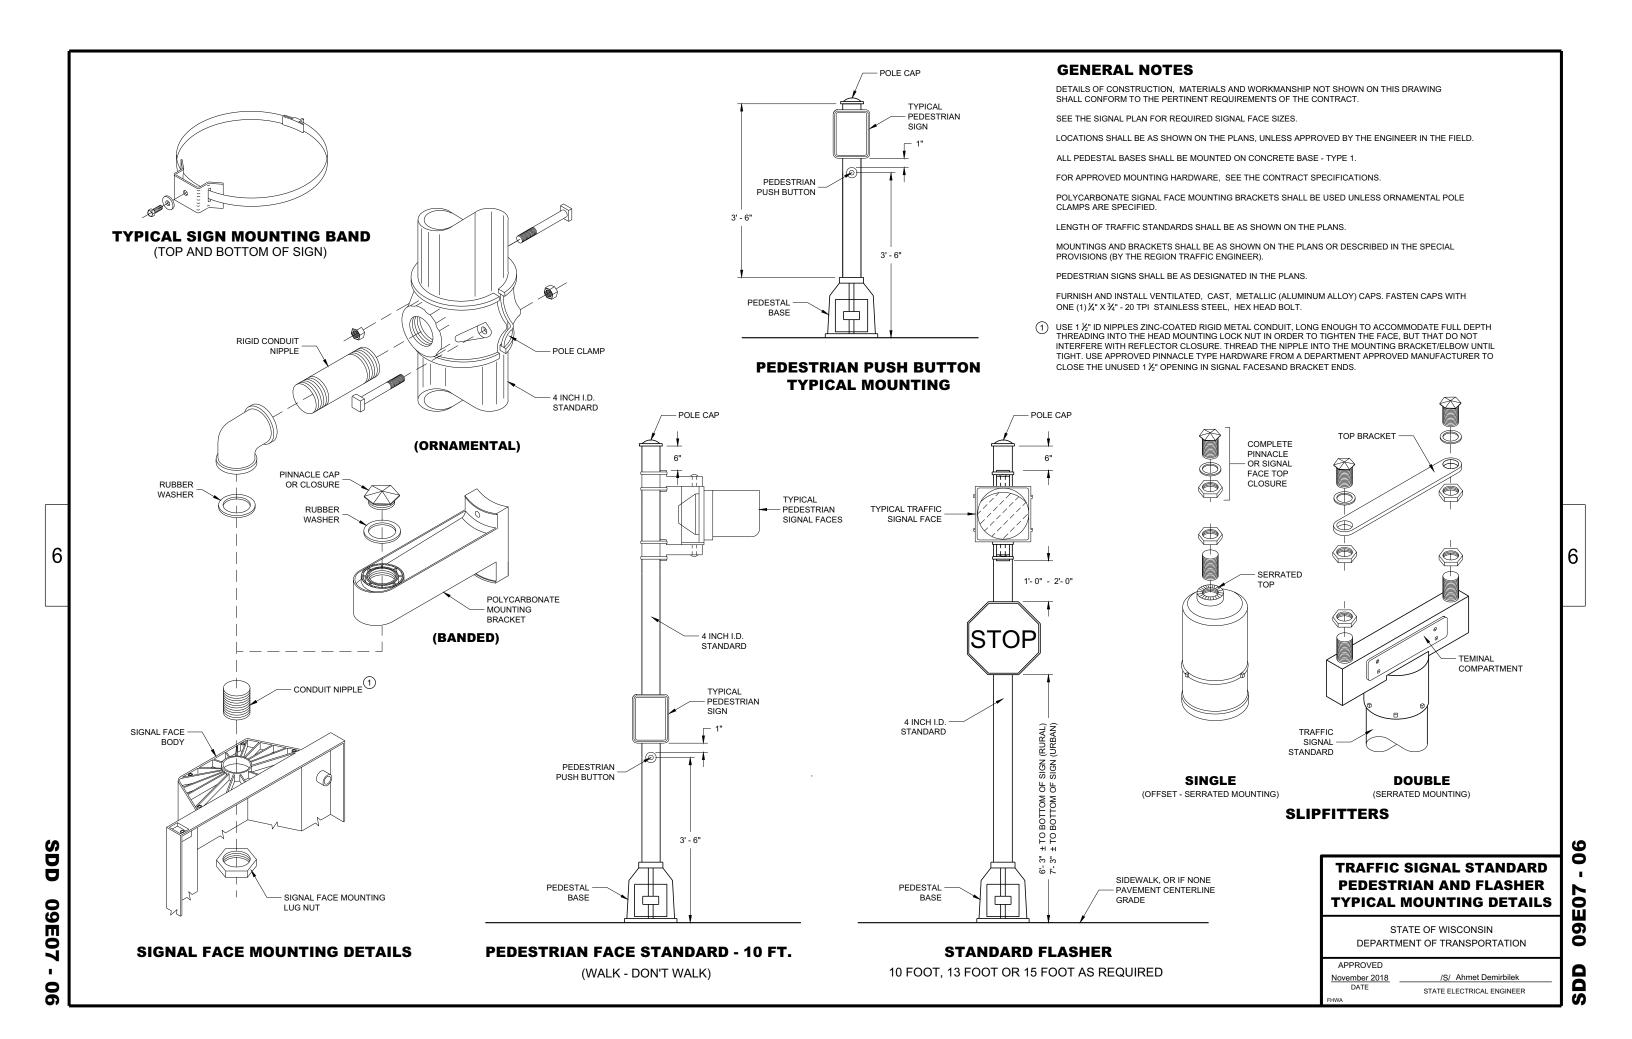

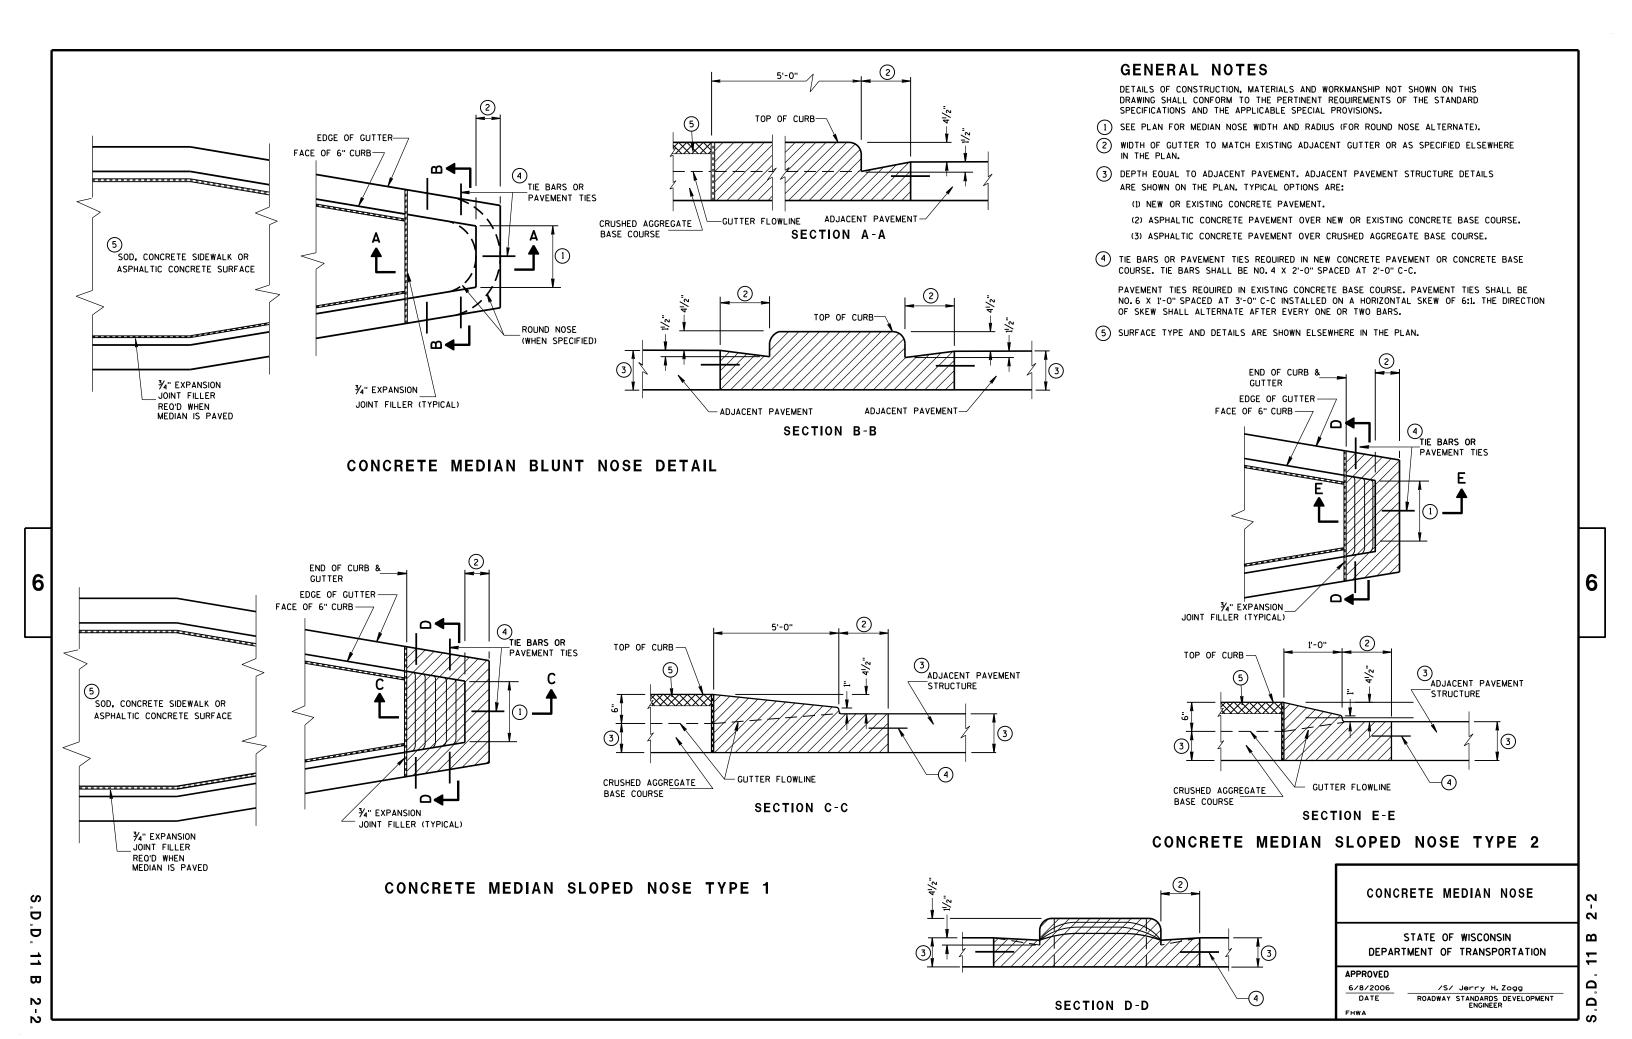

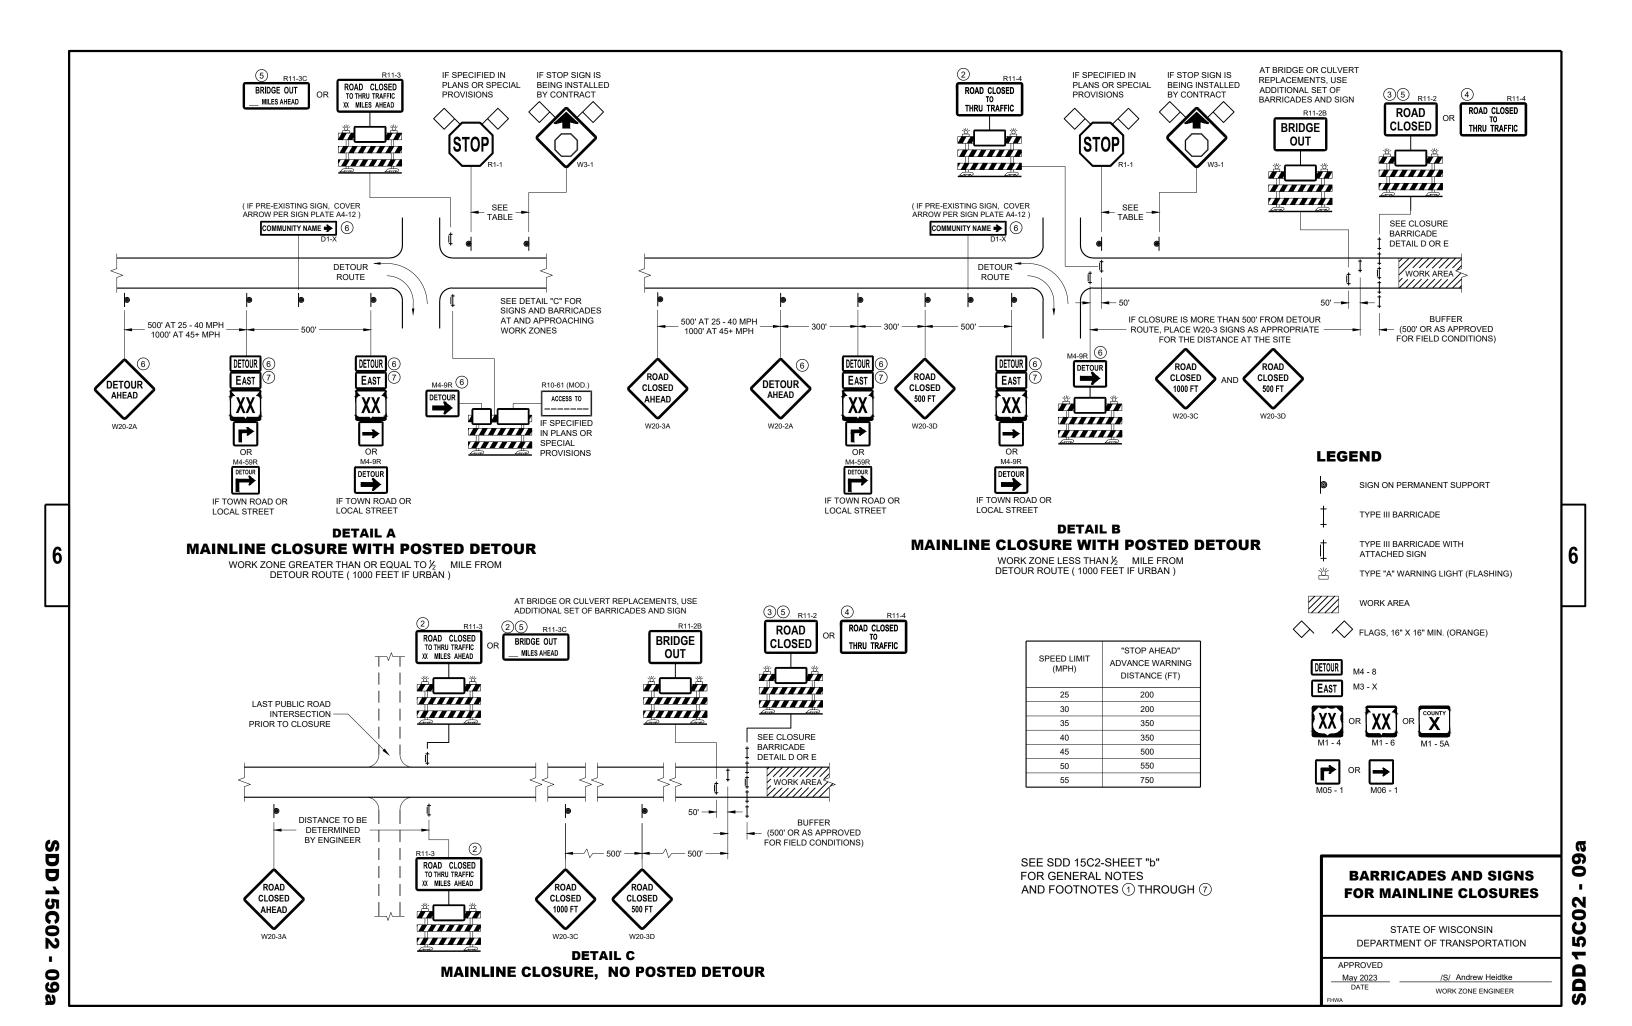

### **DETAIL D ROAD CLOSURE BARRICADE DETAIL APPROACH VIEW**

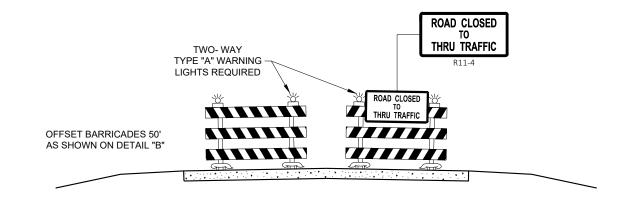

### **DETAIL E** LANE CLOSURE BARRICADE DETAIL **APPROACH VIEW**

SEE SDD 15C2 - SHEET "a" FOR LEGEND

### **GENERAL NOTES**

THE EXACT NUMBER, LOCATION, AND SPACING OF ALL SIGNS AND BARRICADES SHALL BE ADJUSTED TO FIT FIELD CONDITIONS AS APPROVED BY THE ENGINEER.

ANY SIGNS TEMPORARY OR EXISTING, WHICH CONFLICT WITH TRAFFIC CONTROL "IN USE", SHALL BE REMOVED OR COVERED AS NEEDED AND AS APPROVED BY THE ENGINEER.

THE SPACING BETWEEN TRAFFIC CONTROL SIGNS SHOULD BE ADJUSTED TO NOT CONFLICT WITH AND SHOULD PROVIDE A DESIRABLE MINIMUM OF 200 FEET CLEARANCE TO EXISTING SIGNS THAT WILL REMAIN IN PLACE.

BARRICADES THAT MUST BE MOVED FOR A WORK OPERATION SHALL BE IMMEDIATELY RE-ESTABLISHED UPON COMPLETION OF THE OPERATION, OR FOR CONTINUING OPERATIONS, AT THE END OF EACH WORKING DAY.

SIGNS THAT WILL BE IN PLACE LESS THAN 7 CONTINUOUS DAYS AND NIGHTS MAY BE MOUNTED ON PORTABLE

ALL TYPE III BARRICADES SHALL HAVE RAILS REFLECTORIZED ON BOTH FACES. STRIPES SHALL BE PROPERLY SLOPED DOWN TOWARD THE TRAFFIC SIDE OR AS SHOWN IN THE ROAD CLOSURE BARRICADE DETAIL "D" FOR FULL ROAD CLOSURES.

TYPE "A" LOW - INTENSITY FLASHING WARNING LIGHTS SHALL BE VISIBLE ON BOTH SIDES OF THE BARRICADE.

THE R11 - 2. R11 - 3. M4 - 9. R11 - 4. AND R10 - 61 SIGNS PLACED ON THE BARRICADES SHALL COVER NO MORE THAN THE TOP RAIL. THE SIGNS SHALL NOT COVER ANY PORTION OF THE MIDDLE RAIL OR BOTTOM RAILS.

"WO" AND "MO" SIGNS ARE THE SAME AS "W" AND "M" SIGNS EXCEPT THE BACKGROUND IS ORANGE.

ALL SIGNS SHALL BE 48" X 48" UNLESS OTHERWISE NOTED BELOW:

R11 - 2 SHALL BE 48" X 30"

R11 - 3 SHALL, R11 - 4 AND R10 - 61 SHALL BE 60 " X 30"

M4 - 9 SHALL BE 30" X 24"

M3 - X SHALL BE 24" X 12" (36" X 18" IF NEEDED TO MATCH EXISTING SIGNS)

M4 - 8 SHALL BE 24" X 12" (36" X 18" IF NEEDED TO MATCH EXISTING SIGNS)

M1 - 4, M1 - 5A AND M1 - 6 SHALL BE 24" X 24" (36" X 36" IF NEEDED TO MATCH EXISTING SIGNS)

MO5 - 1 AND MO6 - 1 SHALL BE 21" X 21" (30" X 30" IF NEEDED TO MATCH EXISTING SIGNS) D1 - X SHALL BE AS SHOWN ON SPECIFIC PROJECT SIGNING DETAIL SHEETS.

R1 - 1 SHALL BE 36" X 36"


- TWO WARNING LIGHTS SHALL BE PROVIDED ON THE CENTER BARRICADE AND A MINIMUM OF ONE WARNING LIGHT SHALL BE PROVIDED ON EACH OF THE OTHER BARRICADES WITHIN THE ROADWAY LIMITS. SPACING OF THE WARNING LIGHTS SHALL BE UNIFORM TO THE EDGE OF ROADWAY AS SHOWN (APPROX. 8 FOOT LIGHT **SPACING**
- THESE SIGNS AND BARRICADES ARE NOT REQUIRED IF ROAD CLOSURE BEGINS AT AN INTERSECTION.
- (3) FOR ROAD CLOSURE <u>WITHOUT</u> LOCAL ACCESS TO PROJECT, SEE ROAD CLOSURE BARRICADE DETAIL "D".
- (4) FOR ROAD CLOSURE WITH LOCAL ACCESS TO PROJECT, SEE ROAD CLOSURE BARRICADE DETAIL "E".
- (5) FOR BRIDGE OR CULVERT REPLACEMENTS, SUBSTITUTE "BRIDGE OUT" INSTEAD OF "ROAD CLOSED" ON R11 - 2 AND R11 - 3 SIGNS.
- (6) INSTALL DETOUR AND COMMUNITY GUIDE SIGNS AND ARROWS ONLY IF SPECIFIED IN THE CONTRACT. IF THERE ARE EXISTING ROUTE MARKER ASSEMBLIES THAT WILL REMAIN IN PLACE, ADJUST THE LOCATION OF THE DETOUR ROUTE SIGNS TO CORRESPOND WITH THE EXISTING ASSEMBLIES. MODIFY EXISTING SIGNS WHERE POSSIBLE. SEE SPECIFIC PROJECT DETOUR SIGNING DETAIL SHEETS. IF DETOUR SIGNS ARE BEING INSTALLED BY OTHERS. PLACE THE CONTRACTED TRAFFIC CONTROL SIGNS TO ALLOW FOR PLACEMENT OF ALL WARNING, DETOUR AND GUIDE
- "EAST" CARDINAL DIRECTION MARKERS AND RIGHT TURN ARROWS ARE SHOWN. USE OTHER CARDINAL DIRECTIONS AND ARROWS AS APPROPRIATE.

### **BARRICADES AND SIGNS** FOR **VARIOUS CLOSURES**

STATE OF WISCONSIN DEPARTMENT OF TRANSPORTATION

**APPROVED** May 2023 DATE WORK ZONE ENGINEER

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### **GENERAL NOTES**

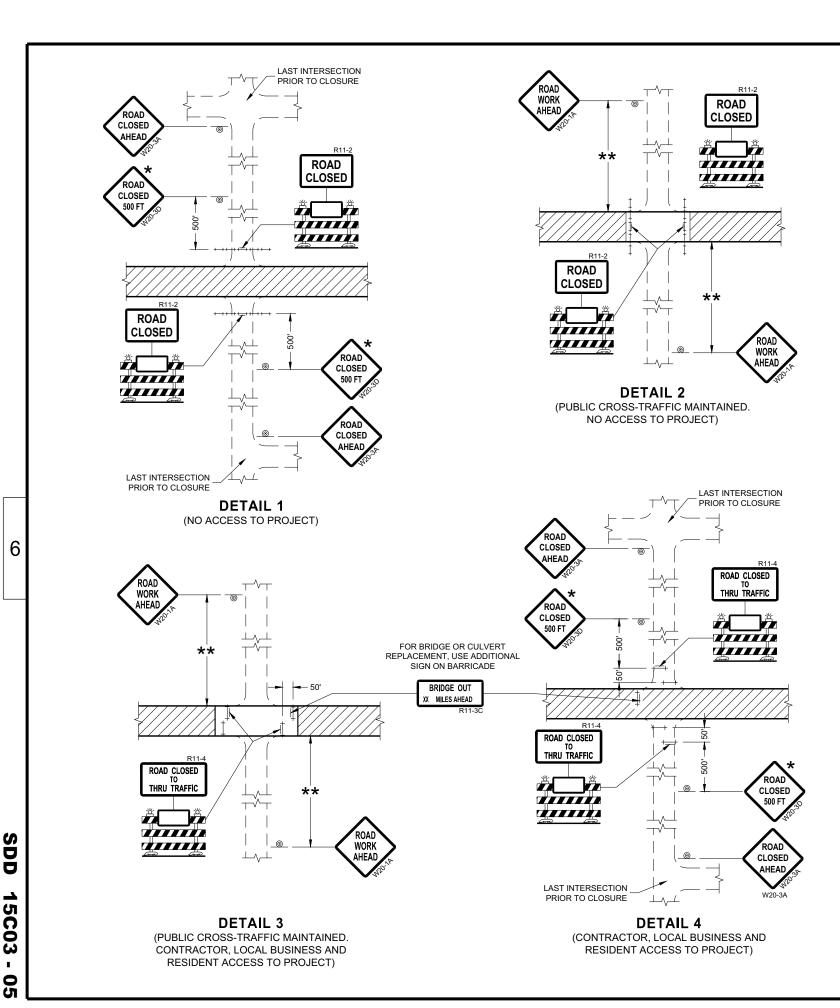THE EXACT NUMBER, LOCATION, AND SPACING OF ALL SIGNS AND BARRICADES SHALL BE ADJUSTED TO FIT FIELD CONDITIONS

ANY SIGNS TEMPORARY OR EXISTING, WHICH CONFLICT WITH TRAFFIC CONTROL "IN USE" SHALL BE REMOVED OR COVERED AS NEEDED AND AS APPROVED BY THE ENGINEER.

THE SPACING BETWEEN TRAFFIC CONTROL SIGNS SHOULD BE ADJUSTED TO NOT CONFLICT WITH AND SHOULD PROVIDE A DESIRABLE MINIMUM OF 200 FEET CLEARANCE (500 FEET DESIRABLE) TO EXISTING SIGNS THAT WILL REMAIN IN PLACE.

IF A "STOP" SIGN MUST BE REMOVED FOR A WORK OPERATION, A TEMPORARY "STOP" SIGN SHALL BE PLACED PRIOR TO THE SIGN REMOVAL, OR A FLAGGER SHALL BE PROVIDED UNTIL THE SIGN IS REESTABLISHED.

BARRICADES THAT MUST BE MOVED FOR A WORK OPERATION SHALL BE IMMEDIATELY REESTABLISHED UPON COMPLETION OF THE OPERATION OR FOR CONTINUING OPERATIONS, AT THE END OF EACH WORKING DAY.

SIGNS THAT WILL BE IN PLACE LESS THAN SEVEN CONTINUOUS DAYS AND NIGHTS MAY BE MOUNTED ON PORTABLE SUPPORTS.

ALL TYPE III BARRICADES SHALL HAVE RAILS REFLECTORIZED ON BOTH FACES. STRIPES SHALL BE PROPERLY SLOPED DOWN TOWARD THE TRAFFIC SIDE OR AS SHOWN IN THE ROAD CLOSURE BARRICADE DETAIL "D" FOR FULL ROAD CLOSURES.

TYPE "A" LOW-INTENSITY FLASHING WARNING LIGHTS SHALL BE VISIBLE ON BOTH SIDES OF THE BARRICADE.

THE R11-2, R11-3, AND R11-4 SIGNS PLACED ON BARRICADES SHALL COVER NO MORE THAN THE TOP RAIL. THE SIGNS SHALL NOT COVER ANY PORTION OF THE MIDDLE OR BOTTOM RAILS.

ALL SIGNS SHALL BE 48" X 48" UNLESS OTHERWISE NOTED BELOW: R11-2 SHALL BE 48" X 30". R11-4 AND R11-3 SHALL BE 60" X 30".

- ★ OMIT THE "ROAD CLOSED 500 FT." SIGN IF THE LAST INTERSECTION IS 500 FEET OR LESS FROM THE WORK ZONE.
- \*\* 500' MAX. OR AT LAST INTERSECTION, WHICHEVER IS CLOSEST.

### LEGEND

SIGN ON PERMANENT SUPPORT

TYPE III BARRICADE

TYPE III BARRICADE WITH ATTACHED SIGN

TYPE "A" WARNING LIGHT (FLASHING)

WORK AREA

### **BARRICADES AND SIGNS** FOR **SIDEROAD CLOSURES**

STATE OF WISCONSIN DEPARTMENT OF TRANSPORTATION


APPROVED July 2018 DATE /S/ Andrew Heidtke WORK ZONE ENGINEER ŭ

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### **SDD 15C11**


### **GENERAL NOTES**

- (1) REFLECTIVE SHEETING SHALL FOLLOW THE REQUIREMENTS IN THE APPROVED PRODUCTS LISTING FOR SIGN SHEETING.
- (2) LOCATION OF WARNING LIGHTS WHEN SHOWN ON THE PLAN.

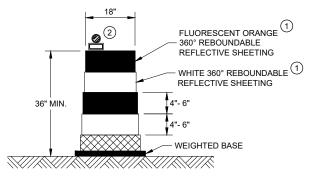


DRUM

BALLAST WIDTHS RANGE FROM 24"-36"

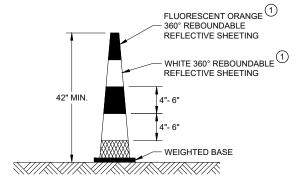


### **42" CONE**

DO NOT USE IN TAPERS ½ SPACING OF DRUMS BALLAST WIDTHS RANGE FROM 14"-20"

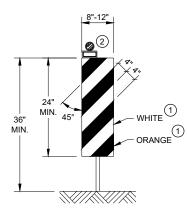


### **VERTICAL PANEL**

THE STRIPES SHALL SLOPE DOWNWARD TO THE TRAFFIC SIDE FOR CHANNELIZATION.

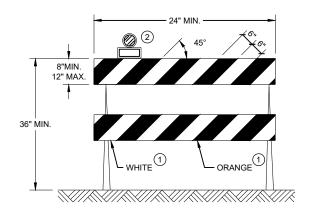

### **TYPE II BARRICADE**

FOR RAILS LESS THAN 36" LONG, 4" WIDE STRIPES MAY BE USED. ALL STRIPES SHALL SLOPE DOWNWARD TO THE TRAFFIC SIDE FOR CHANNELIZATION.

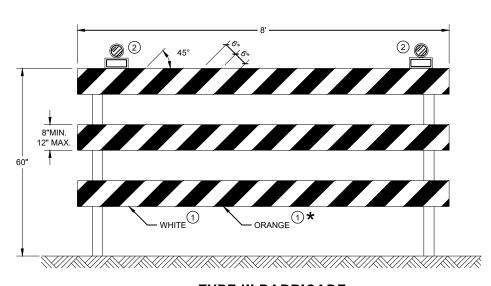

### **TYPE III BARRICADE**


IF SIGN MOUNTED, DO NOT COVER MORE THAN 50% OF THE TOP TWO RAILS OR 33% OF THE TOTAL AREA OF THE THREE RAILS.

\* IF USED FOR A PERMANENT APPLICATION USE RED SHEETING.


### **CHANNELIZING DEVICES DRUMS, CONES, BARRICADES AND VERTICAL PANELS**

STATE OF WISCONSIN DEPARTMENT OF TRANSPORTATION 15C

APPROVED	
November 2022	/S/ Andrew Heidtke
DATE	WORK ZONE ENGINEER

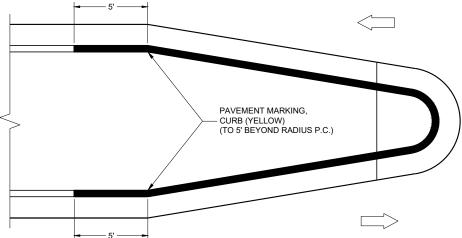

MEDIAN ISLAND WITH ROUND BLUNT NOSE

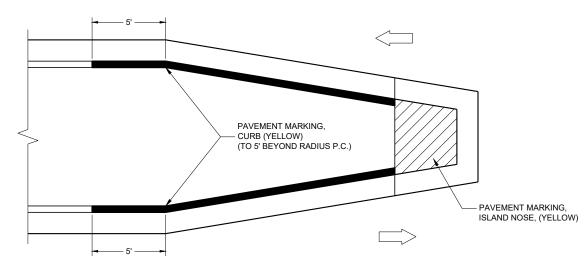


**MEDIAN ISLAND WITH SLOPED NOSE** 

TYPICAL PLACEMENT OF PAVEMENT MARKING ON MEDIAN ISLANDS

### **GENERAL NOTES**

WHEN CONCRETE CORRUGATED MEDIAN IS CONSTRUCTED TO SEPARATE TRAFFIC OPERATING IN THE OPPOSING DIRECTION, YELLOW PAVEMENT MARKING SHALL BE APPLIED TO THE FLAT PORTION OF THE CONCRETE CORRUGATED MEDIAN. THE ITEM OF PAVEMENT MARKING, CONCRETE CORRUGATED MEDIAN, WILL BE MEASURED IN PLACE AND ACCEPTED IN ACCORDANCE WITH THE CONTRACT AND PAID FOR AT THE CONTRACT UNIT PRICE PER SQUARE FOOT.

(1) APPLY PAVEMENT MARKING TO THE FLAT PORTION OF CORRUGATED MEDIAN.

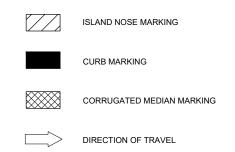

PAVEMENT MARKINGS, MEDIAN ISLAND NOSE


STATE OF WISCONSIN
DEPARTMENT OF TRANSPORTATION

APPROVED
May 2023
DATE

/S/ Jeannie Silver
ROADWAY STANDARDS DEVELOPMENT
UNIT SUPERVISOR

SDD 15C18-08b

SDD 15C18-08

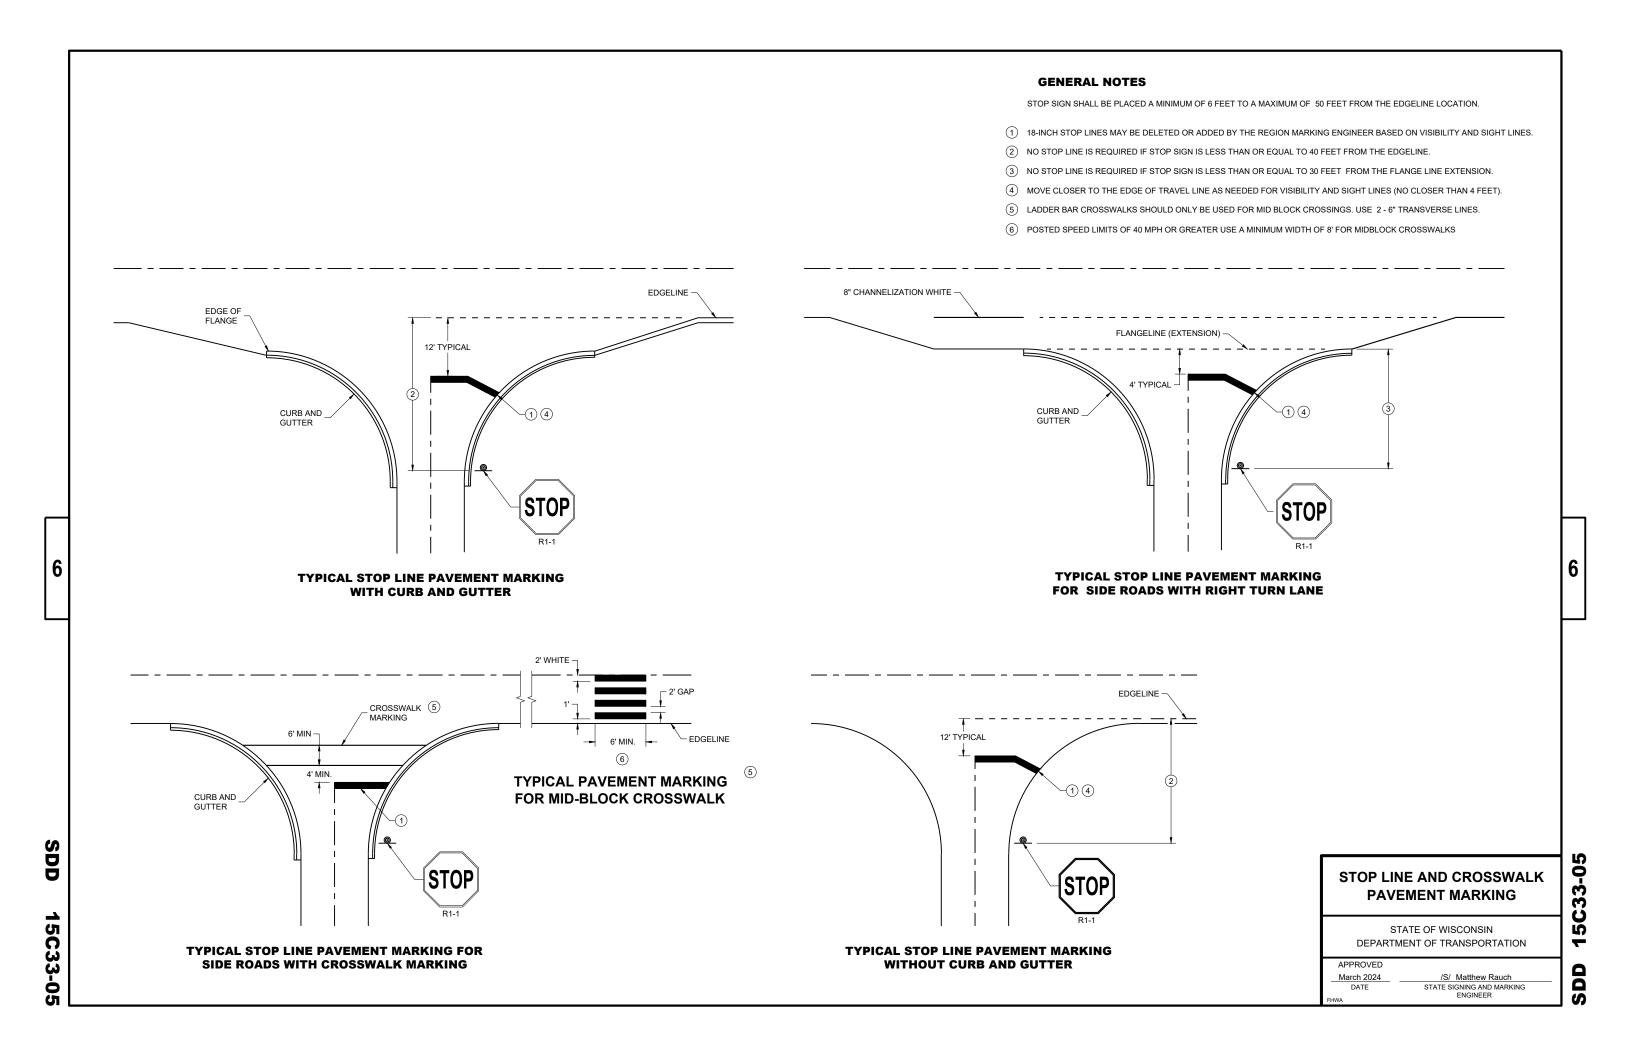

### **GENERAL NOTES**

FOR WORK ON ROADWAYS WITH SPEEDS GREATER THAN 45MPH, USE SDD 15D12.

THIS LANE CLOSURE DETAIL IS TYPICAL FOR CLOSING THE LEFT LANE. FOR A RIGHT LANE CLOSURE, REVERSE THE TRAFFIC CONTROL.

THIS DETAIL MAY BE USED FOR ROADWAYS WITH EITHER TWO OR THREE LANES IN EACH DIRECTION.

ALL SIGNS ARE 48"X48" UNLESS OTHERWISE NOTED. IF NECESSARY DUE TO SPACE CONSTRAINTS IN URBAN AREAS, 36"X 36" SIGNS MAY BE USED IF APPROVED BY REGIONAL TRAFFIC UNIT.

"WO" SIGN IS THE SAME AS "W" SIGN EXCEPT THE BACKGROUND IS ORANGE.

ANY SIGNS TEMPORARY OR EXISTING, WHICH CONFLICT WITH THE TRAFFIC CONTROL "IN USE" SHALL BE REMOVED OR COVERED AS NEEDED AND AS APPROVED BY THE ENGINEER. NO WARNING LIGHTS SHALL BE WORKING ON COVERED OR "DOWNED" SIGNS.

SIGNS THAT WILL BE IN PLACE LESS THAN 7 CONTINUOUS DAYS AND NIGHTS OR THAT WILL BE PLACED IN A CLOSED LANE MAY BE MOUNTED ON TEMPORARY SUPPORTS.

THE EXACT NUMBER, LOCATION, AND SPACING OF ALL SIGNS AND DEVICES SHALL BE ADJUSTED TO FIT FIELD CONDITIONS AS APPROVED BY THE ENGINEER.

THE SPACING BETWEEN TRAFFIC CONTROL SIGNS SHOULD BE ADJUSTED TO NOT CONFLICT WITH AND TO PROVIDE A MINIMUM OF 200 FEET (500' DESIRABLE) DISTANCE TO EXISTING SIGNS THAT WILL REMAIN IN PLACE

W20-1A, G20-1 AND G20-2A SIGNS ARE NOT REQUIRED IF THE LANE CLOSURE IS WITHIN A LARGER WORK ZONE WHERE THESE SIGNS ARE ALREADY PRESENT

REMOVE PAVEMENT MARKINGS AND PLACE TEMPORARY PAVEMENT MARKING LINE IF LANE CLOSURE IS TO BE IN

PLACE FOR 4 OR MORE CONTINUOUS DAYS AND NIGHTS.


CONSIDER GEOMETRICS WHEN LOCATING SIGNS AND ARROW BOARDS SO THE APPROACHING DRIVER HAS A CLEAR VIEW OF THE ARROW BOARDS AND LANE CLOSURE DRUMS FOR A MINIMUM 1500 FEET IN FRONT OF DRUMS.

BARRICADES IN A CLOSED LANE THAT MUST BE MOVED FOR A WORK OPERATION SHALL BE IMMEDIATELY REESTABLISHED UPON COMPLETION OF THE OPERATION, OR FOR CONTINUING OPERATIONS, AT THE END OF EACH WORKING DAY.

CHANNELIZING DEVICES PLACED ADJACENT TO WORK AREA SHALL BE PULLED BACK FROM THE TRAVEL LANE WHEN WORK IS NOT IN PROGRESS.

WARNING LIGHTS ARE NOT REQUIRED IF THE LANE CLOSURE IS A DAYTIME ONLY OPERATION

- (1) OMIT G20-1 SIGNS IF LENGTH OF WORK AREA IS 2 MILES OR LESS.
- (2) WHERE THE SHOULDER OR TERRACE HAS INSUFFICIENT SPACE TO PLACE THE ARROW BOARD AS SHOWN, PLACE THE ARROW BOARD AT THE END OF THE TAPER.

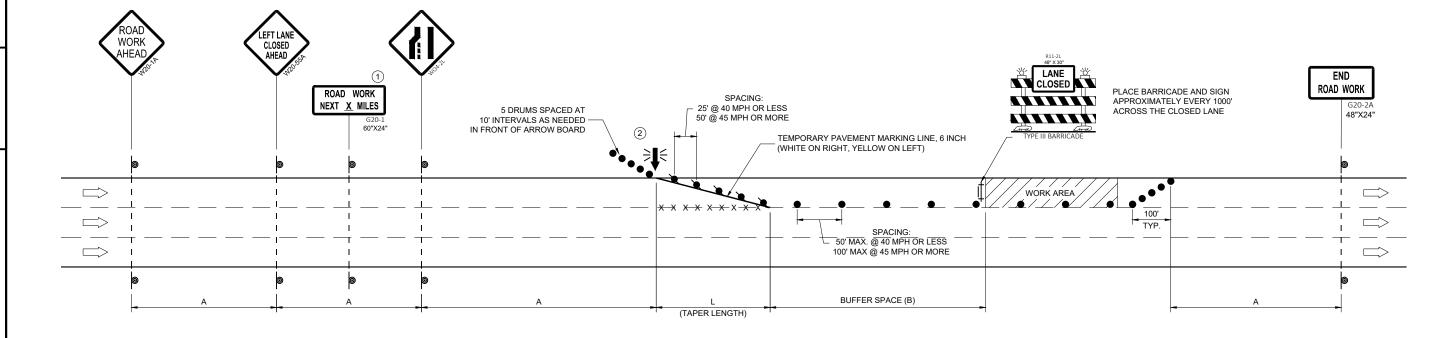

POSTED SPEED LIMIT PRIOR TO WORK STARTING (MPH)	ADVANCE WARNING SIGN SPACING (A) FEET	TAPER LENGTH (12 FT. LANE) (L) FEET	BUFFER SPACE (B) FEET		
25	200'	125'	55'		
30	200'	180'	85'		
35	350'	245'	120'		
40	350'	320'	170'		
45	500'	540'	220'		

### TRAFFIC CONTROL, SINGLE LANE CLOSURE, DIVIDED NON-FREEWAY/EXPRESSWAY

STATE OF WISCONSIN
DEPARTMENT OF TRANSPORTATION

APPROVED


March 2024 /S/ Andrew Heidtke

DATE WORK ZONE ENGINEER

\_\_\_\_\_

DD 15D20-08

S

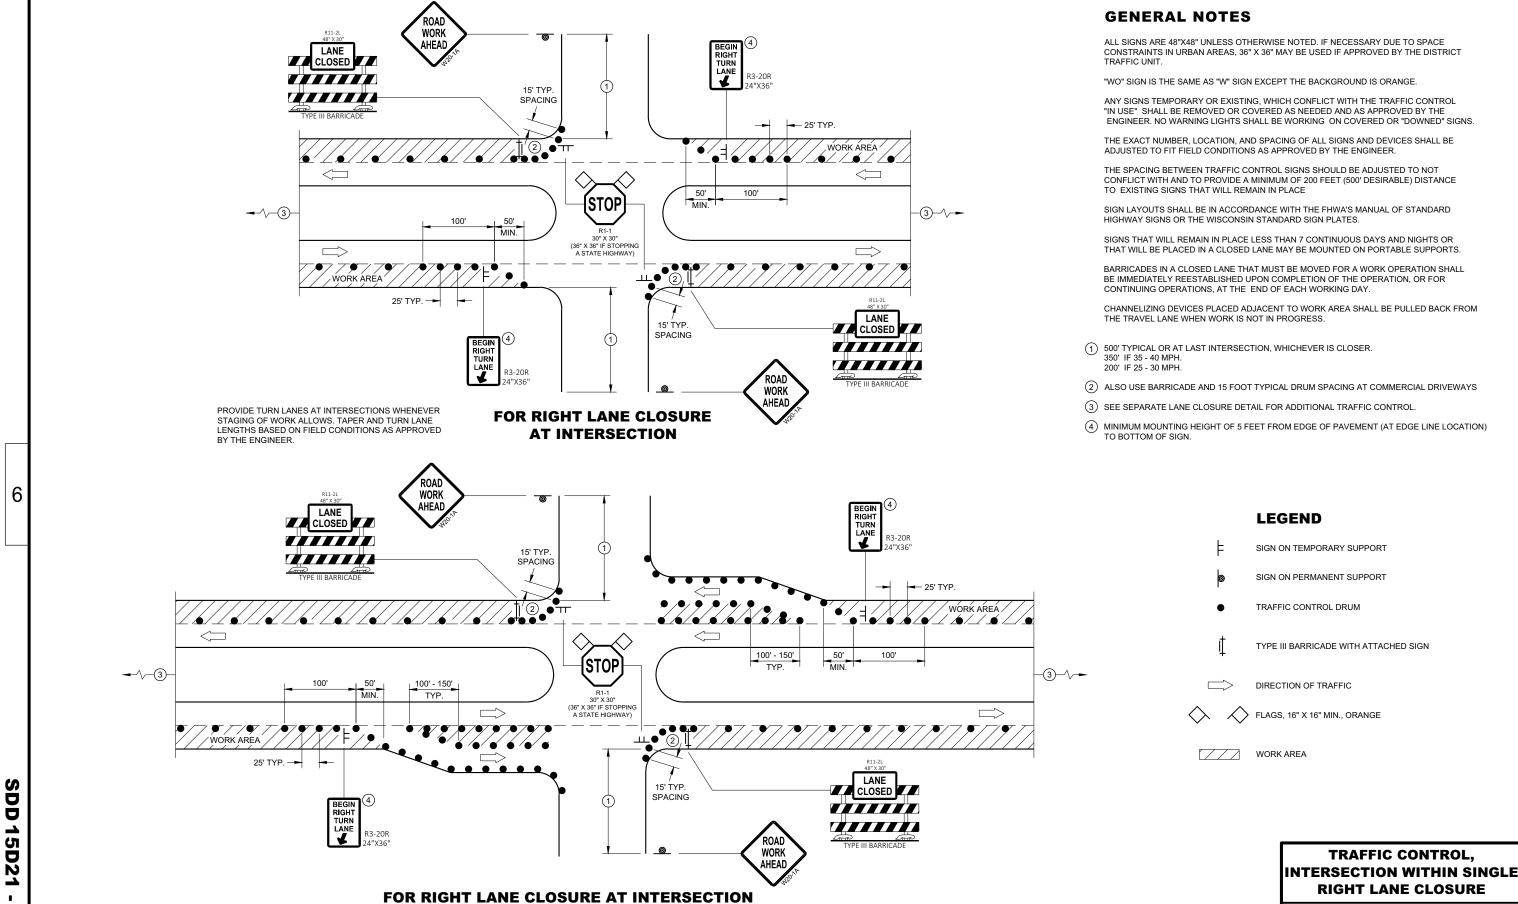

(WITH RIGHT TURN BAY OPEN)


0

07

**5D** 


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STATE OF WISCONSIN DEPARTMENT OF TRANSPORTATION

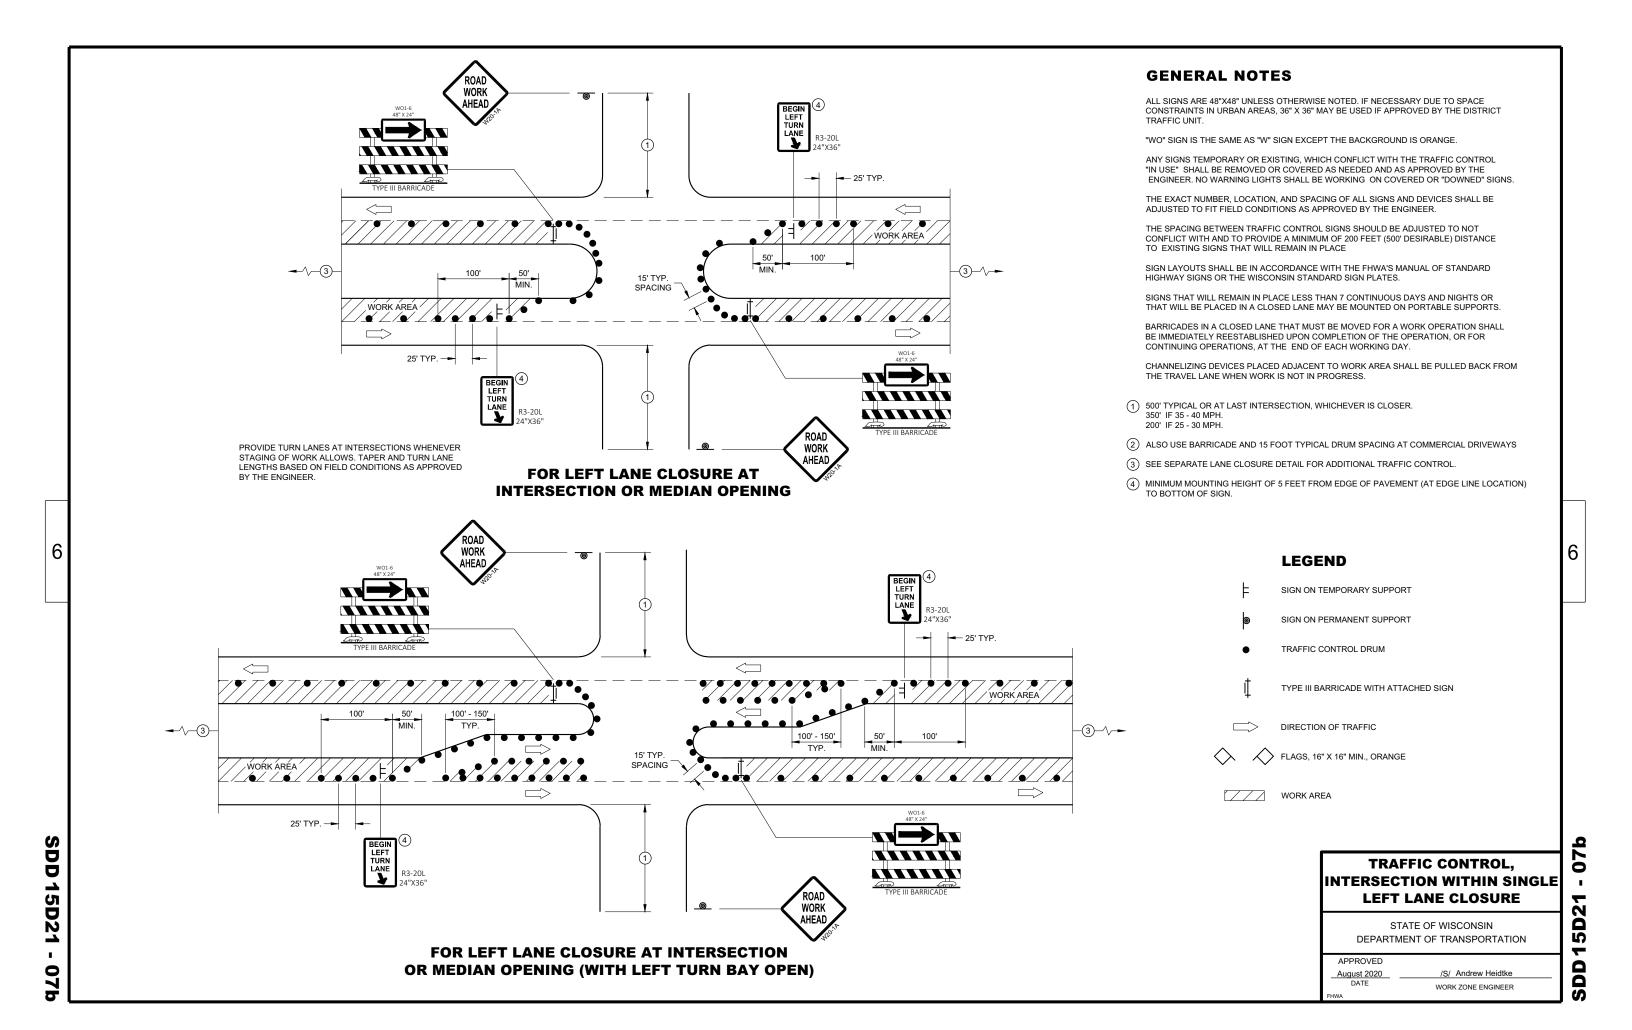


BARRICADE DEVICE SELECTED FROM APPROVED PRODUCT LIST

- (1) REFLECTIVE SHEETING SHALL FOLLOW THE REQUIREMENTS IN THE APPROVED PRODUCTS LISTING FOR SIGN SHEETING.
- ② SHEETING REQUIRED ON MORE THAN 50% OF BARRICADE WIDTH.
- 3) PLACE SHEETING ON BOTH SIDES OF THE BARRICADE.
- \* USE THIS DETAIL FOR SHEETING PLACEMENT REFERENCE.

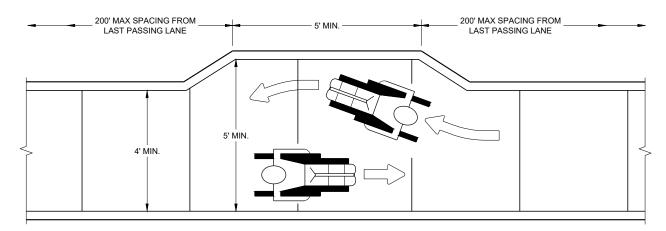

### **NARROW SIDEWALK PASSING DETAIL**

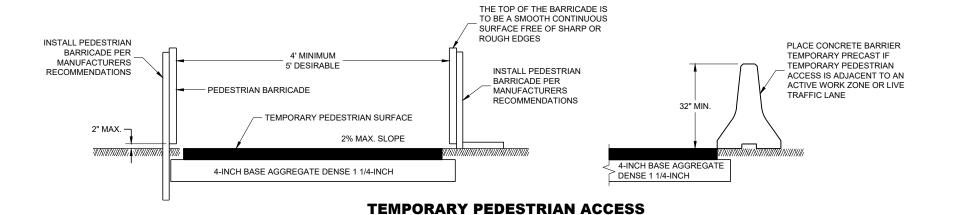

12" MAX. 3' MIN. 4' MAX. VARIES — VARIES -

TEMPORARY PEDESTRIAN BARRICADE\*

TRAFFIC CONTROL, **PEDESTRIAN ACCOMMODATION** 

6

60

15D30

SDD

STATE OF WISCONSIN DEPARTMENT OF TRANSPORTATION


6

CURB RAMPS AND LANDINGS SHALL HAVE A 1:50 (2%) MAX. CROSS-SLOPE.


CLEAR SPACE OF 48" X 48" SHALL BE PROVIDED ABOVE AND BELOW THE CURB RAMP. LATERAL JOINTS OR GAPS BETWEEN SURFACES SHALL BE LESS THAN  $\frac{1}{2}$ " WIDTH.

CHANGES BETWEEN SURFACE HEIGHTS SHALL NOT EXCEED  $\frac{1}{2}$ ". LATERAL EDGES MAY BE VERTICAL UP TO  $\frac{1}{4}$ " HIGH AND SHALL BE BEVELED AT 1:2 BETWEEN  $\frac{1}{4}$ " AND  $\frac{1}{2}$ ".

- (1) INSTALL CONTRASTING TEMPORARY DETECTABLE WARNING FIELD AT PEDESTRIAN STREET CROSSINGS, AS SHOWN IN THE DI ANS
- (2) PROTECTIVE EDGING WITH A 2" MIN. HEIGHT SHALL BE INSTALLED WHEN A CURB RAMP OR LANDING PLATFORM HAS A VERTICAL DROP OF 6" OR GREATER OR HAS A SIDE APRON SLOPE STEEPER THAN 1:3 (33%). PROTECTIVE EDGING SHOULD BE CONSIDERED WHEN CURB RAMPS OR LANDING PLATFORMS HAVE A VERTICAL DROP OF 3" OR MORE.
- (3) DETECTABLE EDGING WITH 6" MIN. HEIGHT AND CONTRASTING COLOR SHALL BE INSTALLED ON ALL CURB RAMP LANDINGS WHERE THE WALKWAY CHANGES DIRECTION (TURNS).
- (4) DO NOT RESTRICT WATER FLOW IN THE GUTTER SYSTEM.
- 5 ENSURE CURB RAMP IS OUT OF THE GUTTER PAN.
- (6) IF ONLY PART OF THE END PANEL OF TEMPORARY PEDESTRIAN BARRICADE PANEL IS NEEDED, EXTEND EXCESS PORTION OF TEMPORARY PEDESTRIAN BARRICADE PANEL HERE.

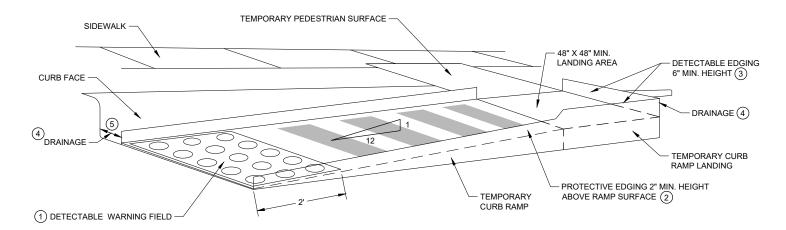

**PERSPECTIVE VIEW** 

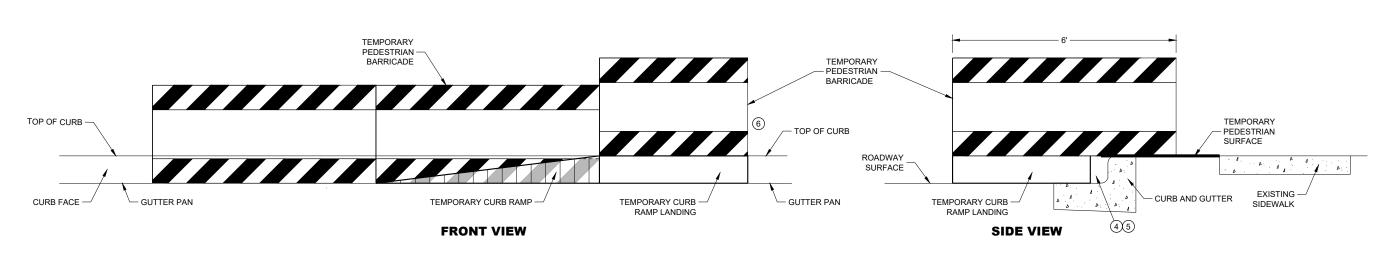

TEMPORARY CURB RAMP PARALLEL TO CURB

TRAFFIC CONTROL,
PEDESTRIAN
ACCOMMODATION

STATE OF WISCONSIN DEPARTMENT OF TRANSPORTATION

6

**SDD 15D30** 

SDD 15D30 - 09

**GENERAL NOTES** 

CURB RAMPS SHALL BE 48" MINIMUM WIDTH WITH A FIRM, STABLE AND SLIP RESISTANT SURFACE.

CURB RAMPS AND LANDINGS SHALL HAVE A 1:50 (2%) MAX. CROSS-SLOPE.

AND SHALL BE BEVELED AT 1:2 BETWEEN 1/4" AND 1/2".

LANDINGS WHERE THE WALKWAY CHANGES DIRECTION (TURNS).

CLEAR SPACE OF 48" X 48" SHALL BE PROVIDED ABOVE AND BELOW THE CURB RAMP. LATERAL JOINTS OR GAPS BETWEEN SURFACES SHALL BE LESS THAN  $\frac{1}{2}$ " WIDTH.

ALTERNATE SIDEWALK WORK BETWEEN LEFT AND RIGHT SIDE OF ROADWAY TO MAINTAIN PEDESTRIAN ACCESS.

CHANGES BETWEEN SURFACE HEIGHTS SHALL NOT EXCEED  $\frac{1}{2}$ ". LATERAL EDGES MAY BE VERTICAL UP TO  $\frac{1}{4}$ " HIGH

(1) INSTALL CONTRASTING TEMPORARY DETECTABLE WARNING FIELD AT PEDESTRIAN STREET CROSSINGS, AS SHOWN IN

PROTECTIVE EDGING WITH A 2" MIN. HEIGHT SHALL BE INSTALLED WHEN A CURB RAMP OR LANDING PLATFORM HAS A VERTICAL DROP OF 6" OR GREATER OR HAS A SIDE APRON SLOPE STEEPER THAN 1:3 (33%). PROTECTIVE EDGING

SHOULD BE CONSIDERED WHEN CURB RAMPS OR LANDING PLATFORMS HAVE A VERTICAL DROP OF 3" OR MORE.

3 DETECTABLE EDGING WITH 6" MIN. HEIGHT AND CONTRASTING COLOR SHALL BE INSTALLED ON ALL CURB RAMP

## TERRACE TERRACE ORAINAGE ODRAINAGE TERRACE ODRAINAGE ODRAINAGE ODRAINAGE ODRAINAGE ODRAINAGE ODRAINAGE ODRAINAGE

WITH SIDE APRON  $^{\scriptsize{\scriptsize{\scriptsize{\scriptsize{5}}}}}$ 

# SIDEWALK PROTECTIVE EDGING ② 2" MIN. HEIGHT CURB FACE DRAINAGE 2 PROTECTIVE EDGING 2" MIN. HEIGHT DETECTABLE WARNING FIELD

**SDD 15D30** 

### TEMPORARY CURB RAMP PERPENDICULAR TO CURB

WITH PROTECTIVE EDGE

### TRAFFIC CONTROL, PEDESTRIAN ACCOMMODATION

STATE OF WISCONSIN
DEPARTMENT OF TRANSPORTATION

**SDD 15D30** 

### **LEGEND**

SIGN ON PERMANENT SUPPORT


SIGN ON TEMPORARY SUPPORT

UNDER PEDESTRIAN TRAFFIC

WORK AREA

TEMPORARY PEDESTRIAN BARRICADE

DIRECTION OF TRAFFIC

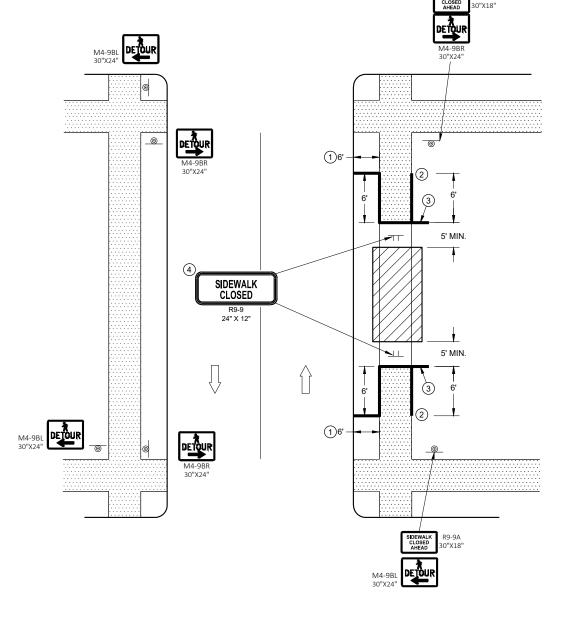

### SIDEWALK DETOUR, SIDEWALK ON BOTH SIDES

### **GENERAL NOTES**

SIGN LAYOUTS SHALL BE IN ACCORDANCE WITH THE WISCONSIN STANDARD SIGN PLATES.

WHERE TEMPORARY BARRICADE RUNS PARALLEL ALONG SIDEWALK, PLACE THE FACE OF THE BARRICADE AT THE EDGE OF THE SIDEWALK.


SIGNS THAT REMAIN IN PLACE LESS THAN SEVEN CONTINUOUS DAYS AND NIGHTS MAY BE MOUNTED ON PORTABLE SUPPORTS.

PLACE TEMPORARY PEDESTRIAN BARRICADE TO FIT FIELD CONDITIONS, AVOIDING CONFLICT WITH DRIVEWAYS AND OTHER EXISTING FEATURES.


- 1 IF TERRACE IS LESS THAN 6 FEET WIDE, OMIT TEMPORARY PEDESTRIAN BARRICADE FROM THE SIDEWALK TO THE CURB.
- (2) PLACE BARRICADE CLOSURE SO THAT THE TEMPORARY PEDESTRIAN BARRICADE END IS AT THE LAST OPEN SIDEWALK ACCESS TO RESIDENCES OR BUSINESSES BEFORE THE SIDEWALK CLOSURE.
- (3) IF TEMPORARY PEDESTRIAN BARRICADE PANEL IS WIDER THAN THE SIDEWALK WIDTH, THE PORTION OF EXCESS PANEL SHOULD EXTEND INTO THE TERRACE.
- 4 MOUNTING HEIGHT OF 5 FEET FROM THE SURFACE TO THE BOTTOM OF SIGN.

TRAFFIC CONTROL,
PEDESTRIAN ACCOMMODATION


STATE OF WISCONSIN
DEPARTMENT OF TRANSPORTATION

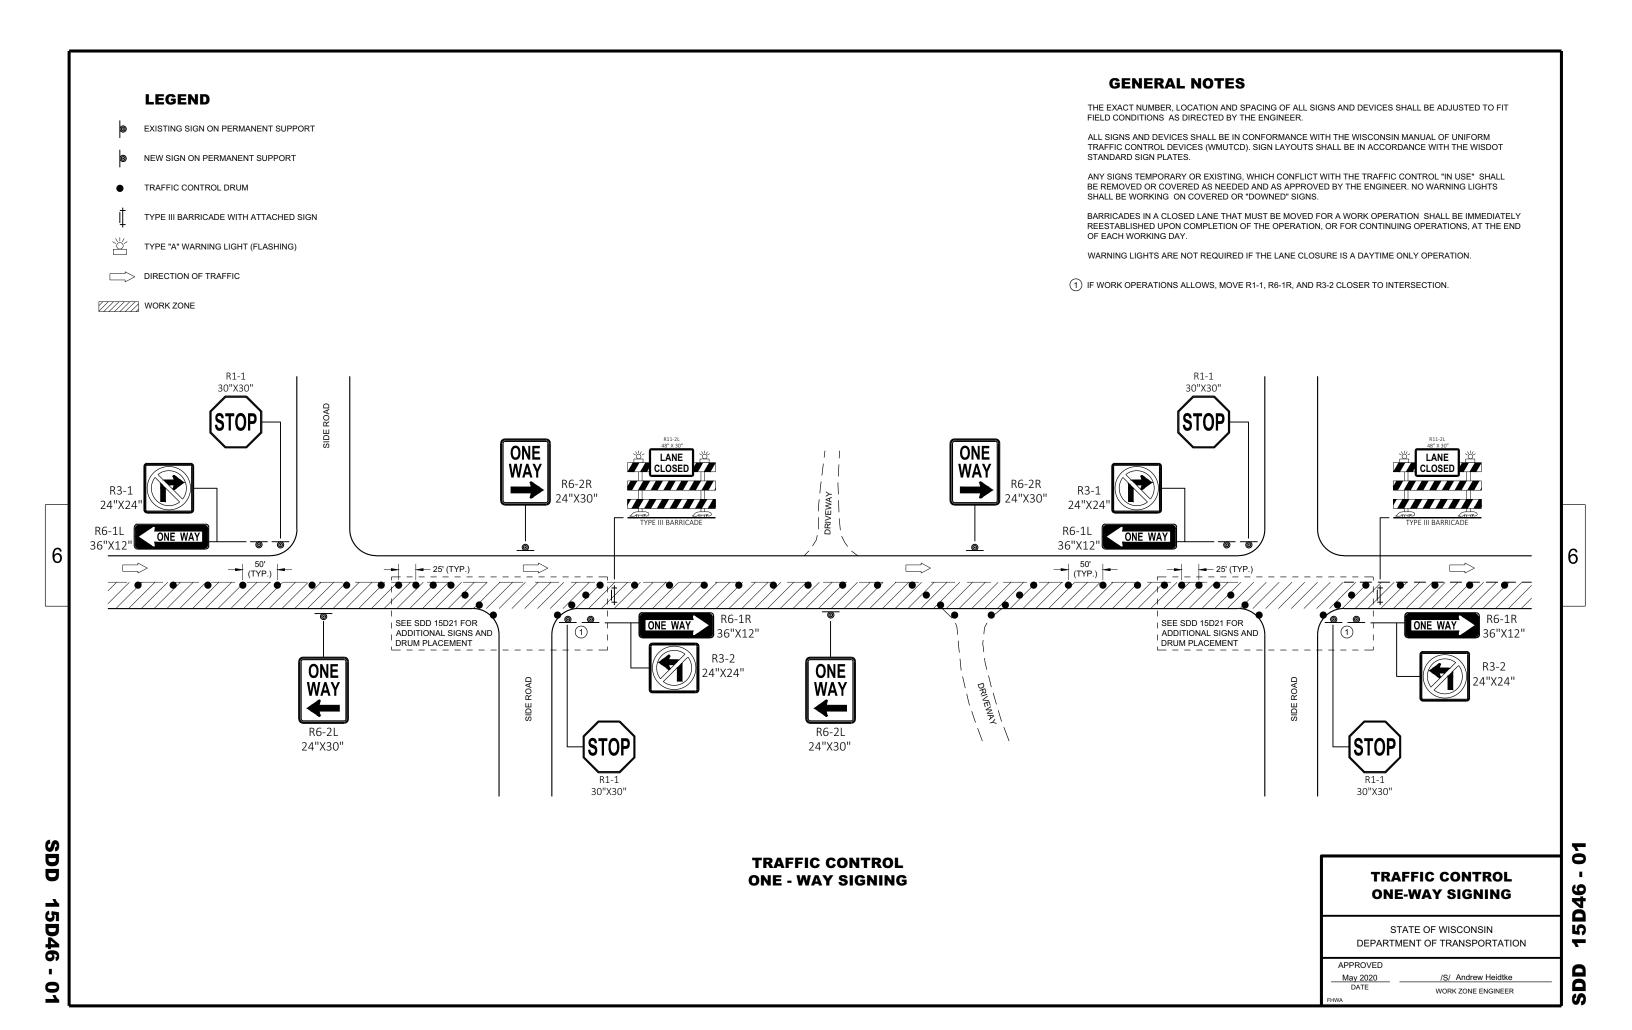



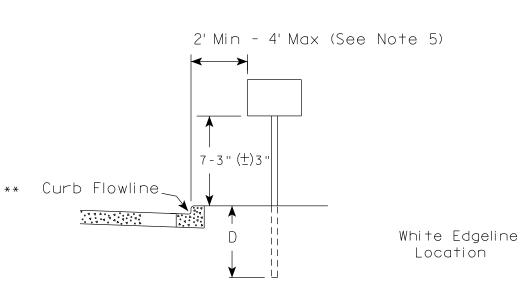

RURAL AREA (See Note 2)

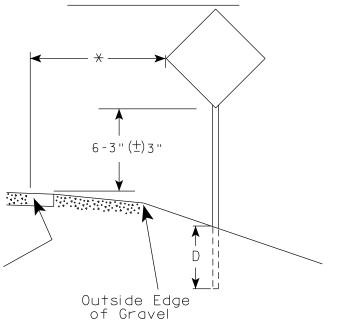


### GENERAL NOTES

- 1. Signs wider than 4 feet or 20 sq.ft or larger, shall be mounted on multiple posts. Refer to plate A4-4.
- 2. If signs are mounted on or behind barrier wall, see A4-10 sign plate.

The Double Arrow sign (W12-1D) shall be mounted at a height of 2'-3" ( $\pm$ ) 3". The Chevron sign (W1-8), Roundabout Chevron panel (R6-4B), Enhanced Reference Markers, Clearance Markers (W5-52), Mile Markers (D10 series), In Road Object Markers (W5-54) & End of Road Markers (W5-56) shall be mounted at a height of 4'-3" ( $\pm$ ) 3".

- 3. For expressways and freeways, mounting height is 7'- 3"  $(\pm)$  3" or 6'-3"  $(\pm)$  3" depending upon existence of a sub-sign.
- 4. Minimum mounting height for signs mounted on traffic signal poles is 5' 3'' ( $\frac{+}{-}$ ) 3''.
- 5. Offset distance shall be consistent with existing signs or consistent throughout length of project.
- 6. Folding signs shall be mounted at a height of 5'-3'' ( $\pm$ ) 3'' or as directd by the Engineer.

2' Min - 4' Max (See Note 5)

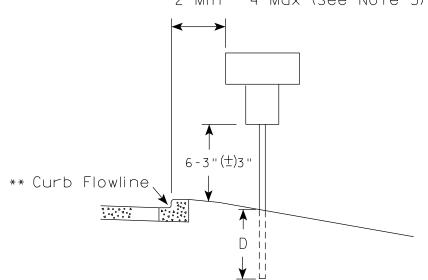

White Edgeline
Location

Outside Edge
of Gravel

POST EMBEDMENT DEPTH

Area of Sign	
Installation	D
( Sq.Ft.)	(Min)
20 or Less	4'
Greater than 20	5'

The existence of curb and gutter does not in itself mandate the vertical clearance illustrated. That height is typically measured where there is sidewalk adjacent to the roadway or parking is permitted. In the absence of sidewalk vertical clearance is measured from the top of the curb. Offset of signs is measured from the flow line.

\* 6 feet from edge of a paved shoulder or 12 feet from the edge of pavement (edge line location) or 2 feet from outside edge of gravel, whichever is greater unless directed by project engineer.

PLOT BY : mscj9h

TYPICAL INSTALLATION
OF PERMANENT TYPE II
SIGNS ON SINGLE POSTS

WISCONSIN DEPT OF TRANSPORTATION

APPROVED

Matthew R Rawh

For State Traffic Engineer

DATE 12/6/23 PLATE NO. \_A4-3.23

Ε

PROJECT NO: HWY: COUNTY: SHEET NO:



NOTES: 1. ALL MATERIAL TO BE APPROVED

BY ENGINEER PRIOR TO INSTALLATION

- 2. SEE SIGN PLATE A4-8 FOR SIGN HARDWARE REQUIREMENTS
- 3. 18 INCH X 18 INCH SQUARE BOX-OUTS MAY BE USED FOR INSTALLATIONS IN EXISTING CONCRETE OR ASPHALT LOCATIONS.



### **ELEVATION VIEW**

DETAIL OF STEEL 2 X 2 SIGN POST IN BOX-OUT



DETAIL OF WOOD 4 X 6 SIGN POST IN BOX-OUT

HWY:



### PLAN VIEW

COUNTY:

FOR NEW CONCRETE/ASPHALT INSTALLATIONS

SIGN POST BOX-OUTS A4-3B

WISCONSIN DEPT OF TRANSPORTATION

For State Traffic Engineer

DATE 1/27/14 PLATE NO. A4-3B.1

SHEET NO:

FILE NAME : C:\CAEFiles\Projects\tr\_stdplate\A43B.DGN

PROJECT NO:

PLOT DATE: 27-JAN-2014 09:48


PLOT NAME :


PLOT BY: mscsja

PLOT SCALE: 13.659812:1.000000


APPROVED

WISDOT/CADDS SHEET 42

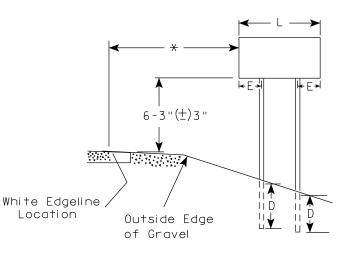

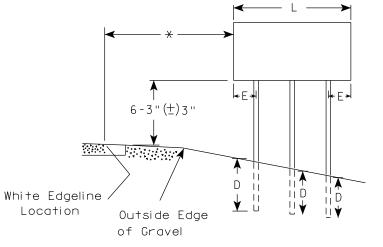

2'Min - 4'Max (See Note 6)

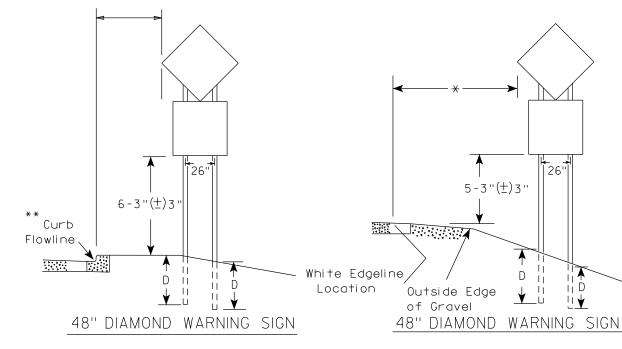

	SIGN SHAPE OTHER THAN (TWO POSTS REQUIRE)	
	L	E
***	Greater than 48" Less than 60"	12"
	60" to 108"	L/5

HWY:

SIGN SHAPE OTHER THAN	DIAMOND
(THREE POSTS REQUIR	RED)
L	E
Greater than 108" to 144"	12''

### GENERAL NOTES

- 1. For 3 or 4 post installations, individual post spacing shall be greater than 3'-6".
- 2. See tables below for required number of posts.
- 3. For expressways and freeways, mounting height is 7'-3" (±) 3" or 6'-3" (±) 3" depending upon existence of sub-sign.
- 4. The (±) tolerance for mounting height is 3 inches.
- 5. J-Assemblies are considered to be one sign for mounting height.
- 6. Offset distance shall be consistent with existing signs or consistent throughout length of project.
- 7. Folding signs shall be mounted at a height of 5'-3'' ( $\pm$ ) 3'' or as directed by the engineer.
- 8. The Double Arrow sign (W12-1) shall be mounted at a height of 2'-3" (±) 3". The Chevron sign (W1-8), Roundabout Chevron panel (R6-4B), Clearance Markers (W5-52), Mile Markers (D10 series), In Road Object Markers (W5-54) & End of Road Markers (W5-56) shall be mounted at a height of 4"-3" (±) 3".
- \* 6 feet from edge of a paved shoulder or 12 feet from the edge of pavement (edge line location) or 2 feet from outside edge of gravel, whichever is greater unless directed by project engineer.
- \*\* The existence of curb and gutter does not in itself mandate the vertical clearance illustrated. That height is typically measured where there is sidewalk adjacent to the roadway or parking is permitted. In the absence of sidewalk vertical clearance is measured from the top of the curb. Offset of signs is measured from the flow line.
- $\times \times \times$  See A4-3 sign plate for signs 4' or less in width and less than 20 S.F. in area.

### POST EMBEDMENT DEPTH

	ı
Area of Sign	
Installation	D
( Sq. Ft.)	(Min)
20 or Less	4'
Greater than 20	5'

TYPICAL INSTALLATION OF TYPE II SIGNS ON MULTIPLE POSTS

WISCONSIN DEPT OF TRANSPORTATION

APPROVED

Matther R Rauch
For State Traffic Engineer

DATE 12/6/23

PLATE NO. <u>A4-4.16</u>

Ε

CHEET NO.

SHEET NO:

FILE NAME : C:\CAEfiles\Project\tr\_stdplate\A44.dgn

PROJECT NO:


COUNTY:

PLOT DATE: 6-DEC 2023 11:31

PLOT NAME :

PLOT BY : mscj9h

PLOT SCALE: \$\$.....plotscale.....\$\$ WISDOT/CADDS SHEET 42

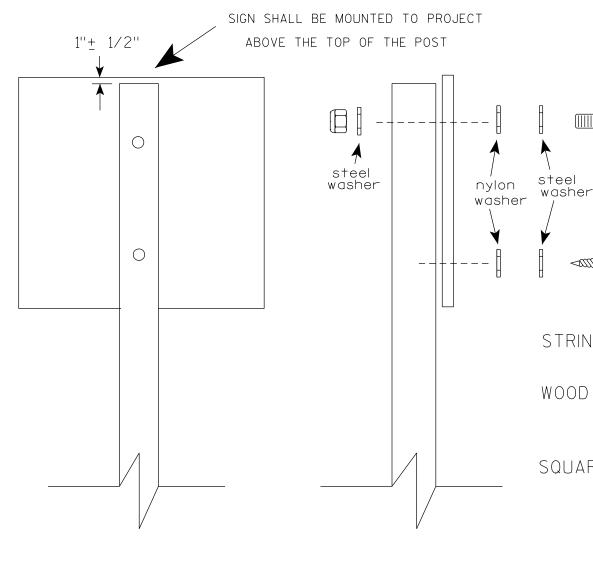

Nuts, bolts and lags used for mounting signs shall have hexagonal heads and shall be either:

- a. Hot dip galvanized in accordance with ASTM Designation: A 153. Class D. or SC 3
- b. Electro-galvanized in accordance with ASTM Designation: B 633, TYPE III, SC 3.

Threads on bolts and nuts shall be manufactured with sufficient allowance for the cadmium plate or galvanized coating to permit the nuts to run freely on the bolts.

STRINGER BOLTING TO ALUMINUM SIGNS (SEE SIGN PLATE A4-18)

MACHINE BOLTS -  $\frac{5}{16}$ " X 1-3/4" Length w/ lock nuts

WOOD POSTS  $(4'' \times 6'')$ 

LAG SCREWS - 3/8" X 3" (NO STRINGERS ON BACK OF SIGN) 3/8" X 4" (STRINGERS ON BACK OF SIGN)

SQUARE STEEL POSTS (2" x 2")

MACHINE BOLTS - 3/8" X 3-1/4" Length w/ nuts (NO STRINGER ON BACK OF SIGN) 3/8" X 5" Length w/ nuts (STRINGERS ON BACK OF SIGN)

RIVETS - 1/32 " (6605-9-6) BULB-TITE. TRI-FOLD. ALUMINUM BODY/MANDREL O.D. FLANGE .720-.765 INCH, GRIP RANGE .042-.375 INCH

WASHERS (ALL POSTS) -

1-1/4" O.D. X  $\frac{3}{8}$ " I.D. X  $\frac{1}{16}$ " STEEL 1-1/4" O.D. X  $\frac{3}{8}$ " I.D. X .080 NYLON

Two different fastening systems are shown for illustration purposes. On any individual sign, either one or the other system shall be used. Actual number of fasteners per sign varies with the sign area, but normally there are two. For a single post installation, all signs greater than 9 sq.ft. require the use of 3 fasteners.

ATTACHMENT OF SIGNS TO POSTS

WISCONSIN DEPT OF TRANSPORTATION

APPROVED Matther

≠or State Traffic Engineer

SHEET NO:

DATE 4/1/2020

PLATE NO. <u>A4-8.9</u>

PLOT DATE: 01-APRIL-2020

PLOT BY : dotc4c

WISDOT/CADDS SHEET 42

Ε

FILE NAME : C:\CAEFiles\Projects\tr\_stdplate\A48.DGN

PROJECT NO:



PROJECT NO: HWY: COUNTY: SHEET NO: FILE NAME : C:\CAEFiles\Projects\tr\_stdplate\A49.DGN PLOT DATE: 05-FEB-2015 17:09 PLOT BY: mscsja PLOT NAME : PLOT SCALE: 13.659812:1.000000

DATE 2/05/15

PLATE NO. <u>A4-9.9</u>

For State Traffic Engineer



### BANDING



SINGLE SIGN





### WASHER PLACEMENT



HWY:

WASHERS (ALL POSTS) -

1-1/4" O.D. X<sup>3</sup>/<sub>8</sub>" I.D. X<sup>1</sup>/<sub>16</sub>" STEEL 1-1/4" O.D.  $\times \frac{3}{8}$ " I.D.  $\times$  .080 NYLON FOR ALL TYPE H SIGNS

CHANNEL

### GENERAL NOTES

- 1. Any sign over 3 feet in width shall use the V-Block banding method. See A5-10 standard plate.
- 2. Signs 3 feet or greater in height shall have three bracket bands installed. Signs less than 3 feet in height shall have two bracket bands installed.
- 3. Banding and assembly bracket shall be stainless steel. All bands shall be  $\frac{3}{4}$ " in width and 0.025" thickness.
- 4. ALL SIGN MOUNTING BOLTS AND WASHERS SHALL BE EITHER:
  - a. Hot dip or mechanically galvanized in accordance with ASTM Designation: A 153, Class D
  - b. Electro-galvanized in accordance with ASTM designation: B 633, Type III, SC 3

### "J" ASSEMBLY



STANDARD SIGN SIGN BANDING DETAILS

WISCONSIN DEPT OF TRANSPORTATION

SHEET NO:

APPROVED

DATE 6/10/19

PLATE NO. A5-9.4

Ε

State Traffic Engineer

COUNTY:

PLOT NAME :

PLOT SCALE: \$\$.....plotscale.....\$\$ WISDOT/CADDS SHEET 42

PROJECT NO:

VIEW FROM TOP

### GENERAL NOTES

- 1. WOOD 4"X6" POST MATERIAL SHALL CONFORM TO 507.2.2 OF THE WISDOT STANDARD SPECIFICATIONS
- 2. BLOCK BANDING AND CLIPS SHALL BE STAINLESS STEEL,  $\frac{3}{4}$ " WIDTH AND 0.025" THICKNESS
- 3. SIGNS 3' OR GREATER IN HEIGHT SHALL UTILIZE 3 BLOCK BANDS.

  SIGNS UNDER 3' IN HEIGHT SHALL UTILIZE 2 BLOCK BANDS
- 4. ACTUAL NUMBER OF FASTENERS PER SIGN VARIES WITH THE SIGN AREA, BUT NORNALLY THERE ARE TWO. FOR SIGNS GREATER THAN 9 S.F. 3 FASTENERS SHALL BE USED.
- 5. ALL SIGN MOUNTING BOLTS AND WASHERS SHALL BE EITHER:
  - a. Hot dip or mechanically galvanized in accordance with ASTM Designation: A 153, Class D
  - b. Electro-galvanized in accordance with ASTM Designation: B 633, TYPE III, SC 3
- 6. ALL BOLTS SHALL HAVE HEXAGONAL HEADS.
- 7. STEEL WASHERS SHALL BE  $1^{1}/_{4}$ " O.D. X  $3/_{8}$ " I.D. X  $1/_{16}$ "
- 8. NYLON WASHERS SHALL BE  $1^{1}/_{4}$ " O.D. X  $3/_{8}$ " I.D. X .080 FOR TYPE H OR TYPE F FACE SIGN

 $\rightarrow$  LAG BOLTS SHALL BE  $\frac{3}{8}$ " X  $\frac{2}{2}$ "

BLOCK BANDING DETAIL ( V-BLOCK OPTION )

WISCONSIN DEPT OF TRANSPORTATION

Manher R

APPROVED

DATE 4/19/2022 PLATE NO. A5-10.3

SHEET NO:

FILE NAME : C:\CAEfiles\Projects\tr\_stdplate\A510.dgn

PROJECT NO:

PLOT DATE: 19-APRIL 2022 11:55

SIGN

PLOT BY : dotc4c

WISDOT/CADDS SHEET 42

Ε

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### NOTES

- 1. Sign is Type II Type F Reflective
- 2. Color:

Background - Orange Message - Black

- 3. Message Series C
- 4. Corners may be square or rounded when base material is plywood but borders shall be rounded as shown. When base material is metal, the corners and borders shall be rounded.

C —		
		H
		F H B
		F G G
<b>←</b>		<b>→</b>
l	G20-2A	ı

SIZE D 4.5 36 3/8 1/23 3/4 | 2 1/2 | 4 1/8 | 4 1/8 | 11 1/8 12 1/8 18 1 1/2 4 1/2 3 3/4 5 7/8 6 3/4 16 3/4 2 1/2 1 3/4 18 1/2 5/8 48 1 1/8 1/2 8.0 2M 1 1/8 4 1/2 3 3/4 5 7/8 6 3/4 16 3/4 2 1/2 1 3/4 18 1/2 48 5/8 24 1/2 8.0 48 1 1/8 5/8 4 1/2 3 3/4 5 7/8 6 3/4 16 3/4 2 1/2 1 3/4 18 1/2 24 1/2 8.0 4 1/2 3 3/4 4 48 24 1 1/8 1/2 5/8 5 % 6 3/4 | 16 3/4 | 2 1/2 | 1 3/4 | 18 1/2 8.0 5 48 24 | 1  $\frac{7}{8}$ 1/2 5/8 4 1/2 | 3 3/4 | 5 7/8 | 6 3/4 | 16 3/4 | 2 1/2 | 1 3/4 | 18 1/2 | 6 8.0

COUNTY:

STANDARD SIGN G20-2A

WISCONSIN DEPT OF TRANSPORTATION

APPROVED Matthew & Raw

SHEET NO:

For State Traffic Engineer

DATE 1/26/2023 PLATE NO. G20-2A.10

FILE NAME : C:\CAEfiles\Projects\tr\_stdplate\G202A.dgn

HWY:

PROJECT NO:

PLOT DATE: 26-JAN 2023 8:27

PLOT BY : dotc4c

PLOT NAME :


PLOT SCALE: \$\$.....plotscale.....\$\$ WISDOT/CADDS SHEET 42

### NOTES

- 1. Sign is Type II-Type F Reflective
- 2. Color:

Background - Orange Message - Black

- 3. Message Series D
- 4. Corners may be square or rounded when base material is plywood but borders shall be rounded as shown. When base material is metal, the corners and borders shall be rounded.
- 5. M4-9BL is the same as M4-9BR except the arrow is reversed.

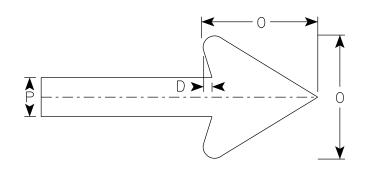

Arrow Detail

SIZE	Α	В	С	D	E	F	G	Н	Т	J	K	L	М	N	0	Р	Q	R	S	Т	U	V	l w	X	Υ	Z	Area sq. ft.
1		_	_											,			-				_						34. 11.
25	30	24	1 1/2	3/8	1/2	5	5 1/4	7 1/8	3 3/4	1	1 1/8	1 <sup>5</sup> / <sub>8</sub>	11 3/4	7	6	2											5.0
2M	30	24	1 1/2	3/8	1/2	5	5 1/4	7 1/8	3 3/4	1	1 1/8	1 <sup>5</sup> / <sub>8</sub>	11 3/4	7	6	2											5.0
3																											
4																											
5																											

COUNTY:

M4-9BR

STANDARD SIGN M4-9B L&R

WISCONSIN DEPT OF TRANSPORTATION

APPROVED Matthew R La Forstate Traffic Engineer

DATE 2/9/2023

2023 PLATE NO. M4-9B.4
SHEET NO:

Ε

FILE NAME : C:\CAEfiles\Projects\tr\_stdplate\M49B.dgn

HWY:

PROJECT NO:

PLOT DATE: 9-FEB 2023 11:55

PLOT BY : dotc4c


PLOT NAME :

PLOT SCALE: \$\$.....plotscale.....\$\$ WISDOT/CADDS SHEET 42

- 1. Sign is Type II- Type F Reflective
- 2. Color:

Background - Orange Message - Black

- 3. Corners may be square or rounded when base material is plywood but borders shall be rounded as shown. When base material is metal, the corners and borders shall be rounded.
- 4. M4-60L is the same as M4-60R except the arrow is reversed.

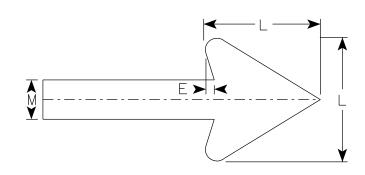

Arrow Detail

H K K	
M4-60R	

SIZE	Α	В	С	D	E	F	G	Н	I	J	К	L	М	N	0	Р	Q	R	S	Т	U	٧	w	Х	Y	Z	Area sq. ft.
1																											
25	30	24	1 1/2	3/8	1/2	2 1/2	11	6	2	3 1/4	7	6	2														5.00
2M	30	24	1 1/2	3/8	1/2	2 1/2	11	6	2	3 1/4	7	6	2														5.00
3																											
4																											
5																											

STANDARD SIGN M4-60 L&R

WISCONSIN DEPT OF TRANSPORTATION

APPROVED Matthew R Rauch

For state Traffic Engineer

DATE 2/14/2023 PLATE NO. M4-60.2

PROJECT NO: HWY: COUNTY: SHEET NO:

FILE NAME: C:\CAEfiles\Projects\tr\_stdplate\M460.dgn

PLOT DATE: 14-FEB 2023 8:12

PLOT BY: dotc4c

PLOT NAME:

PLOT NAME:

PLOT NAME:


PLOT SCALE: \$\$.....plotscale.....\$\$ WISDOT/CADDS SHEET 42

7

- 1. Sign is Type II- Type F Reflective
- 2. Color:

Background - Orange Message - Black

3. Corners may be square or rounded when base material is plywood but borders shall be rounded as shown. When base material is metal, the corners and borders shall be rounded.

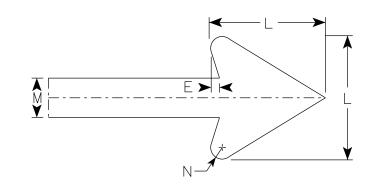

Arrow Detail

IZE A	В	С	D	E	F	G	Н	I	J	K	L	М	N	0	Р	Q	R	S	T	U	V	W	X	Y	Z	Area sq. ft
1																										
2S 30	24	1 1/2	3/8	1/2	2 1/2	11	6	2	3 1/4	10 3/8	6	2	3/8													5.00
2M 30	24	1 1/2	3/8	1/2	2 1/2	11	6	2	3 1/4	10 3/8	6	2	3/8													5.00
3																										
4																										

COUNTY:

M4-60D

STANDARD SIGN M4-60D

WISCONSIN DEPT OF TRANSPORTATION

APPROVED Matthew & Rau

SHEET NO:

For State Traffic Engineer
DATE 2/14/2023 PLATE NO. M4-60D.2

HWY:

PLOT DATE: 14-FEB 2023 9:49

G

PLOT BY : dotc4c

PLOT NAME :

PLOT SCALE: \$\$.....plotscale.....\$\$

E NAME : C:\CAETIIES\Projects\Tr\_STapIdTe\M46UD.agn

PROJECT NO:

.




- 1. Sign is Type II Type H Reflective
- 2. Color:

Background - White

Message - See note 3

3. Border & Arrow are non reflective black, the circle with diagonal bar is reflective red.

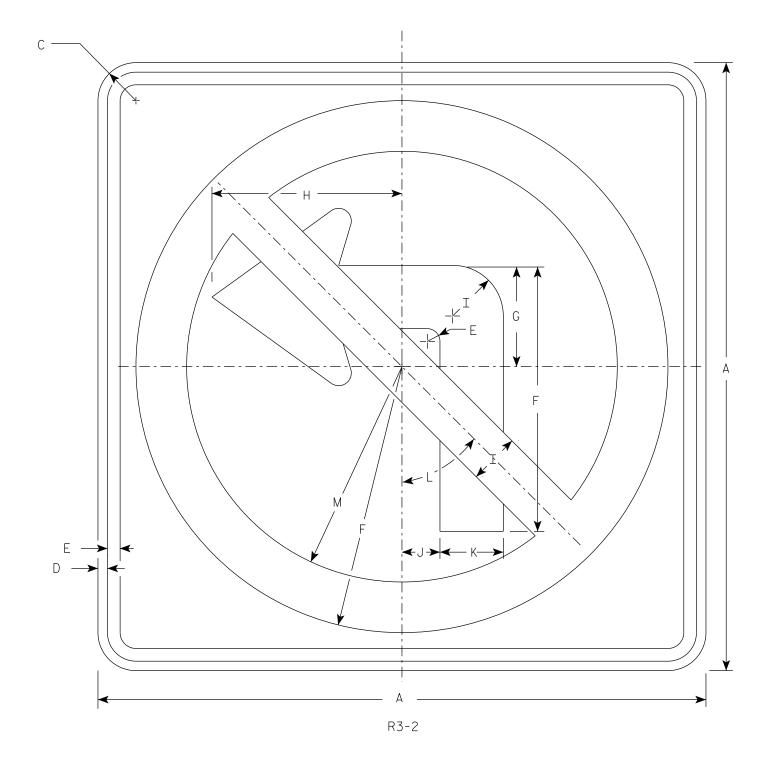

N N N N

ARROW DETAIL

SIZE	Α	В	С	D	E	F	G	Н	I	J	K	L	М	N	0	Р	Q	R	S	Т	U	٧	W	Х	Y	Z	Area sq. ft.
1	24		1 1/2	3/8	1/2	10 1/2	4	7 1/2	2	1 1/2	2 1/2	45°	8 1/2	5	6	1/2											4.0
25	24		1 1/2	3/8	1/2	10 1/2	4	7 1/2	2	1 1/2	2 1/2	45°	8 1/2	5	6	1/2											4.0
2M	36		2 1/4	5/8	3/4	15 ¾	6	11 1/4	3	2 1/4	3 3/4	45°	12 3/4	7 1/2	9	3/4											9.0
3	36		2 1/4	5/8	3/4	15 3/4	6	11 1/4	3	2 1/4	3 3/4	45°	12 3/4	7 1/2	9	3/4											9.0
4	36		2 1/4	5/8	3/4	15 3/4	6	11 1/4	3	2 1/4	3 3/4	45°	12 3/4	7 1/2	9	3/4											9.0
5	48		2 1/4	3/4	1	21	8	15	4	3	5	45°	17	10	12	1											16.0

COUNTY:

STANDARD SIGN R3-2

WISCONSIN DEPT OF TRANSPORTATION

SHEET NO:

APPROVED Matthew & & Forstate Traffic Engineer

DATE <u>2/2/23</u>

PLATE NO. <u>R3-2.11</u>

Ε

FILE NAME : C::CAEfiles\Projects\tr\_stdpldate\R32.dgn

PROJECT NO:

HWY:

PLOT DATE: 9-JULY 2024 2:11

PLOT BY: mscj9h


PLOT NAME :


- 1. Sign is Type II Type H Reflective
- 2. Color:

Background - White Message – Black


3. R4-8 is the same as R4-7 except Legend is reversed.

## DIVIDER DETAIL

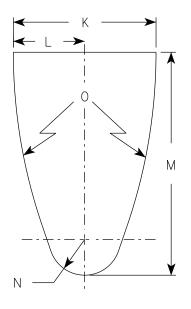

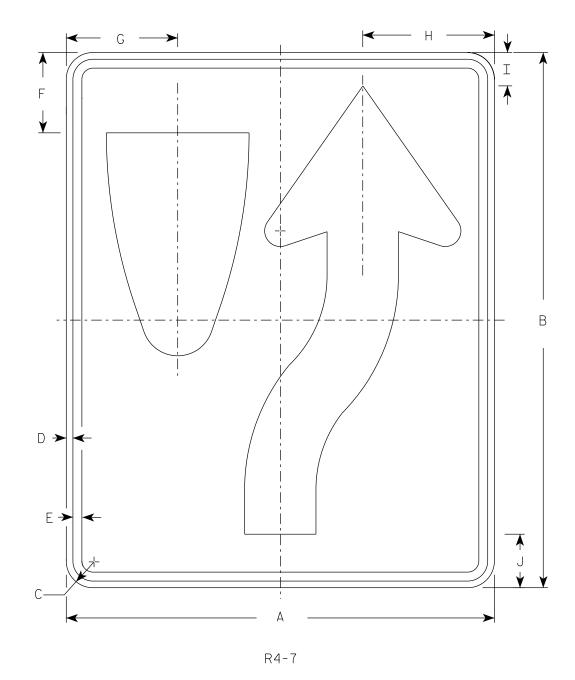

## ARROW DETAIL

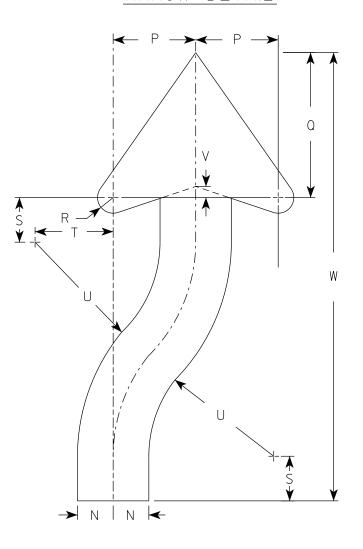

SIZE	А	В	С	D	E	F	G	Н	I	J	K	L	М	N	0	Р	Q	R	S	Т	U	٧	W	Х	Y	Z	Area sq. ft.
1	18	24	1 1/2	3/8	1/2	3 3/8	4 3/4	5 1/2	1 3/8	2 1/4	6	3	9 3/8	1 1/2	22 1/2	3 1/2	6 1/8	5/8	1 1/8	3 1/4	6 3/4	1/2	20 3/8				3.0
25	24	30	1 1/2	3/8	1/2	4 1/2	6 1/4	7 3/8	1 1/8	3	8	4	12 1/2	2	30	4 5/8	8 1/8	7/8	2 1/2	4 3/8	9	5/8	25 1/8				5.0
2M	24	30	1 1/2	3/8	1/2	4 1/2	6 1/4	7 3/8	1 1/8	3	8	4	12 1/2	2	30	4 5/8	8 1/8	7/8	2 1/2	4 3/8	9	5/8	25 1/8				5.0
3	36	48	1 1/8	1/2	5/8	6 3/4	9 3/8	11 1/8	2 1/8	4 1/2	12	6	18 3/4	3	45	6 1/8	12 1/4	1 1/4	3 3/4	6	13 1/2	1	40 3/4				12.0
4	36	48	1 1/8	1/2	5/8	6 3/4	9 3/8	11 1/8	2 1/8	4 1/2	12	6	18 3/4	3	45	6 %	12 1/4 1	1 1/4	3 3/4	6	13 1/2	1	40 3/4				12.0
5	48	60	3	3/4	1	9	12 1/2	14 3/4	3 3/4	6	16	8	25	4	60	9 1/4	16 1/4	1	5	8 3/4	18	1 1/4	50 1/4				20.0

STANDARD SIGN R4-7 & R4-8

WISCONSIN DEPT OF TRANSPORTATION

APPROVED

For State Traffic Engineer DATE 8/17/23 PLATE NO. R4-7.9

SHEET NO:

FILE NAME : C:\CAEfiles\Projects\tr\_stdplate\R47.dgn

HWY:

PROJECT NO:

COUNTY:

PLOT DATE: 17-AUG 2023 12:39

PLOT BY : mscj9h

PLOT NAME :




- 1. Sign is Type II Type H Reflective
- 2. Color:

Background - Black

Message - Black Legend & White Arrow & Border

3. Message Series - D

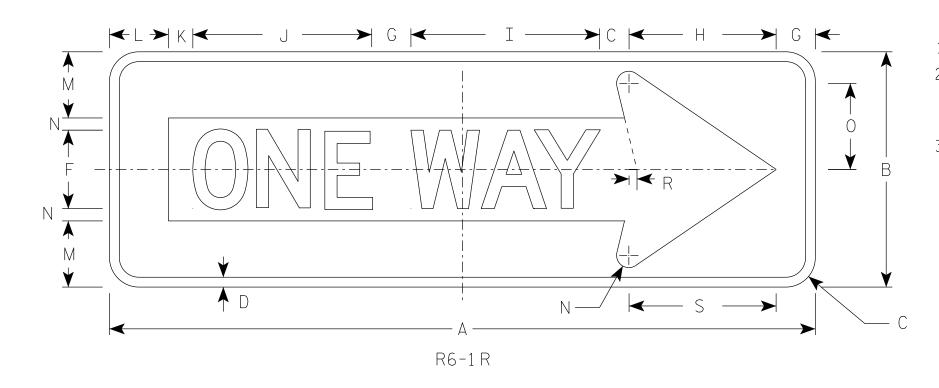

P —	$ \longrightarrow G                                  $
	   R6-1 L

SIZE	Α	В	С	D	E	F	G	Н	I	J	К	L	М	N	0	Р	Q	R	S	Т	U	V	W	Х	Y	Z	Area sq. ft.
1																											
25	36	12	1 1/2	1/2		4	2	7 1/2	9 5/8	9 1/8	1 1/4	3	3 3/8	5/8	4 3/8	11		3/8	7 1/2								3.0
2M	54	18	1 1/2	3/4		6	3	11 1/4	13 %	14 1/2	1 1/8	4 1/2	5	1	6 1/2	16 1/2		5/8	11 1/4								6.75
3	54	18	1 1/2	3/4		6	3	11 1/4	13 %	14 1/2	1 1/8	4 1/2	5	1	6 1/2	16 1/2		5/8	11 1/4								6.75
4	54	18	1 1/2	3/4		6	3	11 1/4	13 %	14 1/2	1 1/8	4 1/2	5	1	6 1/2	16 1/2		5/8	11 1/4								6.75
5																											

STANDARD SIGN R6-1 L&R

WISCONSIN DEPT OF TRANSPORTATION

APPROVED

Matther R Rauch

For State Traffic Engineer

DATE 8/30/23

PLATE NO. <u>R6-1.4</u>

SHEET NO:

FILE NAME : C:\CAEfiles\Projects\tr\_stdplate\R61.dgn

PROJECT NO:

PLOT DATE: 30-AUG 2023 3:40

PLOT BY : mscj9h


WISDOT/CADDS SHEET 42


Ε

- 1. Sign is Type II Type H Reflective
- 2. Color:

Background - White Message – Black

- 3. Message Series D
- 4. R6-2L same as R6-2R except arrow points to the left.

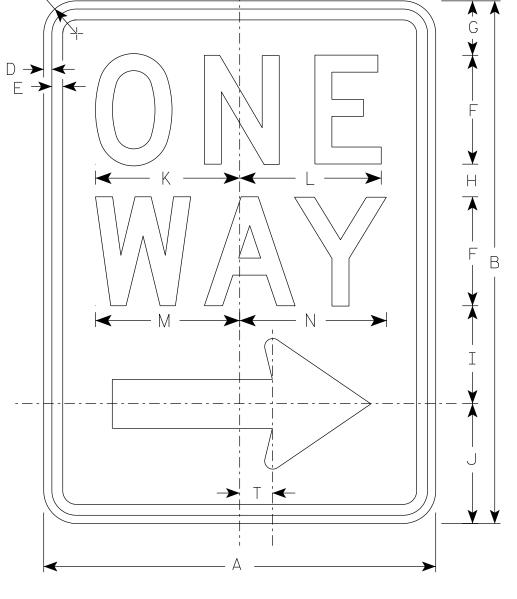

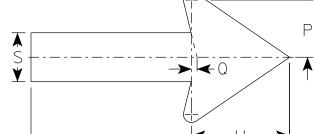

Arrow Detail

R6-2R

SIZE	А	В	С	D	Е	F	G	Н	I	J	K	L	М	N	0	Р	Q	R	S	Т	U	٧	W	Х	Υ	Z
1	18	24	1 1/2	3/8	1/2	5	2 1/2	1 1/2	4 1/2	5 1/2	6 %	6 1/2	6 %	6 3/4	11 1/8	2 5/8	1/4	3/8	2 1/4	1 1/2	4 1/2					
25	24	1 1/2	1 1/2	3/8	1/2	6	3	2 1/2	5 1/2	7	8 1/8	8 1/8	8 1/2	8 5/8	16	3 1/2	3/8	1/2	3	2	6					
2M	30	36	1 1/8	1/2	5/8	8	2 1/2	2 5/8	6 1/8	8	10 1/2	10 1/2	11 1/4	11 1/4	20	4 3/8	1/2	5/8	3 3/4	2 1/2	7 1/2					
3	36	48	1 1/8	1/2	5/8	10	5 1/4	3 1/4	9	10 1/2	12 3/4	12 3/4	13 1/4	13 1/2	24	5 %	1/2	3/4	4 3/4	3	9					
4	36	48	1 1/8	1/2	5/8	10	5 1/4	3 1/4	9	10 1/2	12 3/4	12 3/4	13 1/4	13 1/2	24	5 5/8	1/2	3/4	4 3/4	3	9					
5																										

STANDARD SIGN R6-2 R&L

WISCONSIN DEPT OF TRANSPORTATION

APPROVED

 $\mathcal{F}_{or}$  State Traffic Engineer

SHEET NO:

DATE 11/2/10

PLATE NO. R6-2.8

FILE NAME : C:\CAEfiles\Projects\tr\_stdplate\R62.dgn

HWY:

PROJECT NO:


COUNTY:

PLOT DATE: 30-AUG 2023 3:56 PLOT BY: mscj9h PLOT NAME :

- 1. Sign is Type II Type H Reflective
- 2. Color:

Background - White Message - Black

- 3. Message Series C
- 4. Use Size 2 for Sidewalks. Use Size 3 for Paths and Trails.

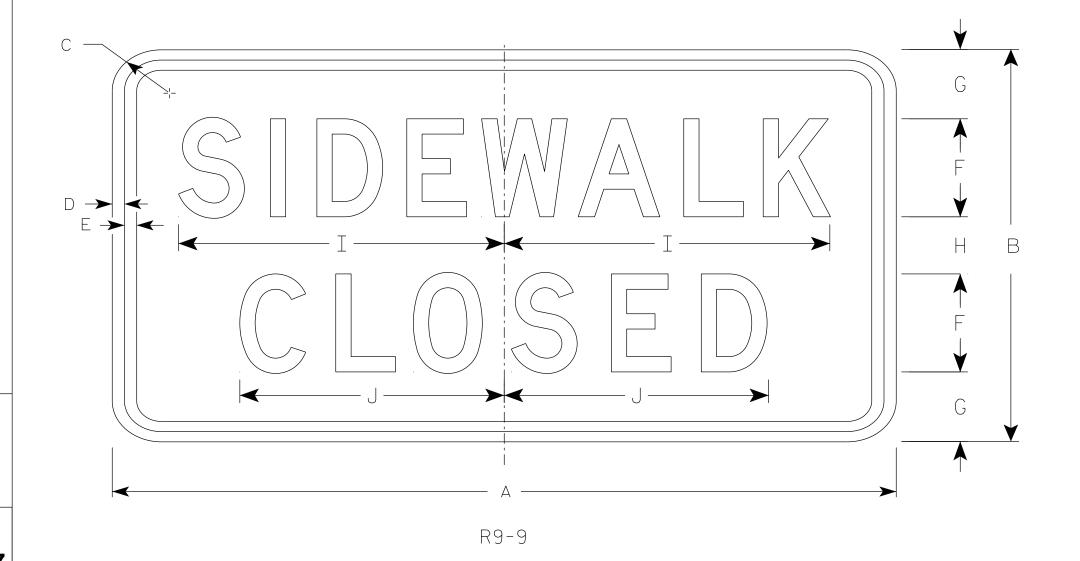

SIZE	А	В	С	D	E	F	G	Н	I	J	K	L	М	Ν	0	Р	Q	R	S	Т	U	V	W	X	Y	Z	Area sq. ft.
1																											
25	24	12	1 1/2	1/2	1/2	3	2 1/8	1 3/4	10	8 1/8																	2.0
2M	24	12	1 1/2	1/2	1/2	3	2 1/8	1 3/4	10	8 1/8																	2.0
3	30	18	1 1/2	1/2	1/2	4	3 1/2	3	12 1/2	10 1/4																	3.75
4																											
5																											

COUNTY:

STANDARD SIGN R9-9

WISCONSIN DEPT OF TRANSPORTATION

APPROVED

For State Traffic Engineer

SHEET NO:

DATE <u>1/24/24</u>

PLATE NO. <u>R9-9.7</u>

FILE NAME : C:\CAEfiles\Projects\tr\_stdplate\R99.dgn

HWY:

PROJECT NO:

PLOT DATE: 24-JAN 2024 11:55

PLOT BY: mscj9h

PLOT NAME :

PLOT SCALE: \$\$.....plotscale.....\$\$WISDOT/CADDS SHEET 42


1

- 1. Sign is Type II Type H Reflective
- 2. Color:

Background - White

Message – Black

3. Message Series - D

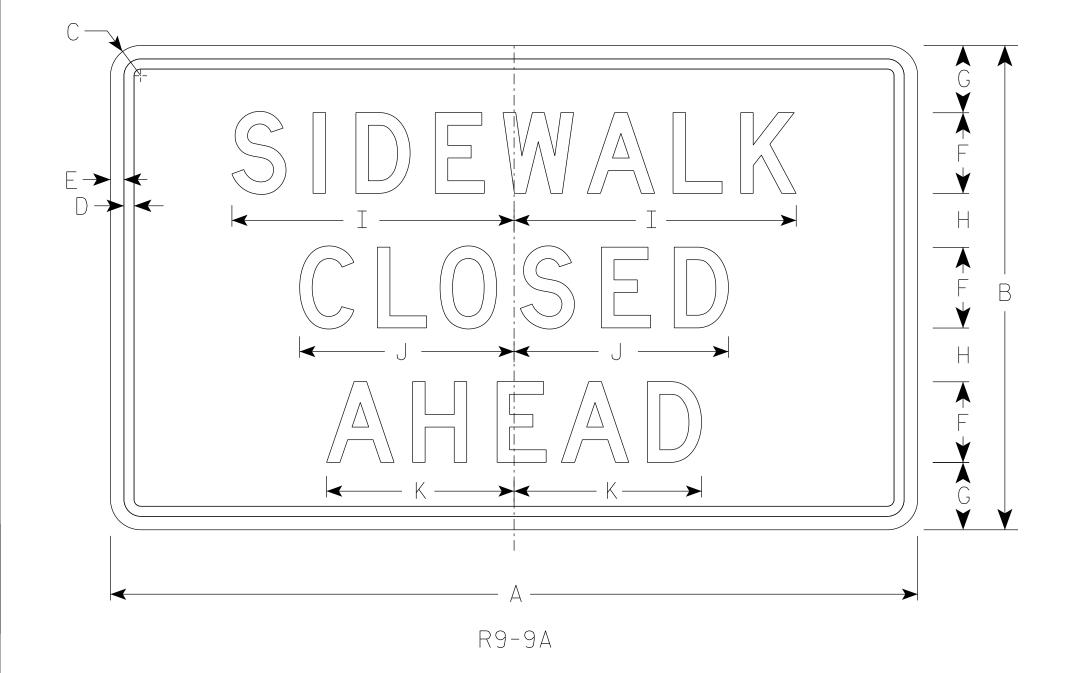

l																											
SIZE	А	В	С	D	E	F	G	Н	I	J	K	L	М	N	0	Р	Q	R	S	Т	U	V	W	X	Y	Z	Area sq. ft.
1																											
25	30	18	1 1/2	3/8	1/2	3	2 1/2	2	10 1/2	8	7																3.75
2M	30	18	1 1/2	3/8	1/2	3	2 1/2	2	10 1/2	8	7																3.75
3																											
4																											
5																											
PRC	JECT	NO:					НΛ	WY:					COU	NTY:													

STANDARD SIGN R9-9A

WISCONSIN DEPT OF TRANSPORTATION

APPROVED Matthew  $f_{or}$  State Traffic Engineer

DATE 1/24/24 PLATE NO. R9-9A.2 SHEET NO:

Ε

FILE NAME : C:\CAEFiles\Projects\tr\_stdplate\R99A.DGN

PLOT DATE : 24-JAN 2024 11:58

PLOT BY: mscj9h

- 1. Sign is Type II Type H Reflective
- 2. Color:

Background - White Message – Black

- 3. Message Series C
- 4. Size (1) comes as a decalonly.

C	
PUSH C F C F C F C F C F C F C F C F C F C	<b>▲</b>
WT0-52	

SIZE	А	В	С	D	E	F	G	Н	I	J	K	L	М	N	0	Р	Q	R	S	Т	U	٧	W	Χ	Y	Z	Area sq. ft.
1	6	9	1 1/2	3/8	3/8	3/4	3/8	1	1 3/4	2	7/8	2 1/8	5/8	5/8	7/8	1 5/8	1/4	1 1/4	2 1/8								.38
25	9	12	1 1/2	3/8	3/8	1	1/2	1 1/4	2 1/4	3	1 3/8	3 1/8	1	7/8	1 1/4	2 1/2	1/4	1 1/8	3 3/4								.75
2M	9	12	1 1/2	3/8	3/8	1	1/2	1 1/4	2 1/4	3	1 3/8	3 1/8	1	7/8	1 1/4	2 1/2	1/4	1 1/8	3 3/4								.75
3																											
4																											
5																											

COUNTY:

STANDARD SIGN R10-25

WISCONSIN DEPT OF TRANSPORTATION

APPROVED Matthew

 $f_{or}$  State Traffic Engineer

DATE 2/5/24 PLATE NO. R10-25.2

SHEET NO:

Ε

HWY:

PLOT DATE : 5-FEB 2024 10:02


PLOT BY: mscj9h

PLOT NAME :

PLOT SCALE: \$\$.....plotscale.....\$\$ WISDOT/CADDS SHEET 42

FILE NAME : C:\CAEfiles\Projects\tr\_stdplate\R1025.dgn

PROJECT NO:

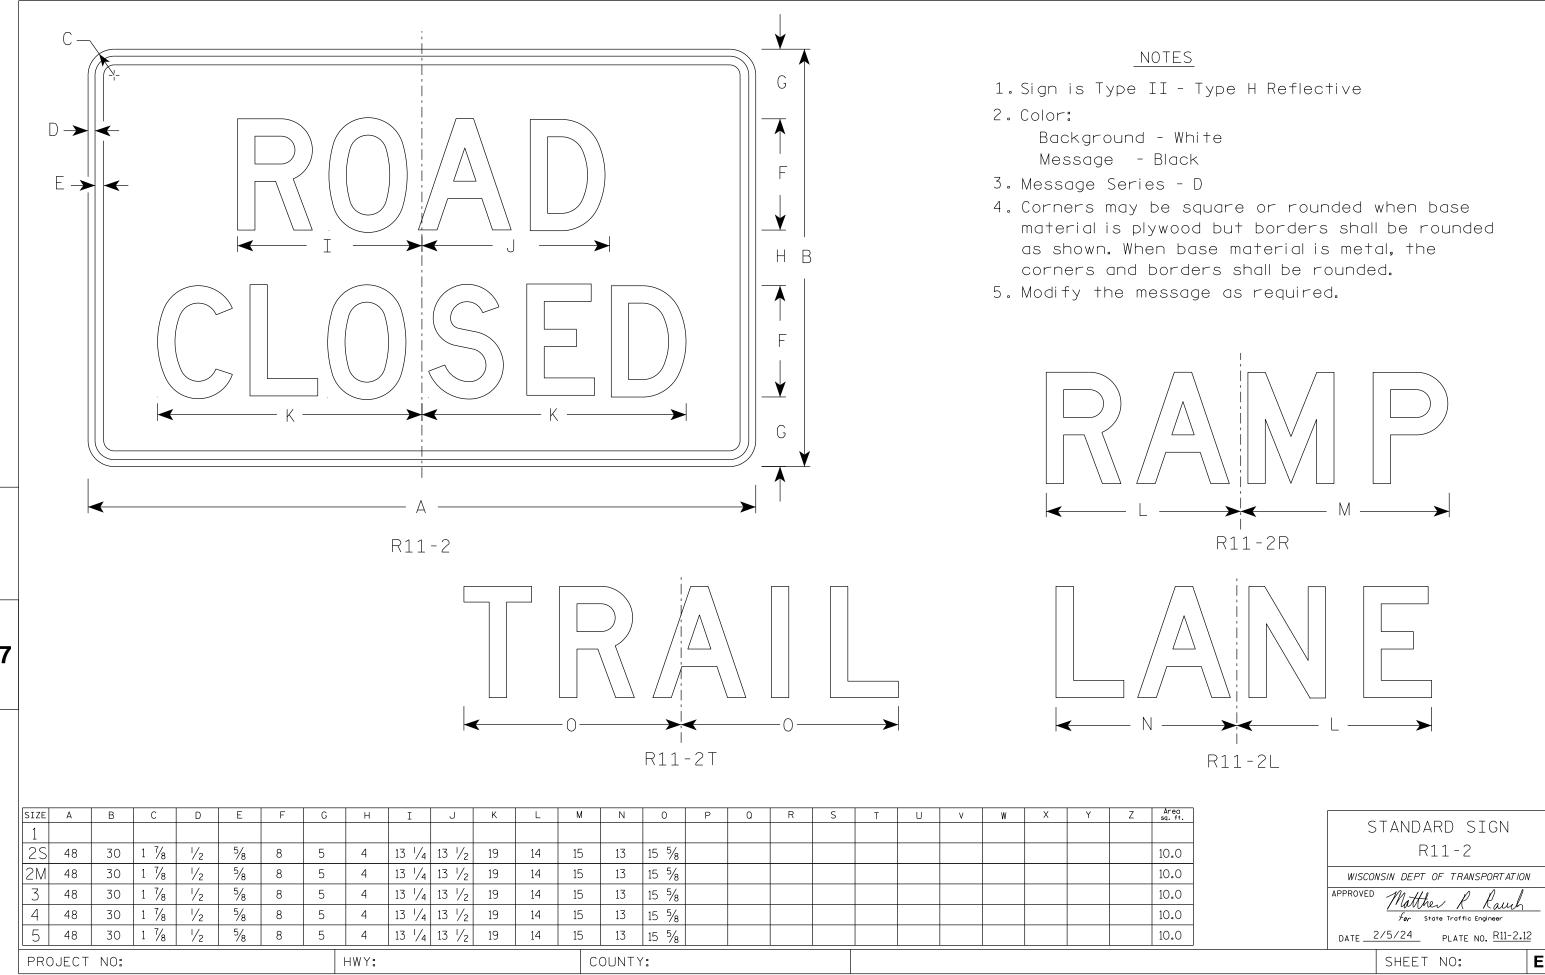

FILE NAME : C:\Users\PROJECTS\tr\_stdplate\R112.dgn

PLOT DATE: 5-FEB 2024 2:10

PLOT BY: mscj9h

PLOT NAME :

- 1. Sign is Type II Type H Reflective
- 2. Color:

Background - White Message - Black

- 3. Message Series C
- 4. Corners may be square or rounded when base material is plywood but borders shall be rounded as shown. When base material is metal, the corners and borders shall be rounded.



K11-2

SIZE	Α	В	С	D	E	F	G	Ι	I	J	K	L	М	N	0	Р	Q	R	S	Т	U	٧	W	X	Υ	Z	Area sq. ft.
1																											
25	60	30	1 1/8	1/2	5/8	6	5	4	2 1/2	16 1/8		7/8	23 3/8	3 1/4	3	16 3/4	5 1/4	2 1/4	24 1/4								12.5
2M	60	30	1 1/8	1/2	5/8	6	5	4	2 1/2	16 1/8		7/8	23 3/8	3 1/4	3	16 3/4	5 1/4	2 1/4	24 1/4								12.5
3																											
4																											
5																											

COUNTY:

STANDARD SIGN R11 - 4

WISCONSIN DEPT OF TRANSPORTATION

APPROVED

Matthew K Kaush For State Traffic Engineer

SHEET NO:

DATE 2/5/24

PLATE NO. R11-4.4

FILE NAME : C:\CAEfiles\Projects\tr\_stdplate\R114.dgn

HWY:

PROJECT NO:

PLOT DATE : 5-FEB 2024 2:54

PLOT BY: mscj9h

PLOT NAME: PLOT SCALE: \$\$.

PLOT SCALE: \$\$.....plotscale.....\$\$ WISDOT/CADDS SHEET 42

\_\_\_\_\_\_

7

- 1. Sign is Type II Type F Reflective
- 2. Color:

Background - Yellow Message - Black

F
A DE
W11-2

SIZE	Δ	В		П	F	l F	G	Гн	Т	T .1 T	K		М	l N	0	Р	Q	R	S	Т	Ιυ	l v	l w	l x	Y	7	Area sq. ft.
1	24		1 1/2	3/8	1/2	9 3/4		7 1/8	2 1/8	5 1/8	- , ,	_		,,,		<u>'</u>				'		•	- "	,,	·		4.0
25	30		1 7/8	1/2	5/8	12 1/8		9 7/8	3 1/2	6 3/8																	6.25
2M	36		2 1/4	5/8	3/4	14 1/2		11 7/8	4 1/4	7 5/8																	9.0
7	36		2 1/4	5/8	3/4	14 1/2		11 7/8		7 5/8																	9.0
	48		3	3/4	1	10 3/		15 3/4																			16.0
				/4	1	19 %		15 /4	J /8	10 /4																	10.0
PRC	JECT	NO:						HWY:					(	COUNT	Y:												

STANDARD SIGN

W11-2

WISCONSIN DEPT OF TRANSPORTATION

APPROVED Matthew K For State Traffic Engineer

DATE <u>6/15/2023</u>

PLATE NO. <u>W11-2.9</u>

SHEET NO:

PLOT DATE: 15-JUNE 2023 3:50

PLOT BY : dotc4c

PLOT NAME :

PLOT SCALE :


WISDOT/CADDS SHEET 42

FILE NAME : C:\CAEFiles\Projects\tr\_stdplate\W112.DGN

2. Color:

Background - Yellow Message - Black

3. W16-7R is the same as W16-7L except the arrow is reversed along the vertical centerline.

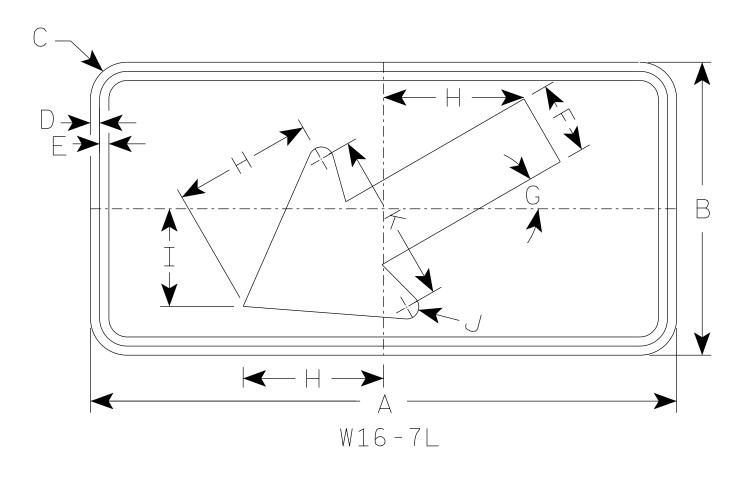

 $\star$  For 36"  $\times$  36" Warning Signs, use 30"  $\times$  18" W16-7L signs.

\* For 48" x 48" Warning Signs, use 48" x 24" W16-7L signs.

SIZE	Α .	В	С	D	E	F	G	Н	I	J	K	L	М	N	0	Р	Q	R	S	Т	U	٧	W	X	Y	Z	Area sq. ft.
1																											
25	24	12	1 1/2	3/8	3/8	3	30°	5 3/4	4	1/2	7																2.0
<del>*</del> 2M	30	18	1 1/2	3/8	1/2	4 1/2	30°	8 1/2	6	5/8	10 1/4																3.75
<del>*</del> 3	30	18	1 1/2	3/8	1/2	4 1/2	30°	8 1/2	6	5/8	10 1/4																3.75
<del>*</del> 4	48	24	1 7/8	1/2	5/8	6	30°	11 1/2	8	1	14																8.0
5																											

COUNTY:

STANDARD SIGN W16-7

WISCONSIN DEPT OF TRANSPORTATION

APPROVED Matther

For State Traffic Engineer

DATE 1/9/2024 PLATE NO. W16-7.9 SHEET NO:

FILE NAME : C:\CAEfiles\Projects\tr\_stdplate\W167.dgn

PROJECT NO:

HWY:

PLOT DATE: 9-Jan 2024 2:34

PLOT BY : dotc4c

PLOT NAME :


PLOT SCALE: \$\$.....plo†scale.....\$\$ WISDOT/CADDS SHEET 42


Ε


- 1. Sign is Type II Type F Reflective
- 2. Color:

Background - Orange Message - Black

- 3. Message Series C
- 4. Corners may be square or rounded when base material is plywood but borders shall be rounded as shown. When base material is metal, the corners and borders shall be rounded.

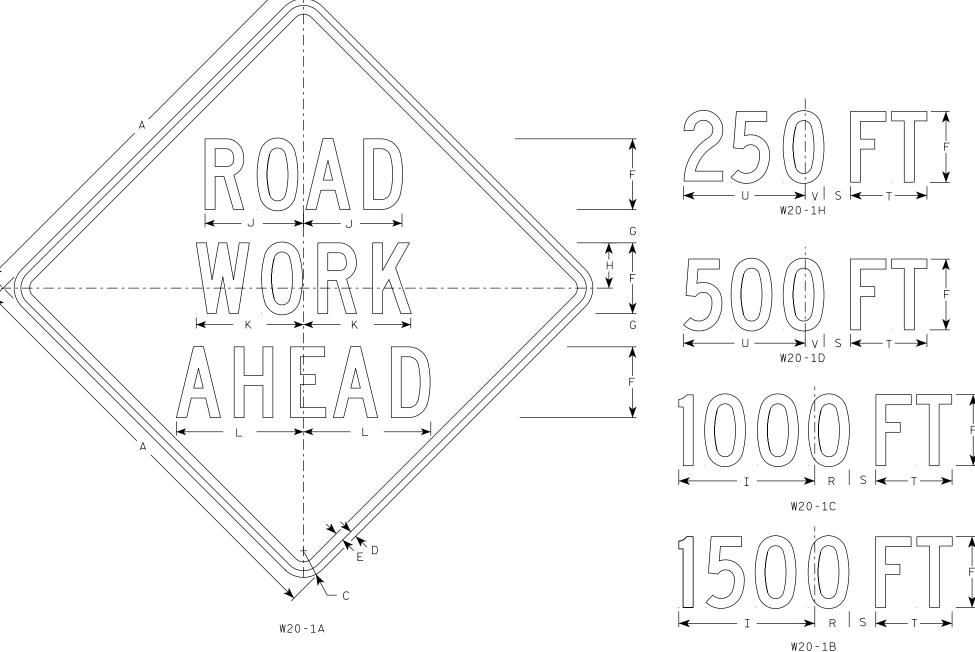

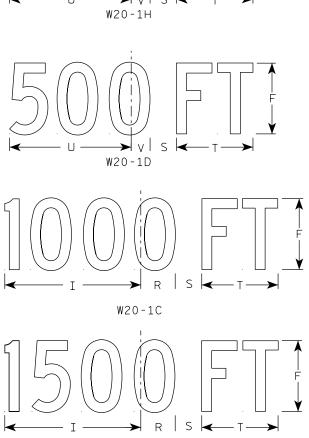

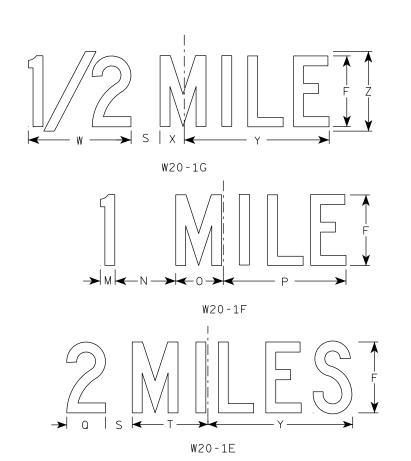

SIZE	Α	В	С	D	E	F	G	Н	I	J	K	L	М	N	0	Р	Q	R	S	Т	U	V	W	X	Y	Z	Area sq. ft.
1	36		2 1/4	5/8	3/4	5	2 5/8	3 1/4	10 1/8	7	7 5/8	8 1/8	1 1/8	4 1/2	3 1/2	9	3 1/4	2 1/2	2 1/4	5 %	9	1 3/8	8	1 3/4	10 3/4	6	9.0
25	48		3	3/4	1	8	3 3/4	5 1/8	15 3/8	11 1/8	12 1/8	14 3/8	1	6 1/8	5 3/8	13 1/8	4 3/8	3 1/8	3	8 5/8	13 ¾	2 1/8	11 1/8	2 3/4	16 3/8	9	16.0
2M	48		3	3/4	1	8	3 3/4	5 1/8	15 3/8	11 1/8	12 1/8	14 3/8	1	6 1/8	5 3/8	13 1/8	4 3/8	3 1/8	3	8 5/8	13 ¾	2 1/8	11 7/8	2 3/4	16 3/8	9	16.0
3	48		3	3/4	1	8	3 3/4	5 1/8	15 3/8	11 1/8	12 1/8	14 3/8	1	6 %	5 3/8	13 1/8	4 3/8	3 1/8	3	8 5/8	13 ¾	2 1/8	11 7/8	2 3/4	16 3/8	9	16.0
4	48		3	3/4	1	8	3 3/4	5 1/8	15 3/8	11 1/8	12 1/8	14 3/8	1	6 1/8	5 3/8	13 1/8	4 3/8	3 1/8	3	8 5/8	13 ¾	2 1/8	11 7/8	2 3/4	16 3/8	9	16.0
5	48		3	3/4	1	8	3 3/4	5 1/8	15 3/8	11 1/8	12 1/8	14 ¾	1 5/8	6 1/8	5 3/8	13 1/8	4 3/8	3 1/8	3	8 %	13 ¾	2 1/8	11 1/8	2 3/4	16 3/8	9	16.0

STANDARD SIGN W2O-1A, B, C, D, E, F, G & H

WISCONSIN DEPT OF TRANSPORTATION

APPROVED  $f_{\it or}$  State Traffic Engineer

DATE 1/10/2024 PLATE NO. W20-1.12

SHEET NO:

PROJECT NO:



- 1. Sign is Type II Type F Reflective
- 2. Color:

Background - Orange Message - Black

- 3. Message Series see note 5
- 4. Corners may be square or rounded when base material is plywood but borders shall be rounded as shown. When base material is metal, the corners and borders shall be rounded.
- 5. Lines 1 and 2 are Series D.
  Line 3 is Series D for AHEAD and
  Series C for all other distances.

1
W20-3D
$\begin{array}{c c} \hline  & & & \\ \hline $
W20-3B
W20-3G

W20-3A

HWY:

SIZE	А	В	С	D	Е	F	G	Н	I	J	K	L	М	N	0	Р	Q	R	S	Т	U	٧	W	Х	Y Z	Area sq. ft.
1	36		2 1/4	5/8	3/4	5	3 3/8	3 1/2	1 1/8	4	8 3/8	8 1/8	12 1/2	11	9	6	10 1/8	2 1/2	1 1/8	5 5/8	8	1 3/8	4 1/2	3 1/2	10 3/4 1 3/4	9.0
25	48		3	3/4	1	7	4 1/2	4 3/4	1 1/2	5 1/4	11 3/4	12 1/2	17 1/4	14 %	12	8	13 1/2	3 3/8	2 5/8	7 1/2	10 %	1 1/8	6	4 5/8	14 3/8 2 3/8	16.0
2M	48		3	3/4	1	7	4 1/2	4 3/4	1 1/2	5 1/4	11 3/4	12 1/2	17 1/4	14	12	8	13 1/2	3 3/8	2 5/8	7 1/2	10 %	1 1/8	6	4 5/8	14 3/8 2 3/8	16.0
3	48		3	3/4	1	7	4 1/2	4 3/4	1 1/2	5 1/4	11 3/4	12 1/2	17 1/4	14	12	8	13 1/2	3 3/8	2 5/8	7 1/2	10 5/8	1 1/8	6	4 5/8	14 3/8 2 3/8	16.0
4	48		3	3/4	1	7	4 1/2	4 3/4	1 1/2	5 1/4	11 3/4	12 1/2	17 1/4	14	12	8	13 1/2	3 3/8	2 5/8	7 1/2	10 %	1 1/8	6	4 5/8	14 3/8 2 3/8	16.0
5	48		3	3/4	1	7	4 1/2	4 3/4	1 1/2	5 1/4	11 3/4	12 1/2	17 1/4	14	12	8	13 1/2	3 3/8	2 5/8	7 1/2	10 5/8	1 1/8	6	4 5/8	14 3/8 2 3/8	16.0

STANDARD SIGN W20-3A, B, C, D, F & G

WISCONSIN DEPT OF TRANSPORTATION

For State Traffic Engineer

DATE 1/10/2024 PLATE NO. W20-3.8

SHEET NO:

HEET NO:

FILE NAME : C:\CAEfiles\Projects\tr\_stdplate\W203.DGN

PROJECT NO:

COUNTY: PLOT DATE: 10-JAN 2024 12:02


PLOT BY : dotc4c


PLOT NAME :

- 1. Sign is Type II Type F Reflective
- 2. Color:

Background - Orange Message - Black

- 3. Message Series See Note 5
- 4. Corners may be square or rounded when base material is plywood but borders shall be rounded as shown. When base material is metal, the corners and borders shall be rounded.
- 5. " \_\_\_\_ LANE" is Series B. All other copy is Series C.

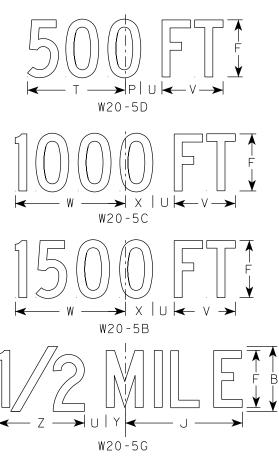

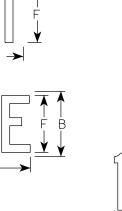

→   Q   ← R →   ← S →   ← T →
W20-5E

W20-5F

SIZE	А	В	С	D	E	F	G	Н	I	J	K	L	М	N	0	Р	Q	R	S	Т	U	٧	W	X	Y	Z	Area sq. ft.
1	36	6	2 1/4	5/8	3/4	5	7/8	2 1/2	13 1/8	10 3/4	9 1/2	14 1/4	13 5/8	12	12	1 3/8	1 1/8	4 1/2	3 1/2	9	1 1/8	5 5/8	10 1/8	2 1/2	1 3/4	8	9.0
25	48	8	3	3/4	1	7	1 1/4	3 1/4	17 1/2	14 3/8	12 5/8	19	18 3/8	16	14 1/4	1 1/8	1 1/2	6	4 5/8	12	2 5/8	7 1/2	13 1/2	3 3/8	2 3/8	10 5/8	16.0
2M	48	8	3	3/4	1	7	1 1/4	3 1/4	17 1/2	14 3/8	12 5/8	19	18 3/8	16	14 1/4	1 1/8	1 1/2	6	4 5/8	12	2 5/8	7 1/2	13 1/2	3 3/8	2 3/8	10	16.0
3	48	8	3	3/4	1	7	1 1/4	3 1/4	17 1/2	14 3/8	12 5/8	19	18 3/8	16	14 1/4	1 1/8	1 1/2	6	4 5/8	12	2 5/8	7 1/2	13 1/2	3 3/8	2 3/8	10 5/8	16.0
4	48	8	3	3/4	1	7	1 1/4	3 1/4	17 1/2	14 3/8	12 5/8	19	18 3/8	16	14 1/4	1 1/8	1 1/2	6	4 5/8	12	2 5/8	7 1/2	13 1/2	3 3/8	2 3/8	10 5/8	16.0
5	48	8	3	3/4	1	7	1 1/4	3 1/4	17 1/2	14 3/8	12 5/8	19	18 3/8	16	14 1/4	1 1/8	1 1/2	6	4 5/8	12	2 5/8	7 1/2	13 1/2	3 3/8	2 3/8	10	16.0

COUNTY:

W20-5A

HWY:

STANDARD SIGN W20-5A, B, C, D, F & G

WISCONSIN DEPT OF TRANSPORTATION

For State Traffic Engineer

DATE 3/27/24 PLATE NO. <u>W20-5.12</u>

> Ε SHEET NO:

FILE NAME: C:\CAEfiles\Projects\tr\_stdplate\W205.dgn

PROJECT NO:

W20-56A

W20-55A

PLOT DATE: 27-MAR 2024 4:01

PLOT BY: mscj9h

PLOT NAME :

- 1. Sign is Type II Type F Reflective
- 2. Color:

Background - Orange Message - Black

- 3. Corners may be square or rounded when base material is plywood but borders shall be rounded as shown. When base material is metal, the corners and borders shall be rounded.
- 4. W04-2L is the same as W04-2R except the symbolis reversed along the vertical centerline.

	DE
A   ← G →	→ I I ← G → I
Α, \\\	F G →
K-K-	C C

W04-2R

SIZE	Α	В	С	D	E	F	G	Н	I	J	K	L	М	Ν	0	Р	Q	R	S	Т	U	٧	W	X	Υ	Z	Area sq. ft.
1	36		2 1/4	5/8	3/4	12	4	45°	1	1 3/4	5	3	1 1/2														9.0
25	48		3	3/4	1	16	5 3/8	45°	1 1/4	2 3/8	6 3/4	4	2														16.0
2M	48		3	3/4	1	16	5 3/8	45°	1 1/4	2 3/8	6 3/4	4	2														16.0
3	48		3	3/4	1	16	5 3/8	45°	1 1/4	2 3/8	6 3/4	4	2														16.0
4	48		3	3/4	1	16	5 3/8	45°	1 1/4	2 3/8	6 3/4	4	2														16.0
5	48		3	3/4	1	16	5 3/8	45°	1 1/4	2 3/8	6 3/4	4	2														16.0

STANDARD SIGN W04-2

WISCONSIN DEPT OF TRANSPORTATION

APPROVED

 $\frac{f_{or}}{f_{or}}$  State Traffic Engineer

DATE 1/25/2024 PLATE NO. WO4-2.2

SHEET NO:

FILE NAME : C:\Users\PROJECTS\tr\_stdplate\W042.dgn

PROJECT NO:

PLOT DATE: 25-JAN 2024 9:07

PLOT BY : dotc4c

WISDOT/CADDS SHEET 42



# Wisconsin Department of Transportation

Dedicated people creating transportation solutions through innovation and exceptional service.

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